

Commercial/Industrial Floodplain Development Permit

Doddridge County, WV Floodplain Management

This permit has been issued to EQT PRODUCTION CO. , and is for the approved commercial and/or industrial development project associated with this permit that impacts the FEMA-designated floodplain and/or floodway of Doddridge County, WV, pursuant to the rules and regulations established by all applicable Federal, State and local laws and ordinances, including the Doddridge County Floodplain Ordinance. This permit must be posted at the site of work as to be clearly visible, and must remain posted during entirety of development.

Permit: #14-192

Date Approved: 05/21/2014

Expires: 05/21/2015

Issued to: EQT PRODUCTION COMPANY

**POC: MEGAN LANDFRIED
304-848-0061**

**Company Address: 115 PROFESSIONAL PLACE
BRIDGEPORT, WV 26330**

Project Address: ARNOLDS CREEK LEFT FORK

Firm: 54017C0120C

Lat/Long:

Purpose of development: WATER LINE

Issued by: Edwin L. "Bo" Wriston, Doddridge County FPM (or designee)

Date: 05/21/2014

For additional information regarding this permit, please contact
Doddridge County Floodplain Manager at 304.873.2631, or via email at
doddridgecountyfpm@gmail.com
118 East Court Street; West Union, WV 26456


7013 2250 0001 6914 8605

U.S. Postal Service™
CERTIFIED MAIL™ RECEIPT
(Domestic Mail Only; No Insurance Coverage Provided)

For delivery information visit our website at www.usps.com®

OFFICIAL USE

| | | |
|---|----|------|
| Postage | \$ | .48 |
| Certified Fee | | 3.30 |
| Return Receipt Fee (Endorsement Required) | | 2.70 |
| Restricted Delivery Fee (Endorsement Required) | | |
| Total Postage & Fees | \$ | 6.48 |

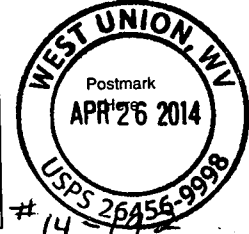

Sent To *Eleanor Maxwell Myers*
Olivia Meyer
 Street, Apt. No.,
 or PO Box No. *62 1st Place Apt 4*
 City, State, ZIP+4 *Brooklyn, WV 11231*

SENDER: COMPLETE THIS SECTION

- Complete items 1, 2, and 3. Also complete item 4 if Restricted Delivery is desired.
- Print your name and address on the reverse so that we can return the card to you.
- Attach this card to the back of the mailpiece, or on the front if space permits.

1. Article Addressed to: # 14-192
 Eleanor Maxwell Meyer
 c/o Lisa Meyer
 62 1st Place Apt 4
 Brooklyn, NY 11231

2. Article No.
 (Transfer)

PS Form 38

COMPLETE THIS SECTION ON DELIVERY

A. Signature

X


- Agent
 Addressee

B. Received by (Printed Name)

C. Date of Delivery

4/29/14

D. Is delivery address different from item 1? Yes
 If YES, enter delivery address below: No

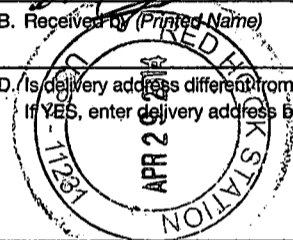

3. Service Type™

- Certified Mail® Priority Mail Express™
 Registered Return Receipt for Merchandise
 Insured Mail Collect on Delivery

4. Restricted Delivery? (Extra Fee) Yes

UNITED STATES POSTAL SERVICE

First-Class Mail
Postage & Fees Paid
USPS
Permit No. G-10

• Sender: Please print your name, address, and ZIP+4® in this box •

FILED

2014 MAY -9 AM 9:58

**DETHMERS
COUNTY CLERK
BRIDGE COUNTY WV**

Wriston
Bridgeway Floodplain MGT
111 East Court St., Suite 102
West Union, WV 26456

05/06

Doddridge County, West Virginia

RECEIPT NO: 2017

DATE: 2014/04/25

FROM: POTESTA & ASSOCIATES

AMOUNT: \$ 500.00

FIVE HUNDRED DOLLARS AND 00 CENTS

FOR: #14-192 EQT PRODUCTION WEU -8 WATER LINE

00000012301 FP-BUILDING PERMITS

020-318

TOTAL: \$500.00

MICHAEL HEADLEY

SHERIFF & TREASURER

MEC

CLERK

Customer Copy

Legal Advertisement:
Doddridge County
Floodplain Permit Application

Please take notice that on the 24th day of April, 2014

EQT PRODUCTION COMPANY #14-192

filed an

application for a Floodplain Permit to develop land located at or
about: **SURFACE OWNERS: ELEANOR MAXWELL MEYER , WEST
UNION DISTRICT, ARNOLDS CREEK AREA, WILL BOOK 10 PG 526**

The Application is on file with the Clerk of the County Court and
may be inspected or copied during regular business hours.

Any interested persons who desire to comment shall present
the same in writing by **May 14, 2014.**

Delivered to the:
Clerk of the County Court
118 E. Court Street, West Union, WV 26456.

Beth A Rogers, Doddridge County Clerk
Edwin L. "Bo" Wriston. Doddridge County Flood Plain Manager

* P. 01 *
* TRANSACTION REPORT *
* APR-25-2014 FRI 04:16 PM *
* FOR: DODDRIDGE CO. CLERK 304 873 1840 *

SEND

| DATE | START | RECEIVER | TX TIME | PAGES | TYPE | NOTE | M# | DP |
|---------|----------|------------|---------|-------|--------|------------|-----|----|
| APR-25 | 04:15 PM | 3048731600 | 51" | 3 | FAX TX | OK | 985 | |
| TOTAL : | | | | | | 51S PAGES: | 3 | |

Legal Advertisement:

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Edwin L. "Bo" Wriston, Doddridge County Flood Plain Manager



Edwin L. "Bo" Wriston, Floodplain Manager
Doddridge County Commission
118 East Court Street
West Union, WV 26456

July 8, 2014

RE: EQT Production Company
WEU 8 Water Line
Permit No. 14-192

Mr. Wriston,

Pursuant to the requirements of the Doddridge County Floodplain Ordinance, EQT Production Company is submitting this letter to report the status of permits necessary for the WEU 8 Water Line Project located near Arnolds Creek, Doddridge County, WV. The WEU 8 Water line consisted of a temporary surface plastic line. Due to the nature of this Project, earth disturbance was not more than one acre. A permit from the West Virginia Department of Environmental Protection was not required. Also, due to the temporary surface nature of the water line, no stream or wetland impacts were anticipated and permits were not necessary from the United States Army Corps of Engineers, the West Virginia Department of Environmental Protection, or the West Virginia Department of Natural Resources.

Please feel free to contact me at 304-848-0061 or at mlandfried@eqt.com should you have any questions or comments.

Sincerely,

A handwritten signature in black ink that reads "Megan E. Landfried" followed by the date "7/8/14".

Megan E. Landfried



Engineers and Environmental Consultants

7012 MacCorkle Avenue, SE, Charleston, WV 25304 • (304)342-1400 • FAX (304)343-9031; www.potesta.com

#14-192
EQT Production
WEU-8 Water Line

April 16, 2014

Doddridge County Floodplain Coordinator
Doddridge County Commission
118 East Court Street
West Union, West Virginia 26456

RE: Floodplain Permit Application
EQT Production Company
EQT WEU 8 Water Line
Doddridge County, West Virginia
POTESTA Project No. 0101-11-0147-803

FILED
2014 APR 17 AM 9:04
BETH A. ROGERS
COUNTY CLERK
DODDRIDGE COUNTY, WV

Dear Sir/Madam:

Potesta & Associates, Inc. (POTESTA) is pleased to submit this cover letter with the associated Floodplain Development Permit Application for the proposed WEU 8 Water Line Project. The proposed project will consist of installing approximately 3,854 linear feet of temporary aboveground water line. Based on information presented on the site FIRM, a portion of the project is located within FEMA Flood Zone A from approximate water line stations 11+50 to 16+50, shown on the attached Drawing Nos. 3 and 4. No earth disturbance activities will be associated with the installation of this water line. Flood Zone A is the regulatory floodplain associated with the Base Flood (1 percent annual chance flood event), commonly referred to as the 100-year floodplain and indicates that the limits of the floodplain are approximate; as such, Base Flood Elevations (BFEs) have not been previously established by FEMA. Work within the floodplain associated with this project shall include the installation of a temporary aboveground water line which will be properly anchored using 2-inch by 2-inch wooden stakes at stream and floodplain crossings to prevent the water line from washing downstream during high water storm events. All work associated with the proposed WEU 8 Water Line within the limits of the floodplain will be in accordance with the following. No permanent aboveground structures are to be constructed within the floodplain. There will be no excess or fill material associated with this project because there will be no excavation proposed for the project.

Included with this permit application are floodplain map, site plan sheets, and miscellaneous detail sheets for this project.

April 16, 2014
Page 2

If you have any questions, please feel free to contact me at (304) 342-1400 or jmsmith@potesta.com, or Megan Landfried (EQT) at (304) 848-0061.

Sincerely,

POTESTA & ASSOCIATES, INC.



Jarrett M. Smith, P.E.
Senior Engineer

JMS:JWS/clr

Enclosures

c: Ms. Megan Landfried – EQT (via email)



FILED

2014 APR 17 AM 9:04

WELL 8
Waterline

BETH A. ROGERS
COUNTY CLERK
DODDRIDGE COUNTY, WV

DODDRIDGE COUNTY

FLOODPLAIN DEVELOPMENT PERMIT APPLICATION

SECTION 1: GENERAL PROVISIONS (APPLICANT TO READ AND SIGN)

1. No work may start until a permit is issued.
2. The permit may be revoked if any false statements are made herein.
3. If revoked, all work must cease until permit is re-issued.
4. Development shall not be used or occupied until a Certificate of Compliance is issued.
5. The permit will expire if no work is commenced within six months of issuance.
6. Applicant is hereby informed that other permits may be required to fulfill local, state, and federal requirements.
7. Applicant hereby gives consent to the Floodplain Administrator/Manager or his/her representative to make inspections to verify compliance.
8. **I, THE APPLICANT CERTIFY THAT ALL STATEMENTS HEREIN AND IN ATTACHMENTS TO THIS APPLICATION ARE, TO THE BEST OF MY KNOWLEDGE, TRUE AND ACCURATE.**

APPLICANT'S SIGNATURE Megan E Janoff

DATE 4/11/14

SECTION 2: PROPOSE DEVELOPMENT (TO BE COMPLETED BY APPLICANT).

IF THE APPLICANT IS NOT A NATURAL PERSON, THE NAME, ADDRESS, AND TELEPHONE NUMBER OF A NATURAL PERSON WHO SHALL BE APPOINTED BY THE APPLICANT TO RECEIVE NOTICE PURSUANT TO ANY PROVISION OF THE CURRENT DODDRIDGE COUNTY FLOODPLAIN ORDINANCE.

**APPLICANT'S NAME: EQT Production Company
ADDRESS: 115 Professional Place, Bridgeport, WV 26330
TELEPHONE NUMBER: 304-848-0061**

BUILDER'S NAME: EQT Production Company

ADDRESS: 115 Professional Place

TELEPHONE NUMBER: 304-848-0061

ENGINEER'S NAME: POTESTA and Associates

ADDRESS: 7012 MacCorkle Avenue, SE , Charleston, West Virginia 25304

TELEPHONE NUMBER: 304-342-1400

PROJECT LOCATION: *Eleanor Maxwell Meyer*
19 Heath Place
Garden City, NY 11530

NAME OF SURFACE OWNER/OWNERS (IF NOT THE APPLICANT): *Eleanor Maxwell Meyer*
c/o Lisa Meyer

ADDRESS OF SURFACE OWNER/OWNERS (IF NOT THE APPLICANT): *62 1st Place Apt 4*
Brooklyn, NY 11231

DISTRICT: *West Union*

DATE/FROM WHOM PROPERTY PURCHASED: *8/25/1965*

LAND BOOK DESCRIPTION: *Will Book*

DEED BOOK REFERENCE: *Will Book 10/526*

TAX MAP REFERENCE:

EXISTING BUILDINGS/USES OF PROPERTY: *Farm*

NAME OF AT LEAST ONE ADULT RESIDING IN EACH RESIDENCE LOCATED UPON THE SUBJECT PROPERTY: *Vacant*

ADDRESS OF AT LEAST ONE ADULT RESIDING IN EACH RESIDENCE LOCATED UPON THE SUBJECT PROPERTY:

To avoid delay in processing the application, please provide enough information to easily identify the project location.

DESCRIPTION OF WORK (CHECK ALL APPLICABLE BOXES)

A. STRUCTURAL DEVELOPMENT

| <u>ACTIVITY</u> | <u>STRUCTURAL TYPE</u> |
|---|---|
| <input checked="" type="checkbox"/> New Structure | <input type="checkbox"/> Residential (1 – 4 Family) |
| <input type="checkbox"/> Addition | <input type="checkbox"/> Residential (more than 4 Family) |
| <input type="checkbox"/> Alteration | <input checked="" type="checkbox"/> Non-residential (floodproofing) |
| <input type="checkbox"/> Relocation | <input type="checkbox"/> Combined Use (res. & com.) |
| <input type="checkbox"/> Demolition | <input type="checkbox"/> Replacement |
| <input type="checkbox"/> Manufactured/Mobil Home | |

B. OTHER DEVELOPMENT ACTIVITIES:

- Fill Mining Drilling Pipelining
- Grading
- Excavation (except for STRUCTURAL DEVELOPMENT checked above)
- Watercourse Altercation (including dredging and channel modification)
- Drainage Improvements (including culvert work)
- Road, Street, or Bridge Construction
- Subdivision (including new expansion)
- Individual Water or Sewer System
- Other (please specify)
_____ Temporary water line

C. STANDARD SITE PLAN OR SKETCH

- 1. SUBMIT ALL STANDARD SITE PLANS, IF ANY HAVE BEEN PREPARED.**
- 2. IF STANDARD SITE PLANS HAVE NOT BEEN PREPARED:**
SKETCH ON A SEPARATE 8 ½ X 11 INCH SHEET OF PAPER THE SHAPE AND LOCATION OF THE LOT. SHOW THE LOCATION OF THE INTENDED CONSTRUCTION OR LAND USE INDICATING BUILDING SETBACKS, SIZE & HEIGHT. IDENTIFY EXISTING BUILDINGS, STRUCTURES OR LAND USES ON THE PROPERTY.
- 3. SIGN AND DATE THE SKETCH.**

ACTUAL TOTAL CONSTRUCTION COSTS OF THE COMPLETE DEVELOPMENT
IRRESPECTIVE OF WHETHER ALL OR ANY PART OF THE SUBJECT PROPOSED
CONSTRUCTION PROJECT IS WITHIN THE FLOODPLAIN \$9629 rental fee
\$43,561 for the move in, set up, and demobilization of the lines
including labor
Total= \$53,190

D. ADJACENT AND/OR AFFECTED LANDOWNERS:

1. NAME AND ADDRESS OF ALL OWNERS OF SURFACE TRACTS ADJACENT TO THE AREA OF THE SURFACE TRACT (UP & DOWN STREAM) UPON WHICH THE PROPOSED ACTIVITY WILL OCCUR AND ALL OTHER SURFACE OWNERS UP & DOWN STREAM) WHO OWN PROPERTY THAT MAY BE AFFECTED BY FLOODING AS IS DEMONSTRATED BY A FLOODPLAIN STUDY OR SURVEY (IF ONE HAS BEEN COMPLETED).

NAME: Eleanor MANKIN C/O NAME: LISA Meyer
ADDRESS: 19 HEATH PLACE ADDRESS: 02062 1st Place Apt #4
Garden City, NY 11530 Brooklyn, NY 11231

NAME: _____ NAME: _____
ADDRESS: _____ ADDRESS: _____

NAME: _____ NAME: _____
ADDRESS: _____ ADDRESS: _____

NAME: _____ NAME: _____
ADDRESS: _____ ADDRESS: _____

NAME: _____ NAME: _____
ADDRESS: _____ ADDRESS: _____

1. NAME AND ADDRESS OF AT LEAST ONE ADULT RESIDING IN EACH RESIDENCE LOCATED UPON ANY ADJACENT PROPERTY AT THE TIME THE FLOODPLAIN PERMIT APPLICATION IS FILED AND THE NAME AND ADDRESS OF AT LEAST ONE ADULT RESIDING IN ANY HOME ON ANY PROPERTY THAT MAY BE AFFECTED BY FLOODING AS IS DEMONSTRATED BY A FLOODPLAIN STUDY OR SURVEY.

| | |
|---------------------|----------------|
| NAME: <u>Vacant</u> | NAME: _____ |
| ADDRESS: _____ | ADDRESS: _____ |
| _____ | _____ |
| NAME: _____ | NAME: _____ |
| ADDRESS: _____ | ADDRESS: _____ |
| _____ | _____ |

E. CONFIRMATION FORM

THE APPLICANT ACKNOWLEDGES, AGREES, AND CONFIRMS THAT HE/IT WILL PAY WITHIN 30 DAYS OF RECEIPT OF INVOICE BY THE COUNTY FOR ALL EXPENSES RELATIVE TO THE PERMIT APPLICATION PROCESS GREATER THAN THE REQUIRED DEPOSIT FOR EXPENSES INCLUDING:

- (A) PERSONAL SERVICE OF PROCESS BY THE DODDRIDGE COUNTY SHERIFF AT THE RATES PERMITTED BY LAW FOR SUCH SERVICE.
- (B) SERVICE BY CERTIFIED MAIL RETURN RECEIPT REQUESTED.
- (C) PUBLICATION.
- (D) COURT REPORTING SERVICES AT ANY HEARINGS REQUESTED BY THE APPLICANT.
- (E) CONSULTANTS AND/OR HEARING EXPERTS UTILIZED BY DODDRIDGE COUNTY FLOODPLAIN ADMINISTRATOR/MANAGER OR FLOODPLAIN APPEALS BOARD FOR REVIEW OF MATERIALS AND/OR TESTIMONY REGARDING THE EFFICACY OF GRANTING OR DENYING THE APPLICANT'S FLOODPLAIN PERMIT.

NAME (PRINT): Megan E. Landfried

SIGNATURE: Megan E. Landfried DATE: 4/11/14

After completing SECTION 2, APPLICANT should submit form to Floodplain Administrator/Manager or his/her representative for review.

SECTION 3: FLOODPLAIN DETERMINATION (to be completed by Floodplain Administrator/Manager or his/her representative)

THE PROPOSED DEVELOPMENT:

THE PROPOSED DEVELOPMENT IS LOCATED ON:

FIRM Panel: _____

Dated: _____

Is **NOT** located in a Specific Flood Hazard Area (Notify applicant that the application review is complete and **NO FLOODPLAIN DEVELOPMENT PERMIT IS REQUIRED**).

Is located in Special Flood Hazard Area.
FIRM zone designation _____
100-Year flood elevation is: _____ NGVD (MSL)

Unavailable

The proposed development is located in a floodway.
FBFM Panel No. _____ Dated _____

See section 4 for additional instructions.

SIGNED _____ **DATE** _____

SECTION 4: ADDITIONAL INFORMATION REQUIRED (To be completed by Floodplain Administrator/Manager or his/her representative)

The applicant must submit the documents checked below before the application can be processed.

A plan showing the location of all existing structures, water bodies, adjacent roads, lot dimensions and proposed development.

- Development plans, drawn to scale, and specifications, including where applicable: details for anchoring structures, storage tanks, proposed elevation of lowest floor, (including basement or crawl space), types of water resistant materials used below the first floor, details of flood proffing of utilities located below the first floor and details of enclosures below the first floor. Also _____

- Subdivision or other development plans (If the subdivision or development exceeds 50 lots or 5 acres, whichever is the lesser, the applicant must provide 100-year flood elevations if they are not otherwise available).
- Plans showing the extent of watercourse relocation and/or landform alterations.
- Top of new fill elevation _____ Ft. NGVD (MSL).
For floodproofing structures applicant must attach certification from registered engineer or architect.
- Certification from a registered engineer that the proposed activity in a regulatory floodway will not result in any increase in the height of the 100-year flood. A copy of all data and calculations supporting this finding must also be submitted.
- Manufactured homes located in a floodplain area must have a West Virginia Contractor's License and a Manufactured Home Installation License as required by the Federal Emergency Management Agency (FEMA).
- Other:

SECTION 5: PERMIT DETERMINATION (To be completed by Floodplain Administrator/Manager or his/her representative)

I have determined that the proposed activity (type is or is not) in conformance with provisions of the Floodplain Ordinance adopted by the County Commission of Doddridge

County on May 21, 2013. The permit is issued subject to the conditions attached to and made part of this permit.

SIGNED _____ DATE _____

If the Floodplain Administrator/Manager found that the above was not in conformance with the provisions of the Doddridge County Floodplain Ordinance and/or denied that application, the applicant may complete an appealing process below.

APPEALS: Appealed to the County Commission of Doddridge County? Yes No
Hearing Date: _____
County Commission Decision - Approved Yes No

CONDITIONS: _____

SECTION 6: AS-BUILT ELEVATIONS (To be submitted by APPLICANT before Certificate of Compliance is issued).

The following information must be provided for project structures. This section must be completed by a registered professional engineer or a licensed land surveyor (or attach a certification to this application).

COMPLETE 1 OR 2 BELOW:

- 1 Actual (As-Built) Elevation of the top of the lowest floor (including basement or crawl space is _____ FT. NGVD (MSL)
- 2 Actual (As Built) elevation of floodproofing is _____ FT. NGVD (MSL)

Note: Any work performed prior to submittal of the above information is at risk of the applicant.

SECTION 7: COMPLIANCE ACTION (To be completed by the Floodplain Administrator/Manager or his/her representative).

The Floodplain Administrator/Manager or his/her representative will complete this section as applicable based on inspection of the project to ensure compliance with the Doddridge County Floodplain Ordinance.

INSPECTIONS:

DATE: _____ BY: _____
DEFICIENCIES ? Y/N

COMMENTS _____

SECTION 8: CERTIFICATE OF COMPLIANCE (To be completed by Floodplain Administrator/Manager or his/her representative).

Certificate of Compliance issued: DATE: _____ BY: _____

**CERTIFICATE OF COMPLIANCE
FOR DEVELOPMENT IN SPECIAL FLOOD HAZARD AREA
(OWNER MUST RETAIN)**

PERMIT NUMBER: _____

PERMIT DATE: _____

PURPOSE –

CONSTRUCTION LOCATION: _____

OWNER'S ADDRESS: _____

**THE FOLLOWING MUST BE COMPLETED BY THE FLOODPLAIN
ADMINISTRATOR/MANAGER OR HIS/HER AGENT.**

**COMPLIANCE IS HEREBY CERTIFIED WITH THE REQUIREMENT OF THE
FLOODPLAIN ORDINANCE ADOPTED BY THE COUNTY COMMISSION OF
DODDRIDGE COUNTY ON MAY 21, 2013.**

SIGNED _____ **DATE** _____

DATE: 01/17/2014
 TIME: 11:00 AM
 USER: JMS
 PROJECT: POTESTA & ASSOCIATES, INC.
 DRAWING: EQT WEUB WATERLINE



| No. | Date | Revision |
|-----|------|----------|
| | | |
| | | |
| | | |

-DESIGN
 CAD File No.
 JM
 Drawn
 JWS
 Checked
 JMS
 Approved
 1" = 200'
 Scale:
 FEB 2014
 Date:
 11-0147-803
 Project No.

POTESTA & ASSOCIATES, INC.
 ENGINEERS AND ENVIRONMENTAL CONSULTANTS
 7012 MacCortle Ave. SE, Charleston, WV 25304
 TEL: (804) 342-1400 FAX: (804) 342-8031
 E-Mail Address: potesta@potesta.com



ISSUE DATE 2/5/2014


Client
 EQT PRODUCTION COMPANY
 115 PROFESSIONAL PLACE
 BRIDGEPORT, WEST VIRGINIA

Title
 OVERALL LAYOUT
 EQT WEUB WATERLINE
 EROSION & SEDIMENT CONTROL PLAN
 DODDRIDGE COUNTY, WEST VIRGINIA

Drawing No. **2**



MAPPING REFERENCE:
 BASE TOPOGRAPHIC MAPPING TAKEN FROM WYGIS S&MB AERIAL MAPPING, DATED 2003.

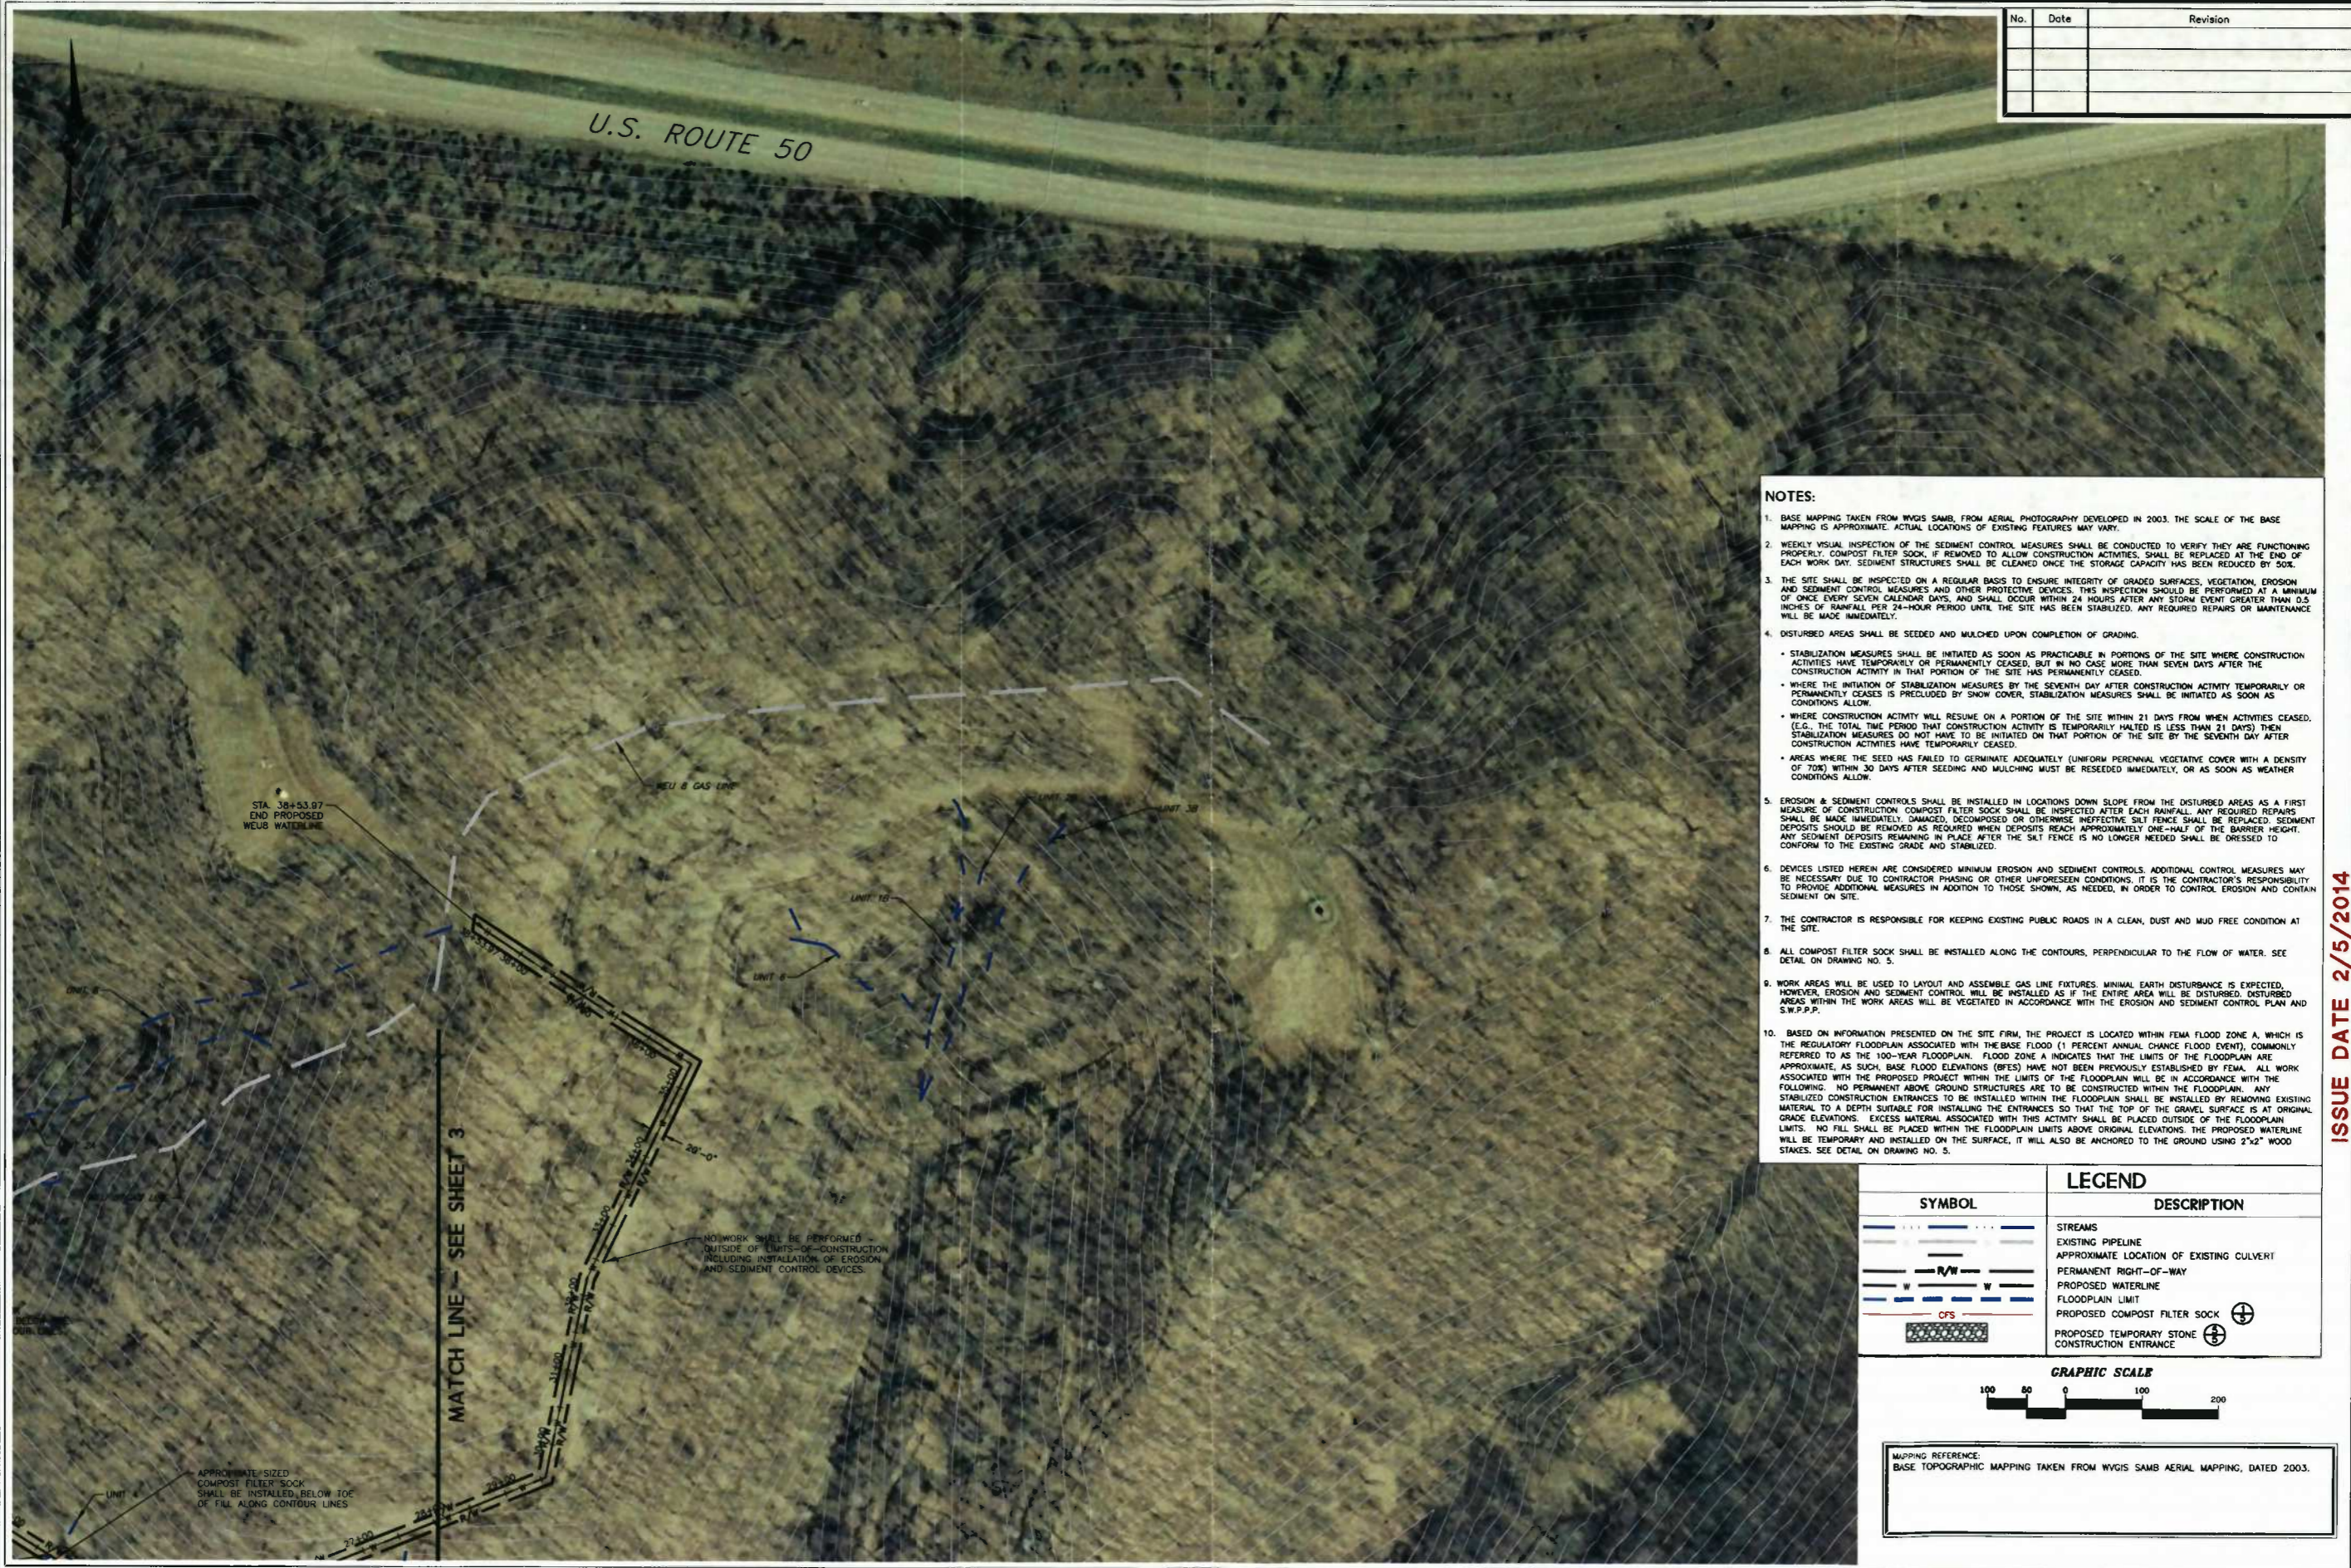

| No. | Date | Revision |
|-----|------|----------|
| | | |
| | | |
| | | |

-DESIGN
 CAD File No.
 JM
 Drawn
 JWS
 Checked
 JMS
 Approved
 1" = 100'
 Scale:
 FEB 2014
 Date:
 11-0147-803
 Project No.

POTESTA & ASSOCIATES, INC.
 ENGINEERS AND ENVIRONMENTAL CONSULTANTS
 7012 Macomber Ave. SE, Charleston, WV 25304
 TEL: (804) 342-1400 FAX: (804) 343-8031
 E-Mail Address: potesta@potesta.com



Client:
EQT PRODUCTION COMPANY
 115 PROFESSIONAL PLACE
 BRIDGEPORT, WEST VIRGINIA


Title:
SITE PLAN
EQT WEUB WATERLINE
EROSION & SEDIMENT CONTROL PLAN
 DODDRIDGE COUNTY, WEST VIRGINIA

Drawing No. **4**

NOTES:

- BASE MAPPING TAKEN FROM WVGIS SAMS, FROM AERIAL PHOTOGRAPHY DEVELOPED IN 2003. THE SCALE OF THE BASE MAPPING IS APPROXIMATE. ACTUAL LOCATIONS OF EXISTING FEATURES MAY VARY.
- WEEKLY VISUAL INSPECTION OF THE SEDIMENT CONTROL MEASURES SHALL BE CONDUCTED TO VERIFY THEY ARE FUNCTIONING PROPERLY. COMPOST FILTER SOCK, IF REMOVED TO ALLOW CONSTRUCTION ACTIVITIES, SHALL BE REPLACED AT THE END OF EACH WORK DAY. SEDIMENT STRUCTURES SHALL BE CLEARED ONCE THE STORAGE CAPACITY HAS BEEN REDUCED BY 50%.
- THE SITE SHALL BE INSPECTED ON A REGULAR BASIS TO ENSURE INTEGRITY OF GRADED SURFACES, VEGETATION, EROSION AND SEDIMENT CONTROL MEASURES AND OTHER PROTECTIVE DEVICES. THIS INSPECTION SHOULD BE PERFORMED AT A MINIMUM OF ONCE EVERY SEVEN CALENDAR DAYS, AND SHALL OCCUR WITHIN 24 HOURS AFTER ANY STORM EVENT GREATER THAN 0.5 INCHES OF RAINFALL PER 24-HOUR PERIOD UNTIL THE SITE HAS BEEN STABILIZED. ANY REQUIRED REPAIRS OR MAINTENANCE WILL BE MADE IMMEDIATELY.
- DISTURBED AREAS SHALL BE SEEDED AND MULCHED UPON COMPLETION OF GRADING.
 - STABILIZATION MEASURES SHALL BE INITIATED AS SOON AS PRACTICABLE IN PORTIONS OF THE SITE WHERE CONSTRUCTION ACTIVITIES HAVE TEMPORARILY OR PERMANENTLY CEASED, BUT IN NO CASE MORE THAN SEVEN DAYS AFTER THE CONSTRUCTION ACTIVITY IN THAT PORTION OF THE SITE HAS PERMANENTLY CEASED.
 - WHERE THE INITIATION OF STABILIZATION MEASURES BY THE SEVENTH DAY AFTER CONSTRUCTION ACTIVITY TEMPORARILY OR PERMANENTLY CEASES IS PRECLUDED BY SNOW COVER, STABILIZATION MEASURES SHALL BE INITIATED AS SOON AS CONDITIONS ALLOW.
 - WHERE CONSTRUCTION ACTIVITY WILL RESUME ON A PORTION OF THE SITE WITHIN 21 DAYS FROM WHEN ACTIVITIES CEASED, (E.G. THE TOTAL TIME PERIOD THAT CONSTRUCTION ACTIVITY IS TEMPORARILY HALTED IS LESS THAN 21 DAYS) THEN STABILIZATION MEASURES DO NOT HAVE TO BE INITIATED ON THAT PORTION OF THE SITE BY THE SEVENTH DAY AFTER CONSTRUCTION ACTIVITIES HAVE TEMPORARILY CEASED.
 - AREAS WHERE THE SEED HAS FAILED TO GERMINATE ADEQUATELY (UNIFORM PERENNIAL VEGETATIVE COVER WITH A DENSITY OF 70%) WITHIN 30 DAYS AFTER SEEDING AND MULCHING MUST BE RESEEDING IMMEDIATELY, OR AS SOON AS WEATHER CONDITIONS ALLOW.
- EROSION & SEDIMENT CONTROLS SHALL BE INSTALLED IN LOCATIONS DOWN SLOPE FROM THE DISTURBED AREAS AS A FIRST MEASURE OF CONSTRUCTION. COMPOST FILTER SOCK SHALL BE INSPECTED AFTER EACH RAINFALL. ANY REQUIRED REPAIRS SHALL BE MADE IMMEDIATELY. DAMAGED, DECOMPOSED OR OTHERWISE INEFFECTIVE SILT FENCE SHALL BE REPLACED. SEDIMENT DEPOSITS SHOULD BE REMOVED AS REQUIRED WHEN DEPOSITS REACH APPROXIMATELY ONE-HALF OF THE BARRIER HEIGHT. ANY SEDIMENT DEPOSITS REMAINING IN PLACE AFTER THE SILT FENCE IS NO LONGER NEEDED SHALL BE DRESSED TO CONFORM TO THE EXISTING GRADE AND STABILIZED.
- DEVICES LISTED HEREIN ARE CONSIDERED MINIMUM EROSION AND SEDIMENT CONTROLS. ADDITIONAL CONTROL MEASURES MAY BE NECESSARY DUE TO CONTRACTOR PHASING OR OTHER UNFORESEEN CONDITIONS. IT IS THE CONTRACTOR'S RESPONSIBILITY TO PROVIDE ADDITIONAL MEASURES IN ADDITION TO THOSE SHOWN, AS NEEDED, IN ORDER TO CONTROL EROSION AND CONTAIN SEDIMENT ON SITE.
- THE CONTRACTOR IS RESPONSIBLE FOR KEEPING EXISTING PUBLIC ROADS IN A CLEAN, DUST AND MUD FREE CONDITION AT THE SITE.
- ALL COMPOST FILTER SOCK SHALL BE INSTALLED ALONG THE CONTOURS, PERPENDICULAR TO THE FLOW OF WATER. SEE DETAIL ON DRAWING NO. 5.
- WORK AREAS WILL BE USED TO LAYOUT AND ASSEMBLE GAS LINE FIXTURES. MINIMAL EARTH DISTURBANCE IS EXPECTED. HOWEVER, EROSION AND SEDIMENT CONTROL WILL BE INSTALLED AS IF THE ENTIRE AREA WILL BE DISTURBED. DISTURBED AREAS WITHIN THE WORK AREAS WILL BE VEGETATED IN ACCORDANCE WITH THE EROSION AND SEDIMENT CONTROL PLAN AND S.W.P.P.
- BASED ON INFORMATION PRESENTED ON THE SITE FIRM, THE PROJECT IS LOCATED WITHIN FEMA FLOOD ZONE A, WHICH IS THE REGULATORY FLOODPLAIN ASSOCIATED WITH THE BASE FLOOD (1 PERCENT ANNUAL CHANCE FLOOD EVENT), COMMONLY REFERRED TO AS THE 100-YEAR FLOODPLAIN. FLOOD ZONE A INDICATES THAT THE LIMITS OF THE FLOODPLAIN ARE APPROXIMATE, AS SUCH BASE FLOOD ELEVATIONS (BFES) HAVE NOT BEEN PREVIOUSLY ESTABLISHED BY FEMA. ALL WORK ASSOCIATED WITH THE PROPOSED PROJECT WITHIN THE LIMITS OF THE FLOODPLAIN WILL BE IN ACCORDANCE WITH THE FOLLOWING: NO PERMANENT ABOVE GROUND STRUCTURES ARE TO BE CONSTRUCTED WITHIN THE FLOODPLAIN. ANY STABILIZED CONSTRUCTION ENTRANCES TO BE INSTALLED WITHIN THE FLOODPLAIN SHALL BE INSTALLED BY REMOVING EXISTING MATERIAL TO A DEPTH SUITABLE FOR INSTALLING THE ENTRANCES SO THAT THE TOP OF THE GRAVEL SURFACE IS AT ORIGINAL GRADE ELEVATIONS. EXCESS MATERIAL ASSOCIATED WITH THIS ACTIVITY SHALL BE PLACED OUTSIDE OF THE FLOODPLAIN LIMITS. NO FILL SHALL BE PLACED WITHIN THE FLOODPLAIN LIMITS ABOVE ORIGINAL ELEVATIONS. THE PROPOSED WATERLINE WILL BE TEMPORARY AND INSTALLED ON THE SURFACE. IT WILL ALSO BE ANCHORED TO THE GROUND USING 2"x2" WOOD STAKES. SEE DETAIL ON DRAWING NO. 5.

| SYMBOL | LEGEND | DESCRIPTION |
|--------|--|-------------|
| | STREAMS | |
| | EXISTING PIPELINE | |
| | APPROXIMATE LOCATION OF EXISTING CULVERT | |
| | PERMANENT RIGHT-OF-WAY | |
| | PROPOSED WATERLINE | |
| | FLOODPLAIN LIMIT | |
| | PROPOSED COMPOST FILTER SOCK | |
| | PROPOSED TEMPORARY STONE CONSTRUCTION ENTRANCE | |

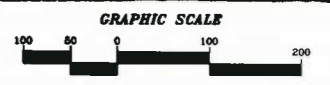

MAPPING REFERENCE:
 BASE TOPOGRAPHIC MAPPING TAKEN FROM WVGIS SAMS AERIAL MAPPING, DATED 2003.

| No. | Date | Revision |
|-----|------|----------|
| | | |
| | | |
| | | |

Perennial Mixture

| Rate (lb/1000 sq. ft.) | Seed Variety | Minimum Specifications | % Total Germination |
|------------------------|------------------------|------------------------|---------------------|
| 0.45 | Red Fescue (Perennial) | 93 | 85 |
| 0.90 | Kentucky Bluegrass | 84 | 75 |
| 0.70 | Medic Biolegume | 90 | 75 |
| 0.20 | Annual Ryegrass* | 93 | 85 |

General Mixture


| Variety of Seed | Spring 5/15 - 5/31 lb/acre | Fall 8/15 - 10/15 lb/acre |
|--|----------------------------|---------------------------|
| Orchardgrass (Dactylis Glomerata) | 15 | 15 |
| Birdfoot Trefoil ⁽¹⁾ (Lotus Coradictalis) | 15 | 15 |
| Red Clover (Trifolium Pratense) | 10 | 10 |
| Annual Ryegrass (Lolium Multiflorum) | 15 | 15 |
| Bicolor Lespedeza | 1 | 1 |
| Foxtail Millet | 12 | 12 |
| or Hairy Vetch ⁽²⁾ (Vicia Villosa) | 5 | 5 |
| or Winter Wheat: | 10 | 20 |

⁽¹⁾ Herbaceous Legume; must be treated with the appropriate bacterium before seeding. An area which has a steep slope (greater than 1:1); or shall grow suitable Crowsfoot (Coronilla varia) or 20 pounds/acre for Birdfoot Trefoil.
⁽²⁾ Use only if the area is flooded.

PERMANENT SEED MIXTURES

NO SCALE

ROLLED EROSION CONTROL PRODUCTS

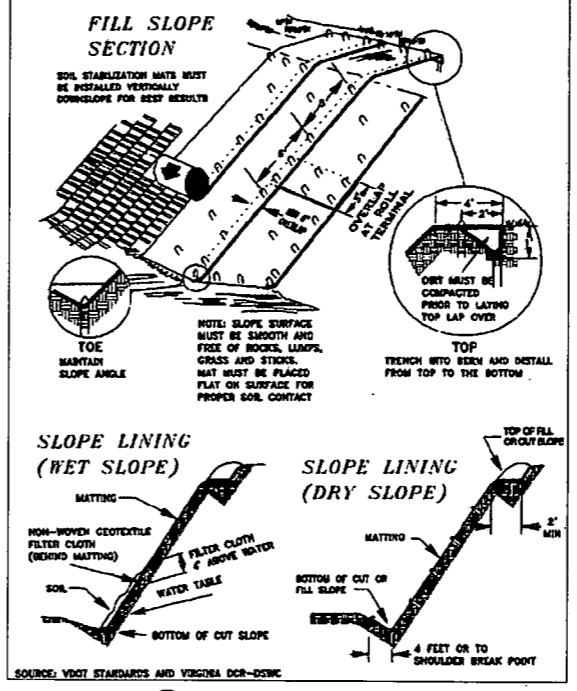

NOTE: SEE 6/5 FOR ECTC SPECIFICATIONS.

ROLLED EROSION CONTROL MATTING

NO SCALE

For use where natural vegetation alone will provide permanent erosion protection.

ULTRA SHORT-TERM - Typical 3 month functional longevity.

| Typ Product Description | Material Composition | Slope Applications* Maximum Gradient C Factor ^{2,5} | Channel Applications* Max. Shear Stress ^{4,6} | Minimum Tensile Strength ¹ |
|---|---|---|---|---------------------------------------|
| 1.A Mulch Control Mats | A photodegradable synthetic mesh or woven biodegradable natural fiber netting. | 5:1 (H:V) ≤ 0.10 @ 5:1 | 0.25 lb/ft ² (12 Pa) | 5 lb/ft (0.073 kN/m) |
| 1.B Netless Rolled Erosion Control Blankets | Natural and/or polymer fibers mechanically interlocked and/or chemically adhered together to form a RECP. | 4:1 (H:V) ≤ 0.10 @ 4:1 | 0.5 lb/ft ² (24 Pa) | 5 lb/ft (0.073 kN/m) |
| 1.C Single-net Erosion Control Blankets & Open Weave Textiles | Processed degradable natural and/or polymer fibers mechanically bound together by a single rapidly degrading, synthetic or natural fiber netting or an open weave textile of processed rapidly degrading natural or polymer yarns or twines woven into a continuous matrix. | 3:1 (H:V) ≤ 0.15 @ 3:1 | 1.5 lb/ft ² (72 Pa) | 50 lb/ft (0.73 kN/m) |
| 1.D Double-net Erosion Control Blankets | Processed degradable natural and/or polymer fibers mechanically bound together between two rapidly degrading, synthetic or natural fiber nettings. | 2:1 (H:V) ≤ 0.20 @ 2:1 | 1.75 lb/ft ² (84 Pa) | 75 lb/ft (1.09 kN/m) |

SHORT-TERM - Typical 12 month functional longevity.

| Typ Product Description | Material Composition | Slope Applications* Maximum Gradient C Factor ^{2,5} | Channel Applications* Max. Shear Stress ^{4,6} | Minimum Tensile Strength ¹ |
|---|--|---|---|---------------------------------------|
| 2.A Mulch Control Mats | A photodegradable synthetic mesh or woven biodegradable natural fiber netting. | 5:1 (H:V) ≤ 0.10 @ 5:1 | 0.25 lb/ft ² (12 Pa) | 5 lb/ft (0.073 kN/m) |
| 2.B Netless Rolled Erosion Control Blankets | Natural and/or polymer fibers mechanically interlocked and/or chemically adhered together to form a RECP. | 4:1 (H:V) ≤ 0.10 @ 4:1 | 0.5 lb/ft ² (24 Pa) | 5 lb/ft (0.073 kN/m) |
| 2.C Single-net Erosion Control Blankets & Open Weave Textiles | An erosion control blanket composed of processed degradable natural or polymer fibers mechanically bound together by a single degradable synthetic or natural fiber netting to form a continuous matrix or an open weave textile composed of processed degradable natural or polymer yarns or twines woven into a continuous matrix. | 3:1 (H:V) ≤ 0.15 @ 3:1 | 1.5 lb/ft ² (72 Pa) | 50 lb/ft (0.73 kN/m) |
| 2.D Double-net Erosion Control Blankets | Processed degradable natural and/or polymer fibers mechanically bound together between two degradable, synthetic or natural fiber nettings. | 2:1 (H:V) ≤ 0.20 @ 2:1 | 1.75 lb/ft ² (84 Pa) | 75 lb/ft (1.09 kN/m) |

EXTENDED-TERM - Typical 24 month functional longevity.

| Typ Product Description | Material Composition | Slope Applications* Maximum Gradient C Factor ^{2,5} | Channel Applications* Max. Shear Stress ^{4,6} | Minimum Tensile Strength ¹ |
|--|---|---|---|---------------------------------------|
| 3.A Mulch Control Mats | A slow degrading synthetic mesh or woven natural fiber netting. | 5:1 (H:V) ≤ 0.10 @ 5:1 | 0.25 lb/ft ² (12 Pa) | 25 lb/ft (0.36 kN/m) |
| 3.B Erosion Control Blankets & Open Weave Textiles | An erosion control blanket composed of processed slow degrading natural or polymer fibers mechanically bound together between two slow degrading synthetic or natural fiber nettings to form a continuous matrix or an open weave textile composed of processed slow degrading natural or polymer yarns or twines woven into a continuous matrix. | 1.5:1 (H:V) ≤ 0.25 @ 1.5:1 | 2.00 lb/ft ² (96 Pa) | 100 lb/ft (1.45 kN/m) |


LONG-TERM - Typical 36 month functional longevity.

| Typ Product Description | Material Composition | Slope Applications* Maximum Gradient C Factor ^{2,5} | Channel Applications* Max. Shear Stress ^{4,6} | Minimum Tensile Strength ¹ |
|--|---|---|---|---------------------------------------|
| 4 Erosion Control Blankets & Open Weave Textiles | An erosion control blanket composed of processed slow degrading natural or polymer fibers mechanically bound together between two slow degrading synthetic or natural fiber nettings to form a continuous matrix or an open weave textile composed of processed slow degrading natural or polymer yarns or twines woven into a continuous matrix. | 1:1 (H:V) ≤ 0.25 @ 1:1 | 2.25 lb/ft ² (108 Pa) | 125 lb/ft (1.82 kN/m) |

* C Factor and shear stress for Types 1.A, 2.A, and 3.A mulch control nettings must be obtained with netting used in conjunction with pre-applied mulch material.
¹ Minimum Average Tensile Strength, Machine direction using ECTC Mod. ASTM D 6835.
² C Factor calculated as ratio of soil loss from RECP protected slope (ft³ or m³) to ratio of soil loss from unprotected (control) plot in large-scale testing. These performance test values should be supported by periodic bench scale testing under similar test conditions and failure criteria using Erosion Control Technology Council (ECTC) Test Method # 2.
³ Required minimum shear stress RECP (unvegetated) can sustain without physical damage or excess erosion (> 12.7 mm (0.5 in) soil loss) during a 30-minute flow event in large-scale testing. These performance test values should be supported by periodic bench scale testing under similar test conditions and failure criteria using Erosion Control Technology Council (ECTC) Test Method # 2.
⁴ The permissible shear stress levels established by each performance category are based on historical experience with products manufactured by Manning's roughness coefficients in the range of 0.01 - 0.05.
⁵ Acceptable large-scale test methods may include ASTM D6459, Erosion Control Technology Council (ECTC) Test Method # 2, or other independent testing deemed acceptable by the engineer.
⁶ Per the engineer's discretion. Recommended acceptable large-scale testing protocol may include ASTM D6460, Erosion Control Technology Council (ECTC) Test Method # 3 or other independent testing deemed acceptable by the engineer.


ECTC STANDARD SPECIFICATION FOR TEMPORARY ROLLED EROSION CONTROL PRODUCTS

NO SCALE

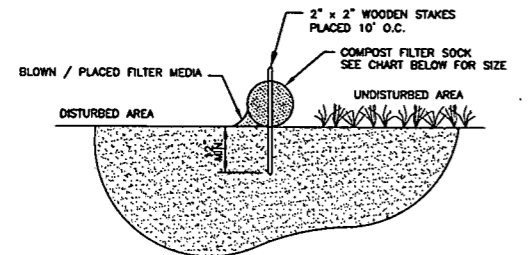

SECTION VIEW

NO SCALE

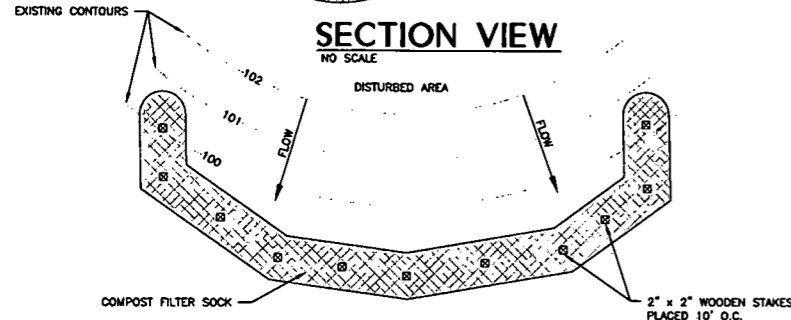


PLAN VIEW

NO SCALE

COMPOST SHALL MEET THE FOLLOWING STANDARDS

| | |
|----------------------------|-------------------------------|
| ORGANIC MATTER CONTENT | 80% - 100% (DRY WEIGHT BASIS) |
| ORGANIC PORTION | FIBROUS AND ELONGATED |
| PH | 5.5 - 8.0 |
| MOISTURE CONTENT | 35% - 55% |
| PARTICLE SIZE | 88% PASS THROUGH 1" SCREEN |
| SOLUBLE SALT CONCENTRATION | 5.0 %S MAXIMUM |

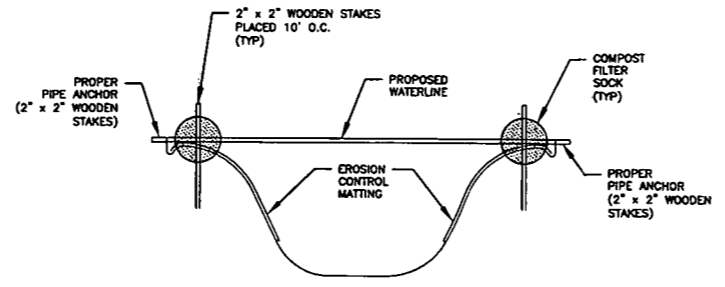

STREAM CROSSING DETAIL

NO SCALE

- NOTES:**
1. ALL STREAM BANKS MUST BE STABILIZED IMMEDIATELY.
 2. PLACE SEED AND SOIL SUPPLEMENTS ON BANKS PRIOR TO EROSION CONTROL MATTING INSTALLATION.


MAXIMUM SLOPE LENGTH ABOVE SEDIMENT CONTROL IN FEET *

| SLOPE PERCENT | SEDIMENT CONTROL | | | | |
|---------------|------------------|------------|------------|------------|------------|
| | 8 INCH ** | 12 INCH ** | 18 INCH ** | 24 INCH ** | 32 INCH ** |
| 2 OR LESS | 600 | 750 | 1000 | 1300 | 1650 |
| 5 | 400 | 500 | 550 | 650 | 750 |
| 10 | 200 | 250 | 300 | 400 | 500 |
| 15 | 140 | 170 | 200 | 325 | 450 |
| 20 | 100 | 125 | 140 | 260 | 400 |
| 25 | 80 | 100 | 110 | 200 | 275 |
| 30 | 60 | 75 | 90 | 130 | 200 |
| 35 | 60 | 75 | 80 | 115 | 150 |
| 40 | 60 | 75 | 80 | 100 | 125 |
| 45 | 40 | 50 | 60 | 80 | 100 |
| 50 | 40 | 50 | 55 | 65 | 75 |


* BASED ON A FAILURE OF 36" SUPER SILT FENCE (WIRE REINFORCED AT 1000 FEET OF SLOPE, WATERLENGTH EQUIVALENT TO RECEIVING LENGTH OF SEDIMENT CONTROL DEVICE, 1 IN. / 24 HR RAIN EVENT)
** EFFECTIVE HEIGHT OF SEDIMENT CONTROL AFTER INSTALLATION AND WITH CONSTANT HEAD FROM RUNOFF AS DETERMINED BY OHIO STATE UNIVERSITY.

COMPOST FILTER SOCK


NO SCALE

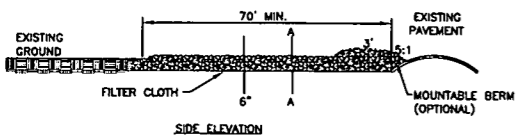

SIDE ELEVATION

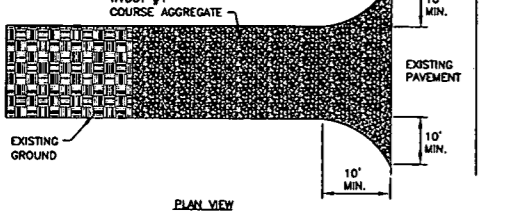

PLAN VIEW

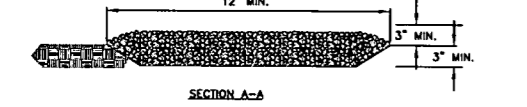

SECTION A-A

STONE CONSTRUCTION ENTRANCE DETAIL

NO SCALE

- NOTES:**
1. TOP SOIL SHOULD BE REMOVED PRIOR TO INSTALLATION OF ROCK CONSTRUCTION ENTRANCE.
 2. EXTEND ROCK OVER FULL WIDTH OF ENTRANCE.
 3. RUNOFF SHALL BE DIVERTED FROM ROADWAY TO A SUITABLE SEDIMENT REMOVAL BMP PRIOR TO ENTERING ROCK CONSTRUCTION ENTRANCE.
 4. MOUNTABLE BERM SHOULD BE INSTALLED WHEREVER OPTIONAL CULVERT PIPE IS USED. PIPE TO BE SIZED APPROPRIATELY FOR SIZE OF DITCH BEING CROSSED.
 5. MAINTENANCE - ROCK CONSTRUCTION ENTRANCE THICKNESS SHALL BE CONSTANTLY MAINTAINED TO THE SPECIFIED DIMENSION BY ADDING ROCK. A STOCKPILE SHALL BE MAINTAINED ON SITE FOR THIS PURPOSE. ALL SEDIMENT DEPOSITED ON PAVED ROADWAYS SHALL BE REMOVED AND RETURNED TO THE CONSTRUCTION IMMEDIATELY. IF EXCESSIVE AMOUNT OF SEDIMENT ARE BEING DEPOSITED ON ROADWAY, EXTEND THE LENGTH OF ROCK CONSTRUCTION ENTRANCE BY 50 FOOT INCREMENTS UNTIL CONDITION IS ALLEVIATED OR INSTALL WASH RACK, WASHING THE ROADWAY OR SWEEPING THE DEPOSITS INTO ROADWAY DITCHES, SEWER, CULVERTS, OR OTHER DRAINAGEWAYS IS NOT ACCEPTABLE.

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ISSUE DATE 2/5/2014

-DETAILS
CAD File No.
JM
Drawn
JWS
Checked
JMS
Approved
NOTED
Scale:
FEB 2014
Date:
11-0147-803
Project No.

POTESTA & ASSOCIATES, INC.
ENGINEERS AND ENVIRONMENTAL CONSULTANTS
7012 Macomber Ave. SE, Overland Park, KS 66204
TEL: (913) 342-1400 FAX: (913) 343-9031
E-Mail: Address: potesta@potesta.com

POTESTA

EQT PRODUCTION COMPANY
115 PROFESSIONAL PLACE
BRIDGEPORT, WEST VIRGINIA

MISCELLANEOUS DETAILS
EQT WEB WATERLINE
EROSION & SEDIMENT CONTROL PLAN
DODDRIDGE COUNTY, WEST VIRGINIA

5
Drawing No.







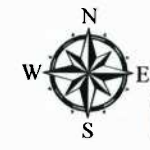
FIGURE 1
LOCATION MAP
WEU 8 WELL LINE REROUTE
EQT
DODDRIDGE COUNTY,
WEST VIRGINIA

DATE: JUNE 2013
 G:\Projects\2011\11-0147 EQT Well Sites\Map Documents
 WEU8WL_Reroute\WEU8WL_Reroute_FIG_3.mxd

 Approximate Limits of Disturbance
 WEU8 Revised Well Line

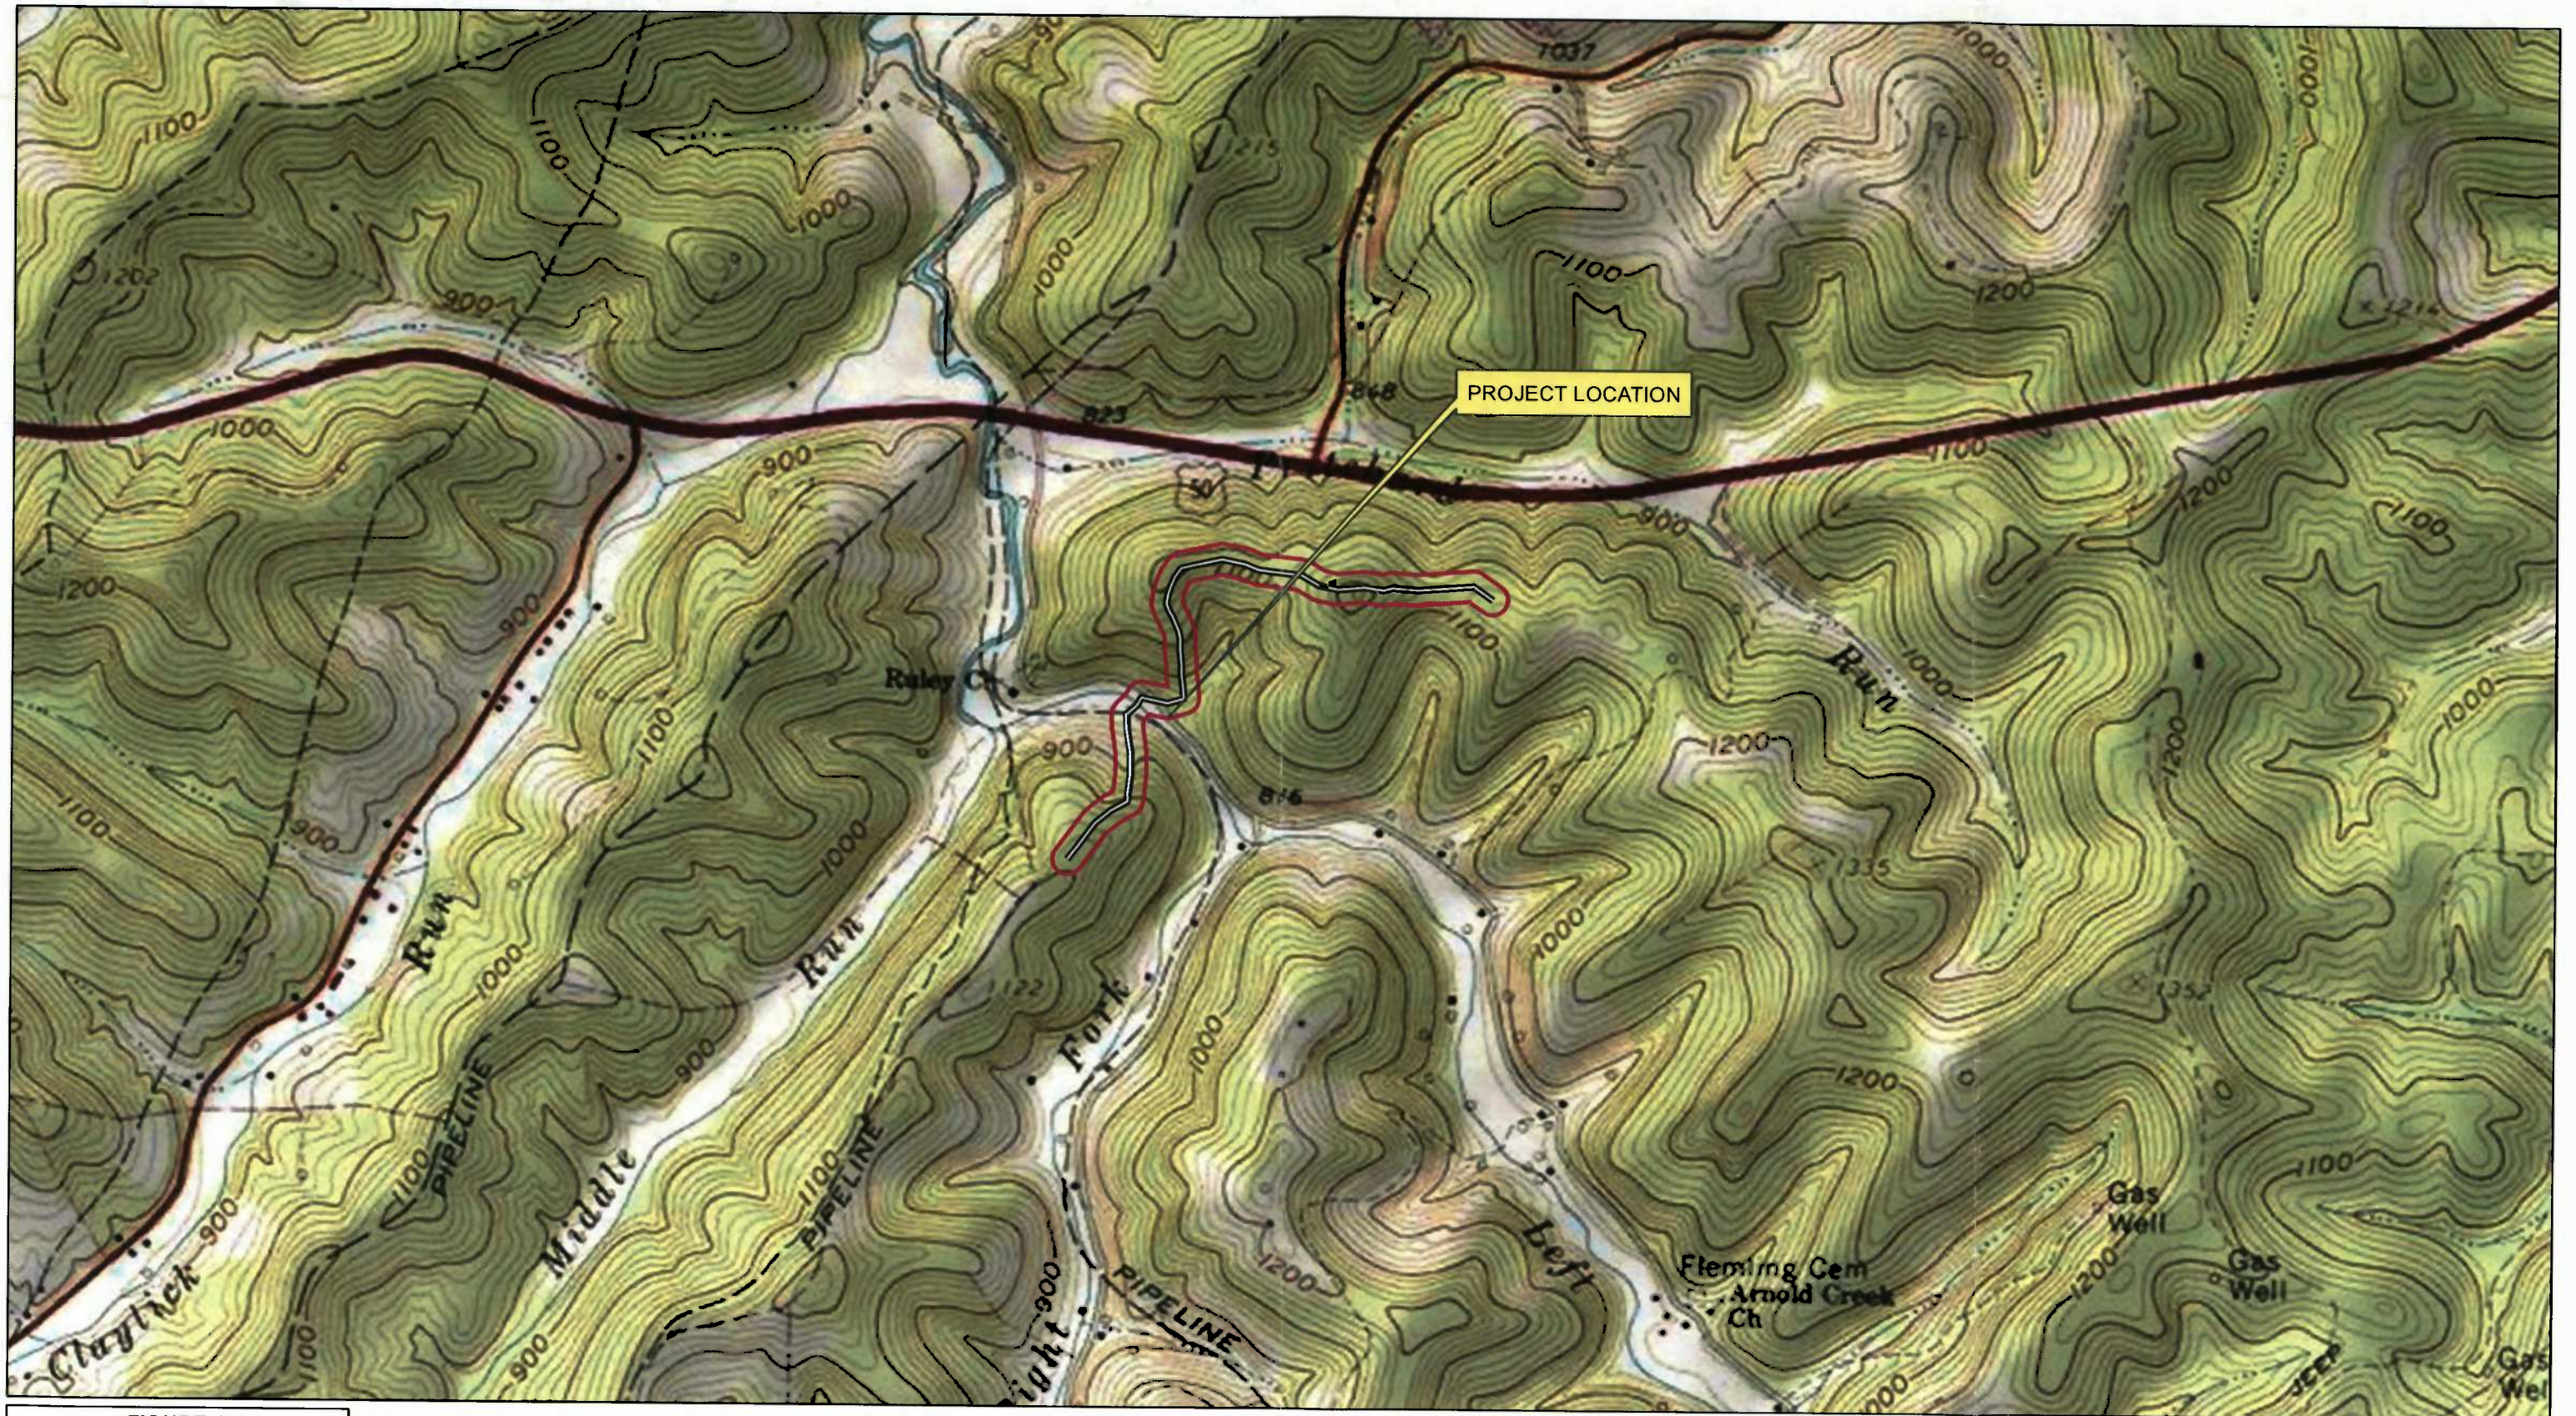Aerial Imagery: 10/8/2011

015800 600
 Feet



STATE OF WEST VIRGINIA,
COUNTY OF DODDRIDGE, TO WIT

I, Virginia Nicholson, Editor of THE
HERALD RECORD, a weekly newspaper
published regularly, in Doddridge County,
West Virginia, Do Hereby Certify Upon
Oath That the Accompanying Legal Notice
Entitled:

..... Floodplain Permit
14-192

was published in said paper for 2
successive weeks beginning with the issue
of April 29th 2014 and
ending with the issue of

..... May 6th 2014 and
that said notice contains 189

WORD SPACE at 115 cents a word
amounts to the sum of \$ 21.74

FOR FIRST PUBLICATION, SECOND
PUBLICATION IS 75% OF THE FIRST
PUBLICATION

\$ 1613.1
and each publication thereafter
\$ 3805 TOTAL

EDITOR
..... Virginia Nicholson

SWORN TO AND SUBSCRIBED
BEFORE ME THIS THE 8th DAY
OF May 2014

NOTARY PUBLIC
..... Laura J Adams

Legal Advertisement

LEGAL ADVERTISEMENT
Doddridge County
Floodplain Permit Application
Please take notice that on the 24th day of April, 2014
EQT PRODUCTION COMPANY #14-192 filed an
application for a Floodplain Permit to develop land
located at or about SURFACE OWNERS: ELEANOR
MAXWELL MEYER, WEST UNION DISTRICT,
ARNOLDS CREEK AREA, WILL BOOK 10 PG 526
The Application is on file with the Clerk of the County
Court and may be inspected or copied during regular
business hours. Any interested persons who desire to
comment shall present the same in writing by May 14,
2014.
Delivered to the
Clerk of the County Court
118 E. Court Street, West Union, WV 26456
Beth A. Rogers, Doddridge County Clerk
Edwin L. "Bo" Wriston, Doddridge County Flood Plain
Manager
4-29-2xb

