
Doddridge County FPM 118 East Court ST STE 102 West Union, WV 26456-1262





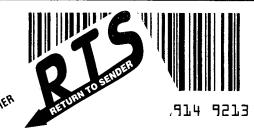

#14-253
Mary H. Holland
PO Box 425
West Union, WV 26456

1ST NOTICE 8-9 2NI MITICE RETURN

645630425 B004

SENDER: COMPLETE THIS SECTION	COMPLETE THIS SECTION ON DELIVERY
 Complete items 1, 2, and 3. Also complete item 4 if Restricted Delivery is desired. Print your name and address on the reverse so that we can return the card to you. 	A. Signature X
Attach this card to the back of the mailpiece, or on the front if space permits.	B. Received by (Printed Name) C. Date of Delive
1. Article Addressed to:	D. Is delivery address different from item 1?
#14-253 Mary H. Holland	•
PO Box 425 West Union, WV 26456	3. Service Type La Certified Mail ☐ Registered ☐ Return Receipt for Merchandis ☐ Insured Mail ☐ Collect on Delivery
	4. Restricted Delivery? (Extra Fee) ☐ Yes
2. Article Number (Transfer from service label) 7013 2250	0001 6914 9213
PS Form 3811, July 2013 Domestic Re	turn Receipt



Doddridge County FPM 118 East Court Street, Suite 102 West Union, WV 26456

Dear Sir or Ma'am,

You are receiving this letter because you have been identified as a land surface and/or mineral rights owner for property or adjacent property related to the proposed development project identified by the following page.

No action is required of you. This letter is simply to inform you of the proposed development.

If you would like to comment on this proposed project, or would like additional information, you may contact the Doddridge County Floodplain Manager at the above address.

Respectfully yours,

Edwin L. Wriston

Doddridge County Floodplain Manager

304.873.2631

doddridgecountyfpm@gmail.com

Legal Advertisement:

Doddridge County

Floodplain Permit Application

Please take notice that on the 1st day of August, 2014

Cone Gathering LLC

filed an application for a Floodplain Permit to develop land located at or about:

39.39.257067N / 80.713276W

Permit #14-253 Meathouse Fork - OX11 Waterline

The Application is on file with the Clerk of the County Court and may be inspected or copied during regular business hours. Any interested persons who desire to comment shall present the same in writing by August 23, 2014, delivered to:

Clerk of the County Court

118 E. Court Street, West Union, WV 26456


Beth A Rogers, Doddridge County Clerk


Edwin L. "Bo" Wriston. Doddridge County Flood Plain Manager

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#14-253	
Haessly Hardwood Lumber C	Co. L
Route 1 Box 185	3. Service Type
Marietta, OH 45750	☐ Registered ☐ Return Receipt for Merchandis
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NDER: COMPLETE THIS SECTION	
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so that we can return the card to you. Attach this card to the back of the mailpiece,	B. Received by (Printed Name) C. Date of Delivery
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	" I 125, enter delivery address 55.5."
#14-253	
Robert Gayle Maxwell	3. Service Type
Route 1 Box 28A	☐ Certified Mail® ☐ Priority Mail Express™
New Milton, WV 26411	☐ Registered ☐ Return Receipt for Merchandise
	☐ Registered ☐ Return Receipt for Merchandise☐ Insured Mail ☐ Collect on Delivery
New Milton, WV 26411	☐ Certified Mail® ☐ Priority Mail Express™☐ Registered ☐ Return Receipt for Merchandise☐ Insured Mail ☐ Collect on Delivery 4. Restricted Delivery? (Extra Fee) ☐ Yes
New Milton, WV 26411	☐ Registered ☐ Return Receipt for Merchandise☐ Insured Mail ☐ Collect on Delivery
New Milton, WV 26411 Article Number (Transfer from service label) 7013 25	☐ Certified Mail® ☐ Priority Mail Express™☐ Registered ☐ Return Receipt for Merchandise☐ Insured Mail ☐ Collect on Delivery 4. Restricted Delivery? (Extra Fee) ☐ Yes
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New Milton, WV 26411 Article Number (Transfer from service label) Form 3811, July 2013 ENDER: COMPLETE THIS SECTION Complete items 1, 2, and 3. Also complete item 4 if Restricted Delivery is desired. Print your name and address on the reverse so that we can return the card to you. Attach this card to the back of the maliplece	☐ Registered ☐ Return Receipt for Merchandise ☐ Insured Mail ☐ Collect on Delivery 4. Restricted Delivery? (Extra Fee) ☐ Yes ☐ Stic Return Receipt COMPLETE THIS SECTION ON DELIVERY A. Signature ☐ Agent ☐ Addresser ☐ Agent ☐ Addresser ☐ Return Received by (Printed Name) ☐ C. Date of Delivery
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Article Number (Transfer from service label) Form 3811, July 2013 Complete items 1, 2, and 3. Also complete item 4 if Restricted Delivery is desired. Print your name and address on the reverse so that we can return the card to you. Attach this card to the back of the mailplece or on the front if space permits. Article Addressed to: #14-253 I.L. Ike Morris	Registered Return Receipt for Merchandise Insured Mail Collect on Delivery 4. Restricted Delivery? (Extra Fee) Yes 25 0 0 0 1 4 9 4 9 4 9 4 9 4 9 4 9 4 9 4 9 4 9 4
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PS Form 3811, July 2013

Domestic Return Receipt



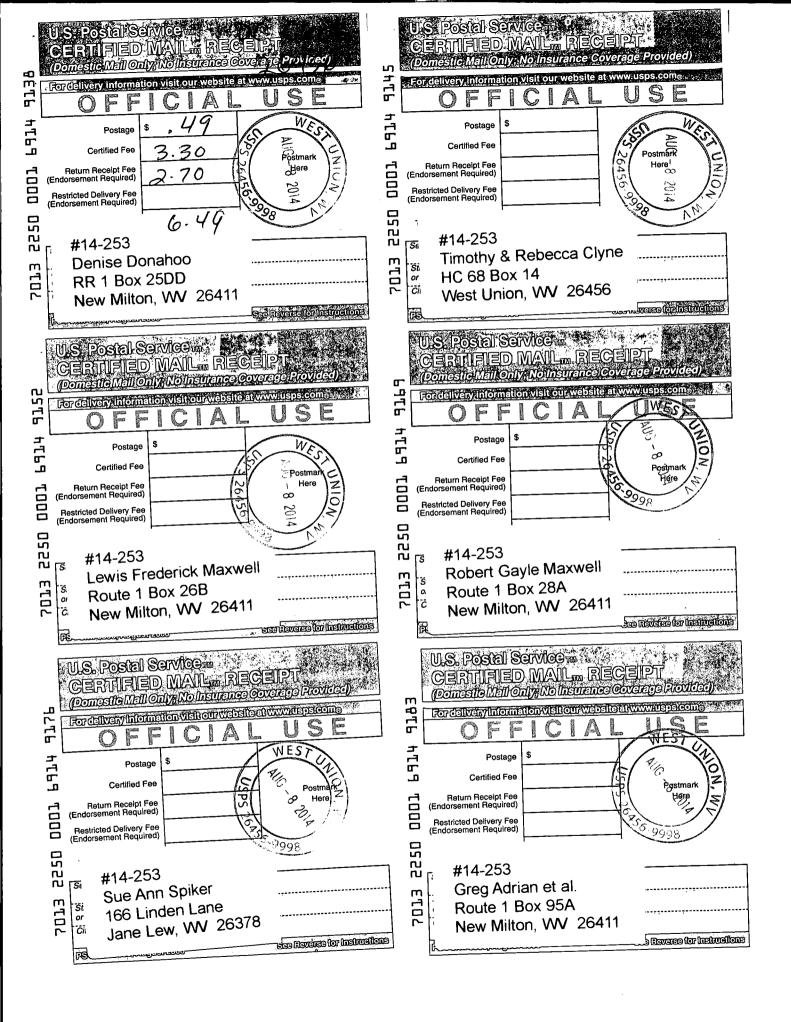
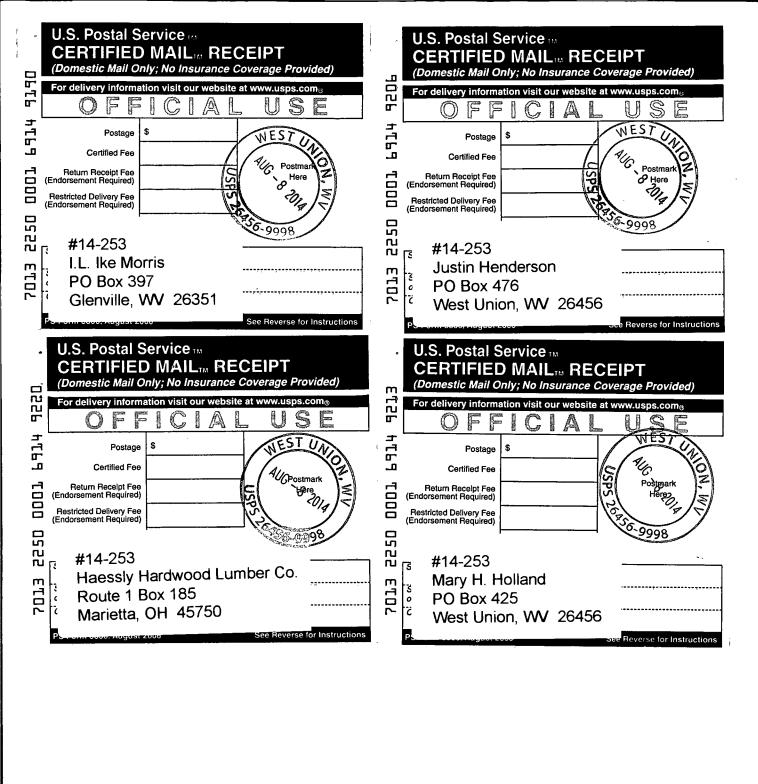
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Route 1 Box 26B New Milton, WV 26411	3. Service Type □ Certified Mail® □ Priority Mail Express™ □ Registered □ Return Receipt for Merchandise □ Insured Mail □ Collect on Delivery 4. Restricted Delivery? (Extra Fee) □ Yes				
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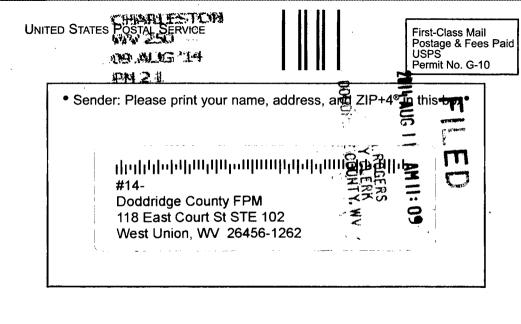
First-Class Mail Postage & Fees Paid USPS Permit No. G-10

• Sender. Please print your name, address, and ZIP+4® in this box•


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#14-Doddridge County FPM 118 East Court St STE 102 West Union, WV 26456-1262

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#14-253 Timothy & Rebecca Clyne	D. Is delivery address different from item 1? ☐ Yes If YES, enter delivery address below: ☐ No
HC 68 Box 14 West Union, WV 26456	3. Service Type □ Certified Mail® □ Priority Mail Express™ □ Registered □ Return Receipt for Merchandise □ Insured Mail □ Collect on Delivery
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#14-253 Sue Ann Spiker	: 1
166 Linden Lane Jane Lew, WV 26378	3. Service Type ☐ Certified Mail® ☐ Priority Mail Express™ ☐ Registered ☐ Return Receipt for Merchandise ☐ Insured Mail ☐ Collect on Delivery
	4. Restricted Delivery? (Extra Fee)
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PS Form 3811, July 2013 Domestic Ret	urn Receipt



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RR 1 Box 25DD New Milton, WV 26411	3. Seprice Type ☐ Certified Mail ☐ Priority Mail Express ☐ Registered ☐ Return Receipt for Merchandise ☐ Insured Mail ☐ Collect on Delivery 4. Restricted Delivery (Extra Fee) ☐ Yes
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PS Form 3811, July 2013 Domestic Retu	urn Receipt

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UNITED STATES POSTAL SERVICE
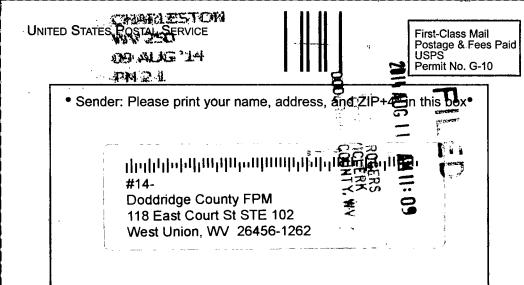
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First-Class Mail Postage & Fees Paid USPS Permit No. G-10

• Sender Mease print your name, address, and ZIP+4® this box•



SENDER: COMPLETE THIS SECTION	COMPLETE THIS SECTION ON DELIVERY
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#14-253 Greg Adrian et al.	
Route 1 Box 95A	3. Service Type
New Milton, WV 26411	☐ Certified Mail® ☐ Priority Mail Express™
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United States Postal Service




First-Class Mail Postage & Fees Paid USPS Permit No. G-10


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Doddridge County FPM 118 East Court ST STE 102 West Union, WV 26456-1262



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Doddridge County FPM 118 East Court Street, Suite 102 West Union, WV 26456

Dear Sir or Ma'am,

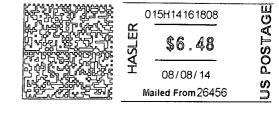You are receiving this letter because you have been identified as a land surface and/or mineral rights owner for property or adjacent property related to the proposed development project identified by the following page.

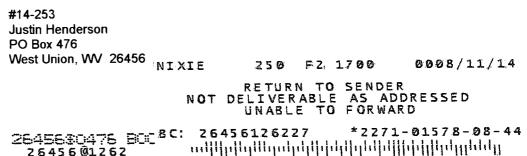No action is required of you. This letter is simply to inform you of the proposed development.

If you would like to comment on this proposed project, or would like additional information, you may contact the Doddridge County Floodplain Manager at the above address.

Respectfully yours,

Edwin L. Wriston

Doddridge County Floodplain Manager

304.873.2631

doddridgecountyfpm@gmail.com

Legal Advertisement:

Doddridge County

Floodplain Permit Application

Please take notice that on the 1st day of August, 2014

Cone Gathering LLC

filed an application for a Floodplain Permit to develop land located at or about:

39.39.257067N / 80.713276W

Permit #14-253 Meathouse Fork - OX11 Waterline

The Application is on file with the Clerk of the County Court and may be inspected or copied during regular business hours. Any interested persons who desire to comment shall present the same in writing by August 23, 2014, delivered to:

Clerk of the County Court

118 E. Court Street, West Union, WV 26456

Beth A Rogers, Doddridge County Clerk

Edwin L. "Bo" Wriston. Doddridge County Flood Plain Manager



Commercial/Industrial Floodplain Development Permit

Doddridge County, WV Floodplain Management

This permit has been issued to **Cone Gathering, LLC**, and is for the approved commercial and/or industrial development project associated with this permit that impacts the FEMA-designated floodplain and/or floodway of Doddridge County, WV, pursuant to the rules and regulations established by all applicable Federal, State and local laws and ordinances, including the Doddridge County Floodplain Ordinance. This permit must be posted at the site of work as to be clearly visible, and must remain posted during entirety of development.

Permit: #14-253 ~ Cone Gathering, LLC ~ Meathouse Fork to OX11 Waterline

Date Approved: 12/31/2014 Expires: 12/31/2015

Issued to: Cone Gathering, LLC

POC: Greg Linder 304.933.3119

Company Address: 99 Cambridge Place

Bridgeport, WV 26330

District: New Milton

Lat/Long: 39.257067N/80.713276W

Purpose of development: Waterline construction.

Issued by: Edwin L. "Bp" Wriston, Doddridge County FPM (or designee)

Date: 12/31/2014

Legal Advertisement:

Doddridge County

Floodplain Permit Application

Please take notice that on the 1st day of August, 2014

Cone Gathering LLC

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Clerk of the County Court

118 E. Court Street, West Union, WV 26456

Beth A Rogers, Doddridge County Clerk

Edwin L. "Bo" Wriston. Doddridge County Flood Plain Manager

CNX Gas Company LLC

P. O. Box 305

Canonsburg, PA 15317-0305 Phone: 724-485-4031

DODDRIDGE COUNTY COMMISSION

Vendor No. 824536 Check No. 2780029798

Invoice Number	Invoice Date	invoics Amount	Discount Amount	Net Amoura
OXFD11 WATERLINE	1	500.00	. 0.00	500.00
		Check Total		\$ 500.00

Doddridge County, West Virginia

RECEIPT NO:	2696			DATE: 2014,	/08/06	
FROM	: CNX GAS	COMPANY		AMOUNT: \$	500	0.00
FIVE HUNDRED	DOLLARS AN	D 00 CENTS			11.2.12.11	
FOR	: #14-253	MEATHOUSE	FORK OX11	WATERLINE		
02780029798	FP-BUILDI	NG PERMITS		020-318	TOTAL:	\$500.00
***************************************	HEADLEY UFF &TREASUR	EER	<u>.</u> .	-	MEC CLERK	
			Customer C	ору		
#14-2	53					
THIS CHECK IS TENDERED IN FO	ILL SETTLEMENT OF YOU	R INVOICES LISTED HERE	ON.		PLEASE DETACH REM	ITTANCE BEFORE CASHING.



Meathouse Fork-OX11
Waterline

Doddridge County
Floodplain Permit Application
and Fees

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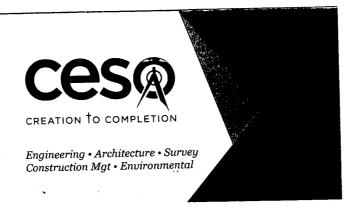
www.cesoinc.com

NATALIE HOOTON, M.S.

Staff Biologist (412) 221-2236 (412) 639-2231 Cell, (412) 221-2267 Fax hooton@cesoinc.com

800 Bursca Drive, Suite 804 Bridgeville, Pennsylvania 15017-1451







800 Bursca Drive, Suite 804 Bridgeville, Pennsylvania 15017-1451 (412) 221-2236

www.cesoinc.com

July 31, 2014

Mr. Edwin "Bo" Wriston Doddridge County Floodplain Manager 118 East Court Street West Union, WV 26456

RE: Meathouse Fork-OX11 Aboveground Waterline

Doddridge County Floodplain Permit

Dear Mr. Wriston:

CESO, Inc. is pleased to submit this information for a Doddridge County Floodplain Permit, for the proposed Meathouse Fork-OX11 Aboveground Waterline. Cone Gathering, LLC (Cone), is proposing to construct a new temporary water transport system and associated construction access roads within a portion of Doddridge County, West Virginia. The proposed new waterline will be approximately 8.3 miles long with a temporary withdrawal point located southwest of the intersection of State Route 18 and County Route 40, near Blandville, West Virginia. From the withdrawal point, the waterline will transport water southeast to the OX11 well pad.

CESO, Inc. has identified a total of twenty-two (22) named and unnamed waterways crossings in Doddridge County as a result of this project. The Doddridge County Development Permit Application further describing project characteristics is presented in Attachment 1. According to the FEMA Flood Insurance Rate Maps, two waterways within the project area, South Fork Hughes River and Meathouse Fork, occur within the FEMA 100-year floodplain. A map depicting the proposed alignment location as well as a table and map identifying stream crossings are also provided.

Waterway crossings associated with waterline installation will include the use of six (6) existing culverts and/or bridges. Additionally, the project will result in two (2) temporary timber mat bridges and fourteen (14) waterline crossings using cribbing and temporary timber mat bridges. However, all waterways will be returned to their pre-disturbance plan, profile, and dimension after the pipe has been installed. In addition, proper construction sequencing and implementation of an approved erosion and sediment control plan will ensure water quality impacts are minimized throughout the project area and the proposed activities are in compliance with Nationwide Permit General Conditions and Regional General Conditions.

Should you have any questions or comments please don't hesitate to contact me at 412-221-2236 ext. 2009 or through email at hooton@cesoinc.com.

Sincerely,

CESO, Inc.

Natalie Hooton Staff Biologist



MEATHOUSE FORK TO OX 1 1 WATERLINE DODDRIDGE FLOODPLAIN PERMIT APPLICATION: STREAM CROSSING TABLES

Table 1. Stream Crossings with No Impacts (use of existing culverts or bridges)

Stream Field ID	Stream Category	Stream Name or Tributary Of	Project Activity	Coordinates (NAD 83) (dd)	Width (feet)
G28	Perennial	UNT Lick Run	Access Road	39.2553914, - 80.711857	10.0
G62	Ephemeral	UNT Lick Run	Access Road	39.208589, -80.753596	1.5
G67	Ephemeral	UNT Dry Run	Access Road	39.192948, -80.778871	1.5
G66	Ephemeral	UNT Dry Run	Access Road	39.191821, -80.780310	1.5
G65	Ephemeral	UNT Dry Run	Access Road	39.190652, -80.780713	1.5
CF	Intermittent	UNT Dry Run	Access Road	39.196457, -80.775522	1.5

39.257067



MEATHOUSE FORK TO OX 1 1 WATERLINE DODDRIDGE FLOODPLAIN PERMIT APPLICATION: STREAM CROSSING TABLES

Table 2. Stream Crossings by Pipeline Activity

Stream Field ID	Stream Category	Stream Name or Tributary Of	Project Activity	Type of Crossing	Coordinates (NAD83) (dd)	Width (feet)	Crossing Size (linear feet)
G30	Ephemeral	UNT Lick Run	Aboveground Waterline	Cribbed and Timber Matted	39.203093, - 80.759273	1.5	28
G31	Intermittent	UNT Lick Run	Aboveground Waterline	Cribbed and Timber Matted	39.20286, -80.758531	3.0	30
G32	Intermittent	UNT Lick Run	Aboveground Waterline	Cribbed and Timber Matted	39.206562, -80.756797	3.5	26
G36	Intermittent	UNT Lick Run	Aboveground Waterline	Cribbed and Timber Matted	39.207095, -80.756547	3.0	30
G41	Intermittent	UNT Bluestone Creek	Aboveground Waterline	Cribbed and Timber Matted	39.211893, -80.756394	3.0	34
G44	Intermittent	UNT Lick Run	Aboveground Waterline	Cribbed and Timber Matted	39.220242, -80.746651	4.0	26
G48	Intermittent	UNT Lick Run	Aboveground Waterline	Cribbed and Timber Matted	39.223403, -80.744074	3.0	29
G50	Perennial	UNT Lick Run	Aboveground Waterline	Cribbed and Timber Matted	39.227935, -80.738117	6.0	28
G52	Intermittent	UNT Lick Run	Aboveground Waterline	Cribbed and Timber Matted	39.232640, -80.734112	7.0	25
G53	Ephemeral	UNT Lick Run	Aboveground Waterline	Cribbed and Timber Matted	39.237701, -80.729793	1.0	26
СС	Perennial	Cain Run	Aboveground Waterline	Cribbed and Timber Matted	39.190895, -80.762141	3.0	29
ZA	Perennial	UNT South Fork Hughes River	Aboveground Waterline	Cribbed and Timber Matted	39.177298, -80.76441	5.0	26
ZZ	Perennial	South Fork Hughes River	Aboveground Waterline	Cribbed and Timber Matted	39.183197, -80.766435	10.0	33
6	Ephemeral	Right Hand Fork Lick Run	Aboveground Waterline	Cribbed and Timber Matted	39.242649, -80.728801	2.0	25



MEATHOUSE FORK TO OX11 WATERLINE STREAM ACTIVITY APPLICATION: STREAM CROSSING TABLES

Table 3. Stream Crossings by Access Road Activity

Stream Field ID	Stream Category	Stream Name or Tributary Of	Project Activity	Type of Impact	Coordinates (dd)	Width (feet)	Crossing Sizw (linear feet)
G68	Perennial	Dry Run	Access Road	Temporary Timber Mat Bridge	39.194580, - 80.777114	3.0	25
G64	Perennial	Dry Run	Access Road	Temporary Timber Mat Bridge	39.189451,80.781161	3.0	30

DODDRIDGE COUNTY FLOODPLAIN DEVELOPMENT PERMIT APPLICATION

SECTION 1: GENERAL PROVISIONS (APPLICANT TO READ AND SIGN)

- 1. No work may start until a permit is issued.
- 2. The permit may be revoked if any false statements are made herein.
- 3. If revoked, all work must cease until permit is re-issued.
- 4. Development shall not be used or occupied until a Certificate of Compliance is issued.
- 5. The permit will expire if no work is commenced within six months of issuance.
- 6. Applicant is hereby informed that other permits may be required to fulfill local, state, and federal requirements.
- 7. Applicant hereby gives consent to the Floodplain Administrator/Manager or his/her representative to make inspections to verify compliance.
- 8. I THE APPLICANT CERTIFY THAT ALL STATEMENTS HEREIN AND IN ATTACHMENTS TO THIS APPLICATION ARE, TO THE BEST OF MY KNOWLEDGE, TRUE AND ACCURATE.

APPLICANT'S SIGNATURE for CESO Inc
DATE 07/31/2014
SECTION 2: PROPOSED DEVELOPMENT (TO BE COMPLETED BY APPLICANT). IF THE APPLICANT IS NOT A NATURAL PERSON, THE NAME, ADDRESS, AND TELEPHONE NUMBER
OF A NATURAL PERSON WHO SHALL BE APPOINTED BY THE APPLICANT TO RECEIVE NOTICE PURSUANT TO ANY PROVISION OF THE CURRENT DODDRIDGE COUNTY FLOODPLAIN ORDINANCE.
APPLICANT'S NAME: Cone Gathering, LLC
ADDRESS: c/o Adam White, One Energy Drive PO Box 1248 Jane Lew, WV 26378 TELEPHONE NUMBER: 724.627.1300
CONTRACTOR NAME:
ADDRESS: TELEPHONE # WV CONTRACTOR LICENCE #
ENGINEER'S NAME: CESO, Inc.
ADDRESS: 2800 Corporate Exchange Drive, Suite 160, Columbus, OH 43231
TELEHONE NUMBER: 614.794.7080
PROJECT LOCATION:
NAME OF SURFACE OWNER/OWNERS (IF NOT THE APPLICANT) Please see Attachment A.
ADDRESS OF SURFACE OWNER/OWNERS (IF NOT THE APPLICANT) Please see Attachment A.
DISTRICT: Please see Attachment A.
LAND BOOK DESCRIPTION: Please see Attachment A.
DEED BOOK REFERENCE: Please see Attachment A.

TAX MA	P REFERENCE: F	Please see	Attachment A.				
EXISTIN	G BUILDINGS/U	SES OF F	PROPERTY: Please	see Attach	ment A.		
NAME (OF AT LEAST ON	E ADULT	TRESIDING IN EA	ACH RESI	DENCE L	OCATED UPON	THE SUBJECT
PROPER	TY Please see Atta	chment A.					
			ULT RESIDING IN	EACH R	ESIDENC	E LOCATED UPO	N THE SUBJECT
PROPER	TY Please see Atta	chment A.					
To avoid	d delay in proce	scina th	e application pla	aaca nro	uide eno	ugh information	to easily identify the
	location.	ssing tin	e application, pie	ease pro-	vide ello	ugii iiiioiiiiatioi	i to easily identity the
		one) is r	proposing to const	ruct new i	temnorar	v ahoveground w	aterline and associated
							rginia to support non-
							t of the intersection of State
							nates of the withdrawal
							point, the waterline will
transpo	ort water southeas	st to the C	OX11 well pad (39.	.170959 N	Latitude	, 80.762926 W Lo	ngitude (NAD83)).
DESCRI	PTION OF WOR	K (CHECK	ALL APPLICABL	E BOXES)		
A. STR	RUCTURAL DEVE	LOPME	NT				
ACTIVIT	Υ			STRUCT	TURAL T	YPE	
[]	New Structure				[]	Residential (1 -	- 4 Family)
[]	Addition				[]	Residential (mo	ore than 4 Family)
[]	Alteration				[]	Non-residentia	l (floodproofing)
[]	Relocation				[]	Combined Use	(res. & com.)
[]	Demolition				[]	Replacement	
[]	Manufactured	/Mobil H	Home				
_							
B. O1	THER DEVELOPL	MENT A	CTIVITIES:				
rı	Fill	[]	Mining	[]	Drilling	7	Pipelining
[] []	Grading	IJ	Muninig	IJ	Bullilling	Ŭ	ripelining
		ent for	STRUCTURAL DE	VELODM	IENT che	ocked above)	
[]	Excavation (except for STRUCTURAL DEVELOPMENT checked above) Watercourse Alteration (including dredging and channel modification)						
Ö	Drainage Improvements (including culvert work)						
	Road, Street, or Bridge Construction Subdivision (including new expansion)						
Ö							
Ö	Individual Wate	_	•				
Ö	Other (please s						
u	- 1 /p						

C. STANDARD SITE PLAN OR SKETCH

- 1. SUBMIT ALL STANDARD SITE PLANS, IF ANY HAVE BEEN PREPARED (ENGINEERING PLANS MUST BE SIGNED AND SEALED).
- 2. IF STANDARD SITE PLANS HAVE NOT BEEN PREPARED:
 SKETCH ON A SEPARATE 8 ½ X 11 INCH SHEET OF PAPER THE SHAPE AND LOCATION OF THE LOT. SHOW
 THE LOCATION OF THE INTENDED CONSTRUCTION OR LAND USE INDICATING BUILDING SETBACKS, SIZE
 & HEIGHT. IDENTIFY EXISTING BUILDINGS, STRUCTURES OR LAND USES ON THE PROPERTY.

3. SIGN AND DATE THE SKETCH. Please see Attachment B and Attachment C.
ACTUAL TOTAL CONSTRUCTION COSTS OF THE COMPLETE DEVELOPMENT/ PROPOSED CONSTRUCTION PROJECT WITHIN THE FLOODPLAIN \$ \$85,750.00
D. ADJACENT AND/OR AFFECTED LANDOWNERS: 1. NAME AND ADDRESS OF ALL OWNERS OF SURFACE TRACTS ADJACENT TO THE AREA OF THE SURFACE TRACT (UP & DOWN STREAM) UPON WHICH THE PROPOSED ACTIVITY WILL OCCUR AND ALL OTHER SURFACE OWNERS UP & DOWN STREAM) WHO OWN PROPERTY THAT MAY BE AFFECTED BY FLOODING AS IS DEMONSTRATED BY A FLOODPLAIN STUDY OR SURVEY (IF ONE HAS BEE COMPLETED. NAME: Please see Attachment D. ADDRESS: Please see Attachment D. ADDRESS: Please see Attachment D. ADDRESS:
NAME: NAME:
ADDRESS: ADDRESS:
1. NAME AND ADDRESS OF AT LEAST ONE ADULT RESIDING IN EACH RESIDENCE LOCATED UPON ANY ADJACENT PROPERTY AT THE TIME THE FLOODPLAIN PERMIT APPLICATION IS FILED AND THE NAM AND ADDRESS OF AT LEAST ONE ADULT RESIDING IN ANY HOME ON ANY PROPERTY THAT MAY BE AFFECTED BY FLOODING AS IS DEMONSTRATED BY A FLOODPLAIN STUDY OR SURVEY. NAME: Refer to Attachment D. NAME: ADDRESS: ADDRESS:
E. CONFIRMATION FORM THE APPLICANT ACKNOWLEDGES, AGREES, AND CONFIRMS THAT HE/IT WILL PAY WITHIN 30
DAYS OF RECEIPT OF INVOICE BY THE COUNTY FOR ALL EXPENSES RELATIVE TO THE PERMIT APPLICATION PROCESS GREATER THAN THE REQUIRED DEPOSIT FOR EXPENSES INCLUDING: (A) PERSONAL SERVICE OF PROCESS BY THE DODDRIDGE COUNTY SHERIFF AT THE RATES PERMITTED BY LAW FOR SUCH SERVICE.
(B) SERVICE BY CERTIFIED MAIL RETURN RECEIPT REQUESTED.(C) PUBLICATION.
(D) COURT REPORTING SERVICES AT ANY HEARINGS REQUESTED BY THE APPLICANT. (E) CONSULTANTS AND/OR HEARING EXPERTS UTILIZED BY DODDRIDGE COUNTY FLOODPLAIN ADMINISTRATOR/MANAGER OR FLOODPLAIN APPEALS BOARD FOR REVIEW OF MATERIALS AND/OR TESTIMONY REGARDING THE EFFICACY OF GRANTING OR DENYING THE APPLICANT'S FLOODPLAIN PERMIT.
NAME (PRINT): Natalie Hooton (for CESO/Inc)
SIGNATURE: DATE: 07/31/2014

After completing SECTION 2, APPLICANT should submit form and fees to Clerk of Doddridge County Court or his/her representative for review.

SECTION 3: FLOODPLAIN DETERMINATION (to be completed by Floodplain Administrator/Manager or his/her representative)

THE PROPOSED DEVELOPMENT: THE PROPOSED DEVELOPMENT IS LOCATED ON: Dated:-----Is NOT located in a Specific Flood Hazard Area (Notify applicant that the application review is complete and NO FLOOPLAIN DEVELOPMENT PERMIT IS REQUIRED). П Is located in Special Flood Hazard Area. FIRM zone designation 100-Year flood elevation is ______ NGVD . Stream name _____ Profile # _____ [] Unavailable [] The proposed development is located in a floodway. П See section 4 for additional instructions. DATE SIGNED SECTION 4: ADDITIONAL INFORMATION REQUIRED FOR DEVELOPMENT IN SPECIAL FLOOD HAZARD AREA (To be completed by Floodplain Administrator/Manager or his/her representative) The applicant must submit the documents checked below before the application can be processed. A plan showing the location of all existing structures, water bodies, adjacent roads and proposed development. Development plans, drawn to scale, and specifications, including where applicable: details for anchoring structures, storage tanks, proposed elevation of lowest floor, (including basement or crawl space), types of water resistant materials used below the first floor, details of flood proofing of utilities located below the first floor and details of enclosures below the first floor. Also____ Subdivision or other development plans (If the subdivision or development exceeds 10 lots or 2

acres, whichever is the lesser, the applicant must provide 100-year flood elevations if they are not

otherwise available).

[]	Plans showing the extent of watercourse relocation and/or landform alterations.
	Fop of new fill elevationFt. NGVD. For floodproofing structures applicant must attach certification from registered engineer or
archite	
	Certification from a registered engineer that the proposed activity in a regulatory floodway will it in any increase in the height of the 100-year flood. A copy of all data and calculations ng this finding must also be submitted.
	Manufactured homes located in a Flood Hazard Area must have a West Virginia Contractor's and a Manufactured Home Installation License as required by the Federal Emergency ment Agency (FEMA).
[]	Other:
	5: PERMIT DETERMINATION (To be completed by Floodplain Administrator/Manager or epresentative)
Flood	etermined that the proposed activity (type is or is not) in conformance with provisions of the in Ordinance adopted by the County Commission of Doddridge County on May 21, 2013. The issued subject to the conditions attached to and made part of this permit.
SIGNE	DATE
	oodplain Administrator/Manager found that the above was not in conformance with the as of the Doddridge County Floodplain Ordinance and/or denied that application, the applicant eal.
APPEA	Appealed to the County Commission of Doddridge County? [] Yes {} No Hearing Date: County Commission Decision - Approved [] Yes [] No
COND	
SECTION ISSUED	6: AS-BUILT ELEVATIONS (To be submitted by APPLICANT before Certificate of Compliance is
	owing information must be provided for project structures. This section must be completed by a ed professional engineer or a licensed land surveyor (or attach a certification to this application).
COMP	TE 1 OR 2 BELOW:
1	Actual (As-Built) Elevation of the top of the lowest floor (including basement or crawl space is FT. NGVD.
2	Actual (As Built) elevation of floodproofing isFT. NGVD.


Note: Any work performed prior to submittal of the above information is at risk of the applicant. SECTION 7: COMPLIANCE ACTION (To be completed by the Floodplain Administrator/Manager or his/her representative).


The Floodplain Administrator/Manager or his/her representative will complete this section as applicable based on inspection of the project to ensure compliance with the Doddridge County Floodplain Ordinance.

Ordinance. INSPECTIONS:
DATE: BY: DEFICIENCIES ? Y/N
COMMENTS
SECTION 8: CERTIFICATE OF COMPLIANCE (To be completed by Floodplain Administrator/Manager or his/her representative).
Certificate of Compliance issued: DATE:BY:
CERTIFICATE OF COMPLIANCE FOR DEVELOPMENT IN SPECIAL FLOOD HAZARD AREA (OWNER MUST RETAIN)
DEDMIT MUMAPED.
PERMIT NUMBER: PERMIT DATE:
PURPOSE —
CONSTRUCTION LOCATION:

OWNER'S ADDRESS:

THE FOLLOWING MUST BE COMPLETED BY THE FLOODPLAIN ADMINISTRATOR/MANAGER OR HIS/HER AGENT.
COMPLIANCE IS HEREBY CERTIFIED WITH THE REQUIREMENT OF THE FLOODPLAIN ORDINANCE ADOPTED BY THE COUNTY COMMISSION OF DODDRIDGE COUNTY ON MAY 21, 2013.
SIGNEDDATE

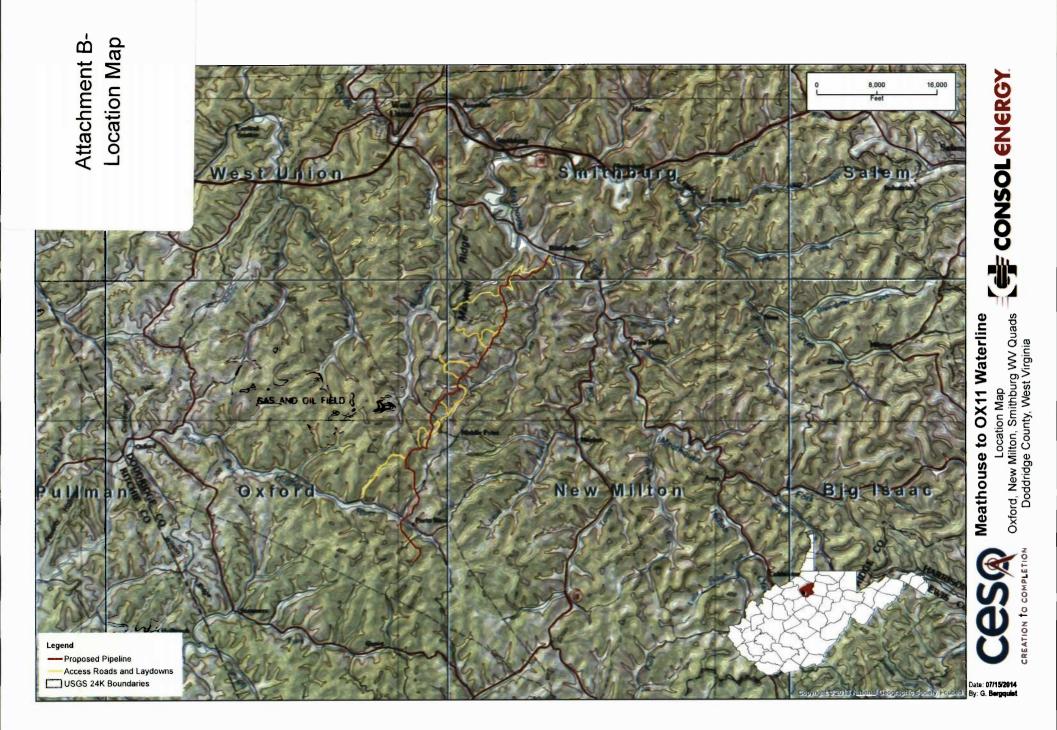

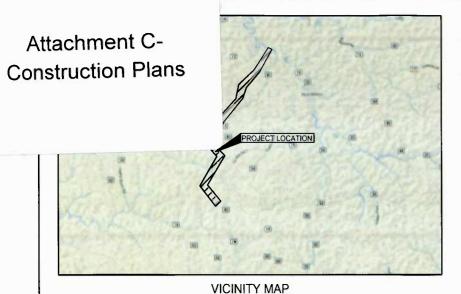

DODDRIDGE COUNTY, WEST VIRGINIA

APPROX, START POINT: STA 0+00 (NAD 83) LAT: 39.257067 N / LONG: 80.713272 W (UTM) (ZONE 17) NORTHING: 278064.45 / EASTING: 1624954.86

APPROX. END POINT: STA 448+73 (NAD 83) LAT: 39.171063 N / LONG: 80.763004 W (UTM) (ZONE 17) NORTHING: 246936.98 / EASTING: 1610433.50









NOTES:

THIS PLAN DOES NOT PURPORT TO BE A COMPREHENSIVE REPRESENTATION OF EXISTING UTILITIES IN THE PROJECT AREA. UTILITIES SHOWN ARE BEING PROVIDED FOR INFORMATIONAL UTILITIES IN THE PROJECT AREA. UTILITIES SHOWN ARE BEING PROVIDED FOR INFORMATIONAL PURPOSES ONLY, BASED ON SURFACE FEATURES OSSERVED IN THE FIELD. CESO, INC. MAKES NO GUARANTEE TO THEIR ACCURACY AND/OR COMPLETENESS. FORTY-EIGHT (48) HOURS BEFORE DIGGING IS TO COMMENCE, THE CONTRACTOR SHALL NOTIFY THE STATEWIDE ONE CALL SYSTEM, MISS UTILITY OF WEST VIRGINIA, INC. (WV811) AT 1-800-245-4848. THE CONTRACTOR SHALL ALSO NOTIFY ALL OTHER AGENCIES WHICH MIGHT HAVE UNDERGROUND UTILITIES IN THE PROJECT AREA AND ARE NON-MEMBERS OF WV811.

2. QUANTITIES LISTED ARE BASED ON SLOPE LENGTH. CONTRACTOR SHALL VERIFY ALL

UTILITY OWNERS

- NOTES:

 1. CONTRACTOR SHALL CALL THE STATEWIDE ONE CALL SYSTEM, MISS UTILITY OF WEST VIRGINIA, INC. (MV811) AT 1-800-245-4848 72 HOURS PRIOR TO CONSTRUCTION AND SHALL NOTIFY ALL UTILITY COMPANIES AT LEAST 48 HOURS PRIOR TO WORK IN THE VICINITY OF THEIR UNDERGROUND LINES.
- UTILITIES SHOWN ARE TAKEN FROM THE SURVEY AND RECORDS OF RESPECTIVE UTILITY
 COMPANIES AND DO NOT NECESSARY REPRESENT ALL UNDERGROUND UTILITIES ADJACENT
 TO OR UPON SITE SHOWN ON PLAN, IT SHALL BE THE RESPONSIBILITY OF THE CONTRACTOR
 TO LOCATE ALL EXISTING UTILITIES WHETHER SHOWN HEREIN OR NOT AND TO PROTECT THE
 FROM DAMAGE.

CONSOL ENERGY ONE ENERGY DRIVE JANE LEW, WV 26378 ADAM WHITE 240-506-7299

KEY OIL COMPANY 22 GARTON PLAZA WESTON, WV 304-269-7102

ECA / EAE 501 56th STREET SOUTH EAST

DOMINION TRANSMISSION 445 W MAIN STREET CLARKSBURG, WV 26301

STEVEN D. GUM 304-782-5024 Steven.D.Gum@dom.com

ARMSTRONG TELEPHONE 600 EAST NORTH STREET HARRISVILE, WV 26362 1-877-277-5711

ANTERO RESOURCES 981 E WASHINGTON AVE ELLENBORO, WV 26346 304-869-3405 RYAN BAKER

P.O. BOX 1550

ROUTE 19 SOUTH AT OAKMOUND RD

RBAKER@ANTERORESOURCES COM

PENNZOIL 1-800-344-660



APPROVED BY CONSOL:

REPRESENTATIVE

DATE

DRAWING INDEX DESCRIPTION SHEET NUMBER COVER SHEET SWPPP DETAILS 6-22 WATERLINE PLAN ROAD CROSSING DETAILS 23-25 ACCESS ROAD PLAN AND PROFILES 26-49 **EROSION AND SEDIMENT CONTROL TABLES** 50-56 EARTHWORK AND QUANTITIES

VERTICAL DATUM NOTE

VERTICAL CONTROL IS BASED UPON THE NORTH AMERICAN VERTICAL DATUM OF 1983

PLAN REPRODUCTION WARNING

THE PLANS HAVE BEEN CREATED ON ANSI D (22"x 34") SHEETS. FOR REDUCTIONS, REFER

CHAMADY OF MATERIALS

THE PLANS HAVE BEEN CREATED FOR FULL COLOR PLOTTING, ANY SET OF THE PLANS THAT IS NOT PLOTTED IN FULL COLOR SHALL NOT BE CONSIDERED ADEQUATE FOR CONSTRUCTION PURPOSES.

NING** INFORMATION MAY BE LOST IN COPYING AND/OR GRAY SCALE PLOTTING.



SUMMENT OF MATERIALS		ART OF WATERIALS	I KE	ERENCE DIAWINGS	1		REVISIONS
MRKR#	QTY.	DESCRIPTION	DWG.	DESCRIPTION	NO.	DATE	DESCRIPTION
1		18" HDPE WATERLINE					
2	152 EA	Elbow, 45° Segmentable Fitting		·			
				-02-01		7	
					Γ		

DEEEDENCE DOAWINGS

DEVISIONS



MEATHOUSE TO OX11 WATERLINE

COVER SHEET



200 EVERGREENE DRIVE WAYNESBURG, PA 15370

DATE:	07/29/14
JOB NO.:	750589
DESIGN:	BEM
DRAWN:	BEM
CHECKED:	ВЈМ
SHEET NO.	

CONTRACTOR NOTES

- THIS PLAN DOES NOT PURPORT TO BE A COMPREHENSIVE REPRESENTATION OF EXISTING UTILITIES IN
 THE PROJECT AREA. UTILITIES SHOWN ARE BEING PROVIDED FOR INFORMATIONAL PURPOSES ONLY.
 BASED ON SURFACE FEATURES OBSERVED IN THE FIELD. CESO, INC. MAKES NO GUARANTEE TO THEIR
 ACCURACY ANDIOR COMPLETENESS. FORTY-EIGHT (48) HOURS BEFORE DIGGING IS TO COMMENCE, THE
 CONTRACTOR SHALL NOTIFY THE STATEWIDE ONE CALL SYSTEM, MISS UTILITY OF WEST VIRGINIA, INC.
 (WV811) AT 1-800-245-4848. THE CONTRACTOR SHALL ALSO NOTIFY ALL OTHER AGENCIES WHICH MIGHT
 HAVE UNDERGROUND UTILITIES IN THE PROJECT AREA AND ARE NON-MEMBERS OF WV811.
- 2. ALL CONTRACTORS/SUBCONTRACTORS PERFORMING WORK ON THIS PROJECT SHALL FAMILIARIZE THEMSELVES WITH THE SITE AND SHALL BE SOLELY RESPONSIBLE FOR ANY DAMAGE TO EXISTING FACILITIES RESULTING DIRECTLY OR INDIRECTLY FROM THEIR OPERATIONS. SAID EXISTING IMPROVEMENTS SHALL INCLUDE, BUT NOT BE LIMITED TO, BERMS, DITCHES, FENCES AND PLANTS. ANY REMOVAL OR DAMAGE TO EXISTING IMPROVEMENTS SHALL BE REPLACED OR REPAIRED BY THE CONTRACTORS TO EXISTING OR BETTER CONDITIONS, AT THEIR EXPENSE, AND SHALL BE APPROVED BY THE OWNER.
- ALL CONSTRUCTION, TESTING AND MATERIALS SHALL MEET OR EXCEED ALL REQUIREMENTS OF THE "PERMITTING ENTITY" AND LOCAL, STATE AND FEDERAL REGULATIONS.
- ALL NECESSARY TESTING SHALL BE PERFORMED BY AN APPROVED LABORATORY AT THE EXPENSE OF THE CONTRACTOR
- PRIOR TO CONSTRUCTION, ALL CONTRACTORS SHALL FAMILIARIZE THEMSELVES WITH THE CONTRACT DOCUMENTS AND SPECIFICATIONS AND ALL OTHER NECESSARY DETAILS, AND SPECIFICATIONS RELEVANT TO THE PROPER COMPLETION OF THE WORK SPECIFIED, FAILURE ON THE PART OF THE CONTRACTOR TO FAMILIARIZE THEMSELVES WITH ALL STANDARDS OR SPECIFICATIONS PERTAINING TO THIS WORK SHALL IN NO WAY RELIEVE THE CONTRACTOR OF RESPONSIBILITY FOR PERFORMING THE WORK IN ACCORDANCE WITH ALL SUCH APPLICABLE STANDARDS AND SPECIFICATIONS.
- 6. THE CONTRACTOR SHALL HAVE IN THEIR POSSESSION, PRIOR TO CONSTRUCTION, ALL NECESSARY PERMITS, LICENSES, BONDS, INSURANCE, ETC. CONTRACTORS SHALL EACH HAVE AT LEAST ONE SET OF APPROVED ENGINEERING PLANS AND SPECIFICATIONS ON-SITE AT ALL TIMES.
- 7. IN THE EVENT THAT AN ITEM IS NOT SPECIFICALLY COVERED IN THE PERTINENT AGENCIES CONSTRUCTION STANDARDS AND SPECIFICATIONS AND DETAILS, THE CONTRACTOR SHALL NOTIFY THE OWNER AND PROJECT ENGINEER. THE OWNER SHALL HAVE THE FINAL DECISION ON ALL CONSTRUCTION MATERIALS, METHODS AND PROCEDURES.
- 8. THE CONTRACTORS MUST CONFINE THEIR ACTIVITIES TO THE WORK AREA AS SHOWN ON THE PLANS. NO ENCROACHMENTS OUTSIDE OF THE SPECIFIED AREAS SHALL BE ALLOWED, ANY DAMAGE RESULTING THERE FROM SHALL BE THE CONTRACTOR'S RESPONSIBILITY TO REPAIR.
- If WILL BE THE RESPONSIBILITY OF THE CONTRACTOR TO PROTECT ALL EXISTING PUBLIC AND PRIVATE UTILITIES THROUGHOUT THE CONSTRUCTION OF THE PROJECT. THE CONTRACTOR SHALL CONTACT THE APPROPRIATE UTILITY COMPANIES OR LINE LOCATION SERVICES PRIOR TO COMMENCEMENT OF CONSTRUCTION AND SHALL ASSUME FULL LIABILITY TO THOSE COMPANIES FOR ANY DAMAGES CAUSED TO THEIR FACILITIES.
- TRENCH BEDDING SHALL BE AS PER WYDOH CONSTRUCTION AND MATERIAL SPECIFICATIONS, LATEST EDITION.
- 11. TOP OF NATURAL GAS PIPELINE SHALL BE A MINIMUM OF 3"-0" BELOW THE FINISHED GROUND ELEVATION IN ALL VEGETATED AREAS, EXCEPT IN AGRICULTURAL FIELDS, WHICH THE DEPTH SHALL BE 4"-0". MINIMUM BURY UNDER ROADWAYS AND OTHER PAYED AREAS SHALL BE PER THE PERMITTING AUTHORITIES SPECIFICATIONS AND THE ASSOCIATED PERMIT & DRAWINGS.
- THE CONTRACTOR SHALL BE RESPONSIBLE FOR MAINTAINING TRENCH SAFETY REQUIREMENTS IN ACCORDANCE WITH STANDARD TRENCH SAFETY GUIDELINES AND THE U.S. DEPARTMENT OF LABOR AND OCCUPATIONAL SAFETY AND HEALTH ADMINISTRATION (OSHA) STANDARDS.
- THESE PLANS DO NOT CONSTITUTE A BOUNDARY SURVEY, BOUNDARY LINES AS SHOWN HEREON ARE BASED ON TAX MAPS AS PROVIDED BY OWNER.
- THE CONTRACTOR IS RESPONSIBLE FOR NOTIFICATION TO THE PROJECT MANAGER FOR ANY DEVIATION
 FOUND RELATIVE TO THE PROJECT.
- 15. EXISTING EASEMENTS AND/OR RIGHT-OF-WAYS WERE NOT RESEARCHED AND SURVEYED DURING THIS PROJECT, OTHER THAN THOSE SHOWN WITHIN THE PLANS.
- FENCE LINES ENCOUNTERED DURING CONSTRUCTION SHOULD BE RELOCATED AND REPLACED PER LANDOWNER AND OWNER'S REPRESENTATIVE.
- 17. THE CONTRACTOR SHALL BE RESPONSIBLE FOR NOTIFYING THE GOVERNING AUTHORITIES PRIOR TO ALL ROAD CROSSINGS, MAINTENANCE OF TRAFFIC IS TO BE IMPLEMENTED AS NECESSARY TO ENSURE THAT THE ROAD HAS CONTINUAL ACCESS. MAINTENANCE OF TRAFFIC SHALL BE PER THE LATEST EDITION OF THE WUYDOH TEMPORARY TRAFFIC CONTROL FOR STREETS AND HIGHWAYS MANUAL.

GENERAL CONSTRUCTION SEQUENCE

THE PIPELINE PROJECT CONSISTS OF ONE GENERAL CONSTRUCTION PHASE. ALL EROSION AND SEDIMENT CONTROL MEASURES SHALL BE INSTALLED IN ACCORDANCE WITH THE APPROVED PLANS AND THE WEST VIRGINIA DEPARTMENT OF NATURAL RESOURCES (WYDNR) AND WEST VIRGINIA DEPARTMENT OF ENVIRONMENTAL PROTECTION (MYDEP) EROSION AND SEDIMENT CONTROL FIELD MANUAL

THE CONSTRUCTION SEQUENCE IS INTENDED AS A GENERAL COURSE OF ACTION TO COMPLY WITH WYONR AND WEST VIRGINIA DEPARTMENT OF ENVIRONMENTAL PROTECTION (MYDEP) EROSION AND SEDIMENT CONTROL REGULATIONS. THE CONTRACTOR IS RESPONSIBLE FOR ENSURING THAT ALL MEASURES NECESSARY TO MEET APPLICABLE RULES AND REGULATIONS ARE INSTALLED. MEASURES AS SHOWN ON THESE PLANS MAY BE ALTERED TO BETTER MEET SITE SPECIFIC CONDITIONS AT THE DISCRETION OF THE CONTRACTOR

BMP DETAILS AND CONSTRUCTION SPECIFICATIONS CAN BE FOUND ON THE STANDARD DETAIL SHEETS.

- 1. A COPY OF THE FOR CONSTRUCTION PLANS MUST BE AVAILABLE ON THE PROJECT SITE AT ALL TIMES.
- AT LEAST THREE DAYS PRIOR TO STARTING ANY EARTH DISTURBANCE ACTIVITY, ALL CONTRACTORS INVOLVED IN THESE ACTIVITIES SHALL NOTIFY THE WEST VIRGINIA ONE CALL SYSTEM BEFORE STARTING ANY CONSTRUCTION ACTIVITIES.
- 3. PRIOR TO COMMENCEMENT OF ANY EARTH DISTURBANCE ACTIVITIES, INCLUDING CLEARING AND GRUBBING, CONTRACTOR SHALL CLEARLY DELINEATE SENSITIVE AREAS, RIPARIAN FOREST BUFFER BOUNDARIES, THE LIMITS OF CLEARING, AND TREES THAT ARE TO BE CONSERVED WITHIN THE PROJECT SITE, AND INSTALL APPROPRIATE BARRIERS WHERE EQUIPMENT MAY NOT BE PARKED, STAGED, OPERATED OR LOCATED FOR ANY PURPOSE, APPROPRIATE BMP'S SHOULD BE INSTALLED AND EJINICTIONING.
- CONSTRUCTION FENCE SHALL BE INSTALLED AT LOCATIONS SHOWN ON THE PLANS. CONSTRUCTION
 FENCE SHALL BE CHECKED REGULARLY FOR WEATHER RELATED OR OTHER DAMAGE, ANY NECESSARY
 REPAIRS SHALL BE MADE IMMEDIATELY.
- INSTALLATION OF STONE CONSTRUCTION ENTRANCES AT ALL ACCESS LOCATIONS SHALL BE THE FIRST STEP OF CONSTRUCTION AND SHALL BE FOLLOWED BY INSTALLATION OF BMP's FOR ALL AREAS DESIGNATOR FOR ECHIPMENT AND MATERIAL STACKING.
- 6. INSTALL ROCK CHECK DAMS AT LOCATIONS SHOWN ON THE PLANS. INSPECT EACH CHECK DAM AT A MINIMUM ONCE EVERY SEVEN DAYS AND WITHIN 24 HOURS AFTER ANY STORM EVENT GREATER THAT 0.5 INCHES OF RAIN PER 24 HOUR PERIODS. CHECK TO SEE! IF WATER HAS FLOWED AROUND THE EDGE OF THE STRUCTURE. REPLACE STONE AND REPAIR DAM AS NECESSARY TO MAINTAIN THE CORRECT HEIGHT AND CONFIGURATION. SEDIMENT SHALL BE REMOVED FROM BEHIND THE CHECK DAMS WHEN IT HAS ACCUMULATED TO ONE HALF OF THE ORIGINAL HEIGHT OF THE DAM.
- INSTALL PERIMETER BMP's (SILT FENCING OR FILTER SOCKS) WHERE NECESSARY ALONG CLEARING AND GRUBBING BOUNDARIES.
- BEGIN LAND CLEARING AND GRADING (IF NECESSARY) ONLY AFTER ALL DOWNSLOPE BMP's HAVE BEEN INSTALLED. IF POSSIBLE, MINIMIZE CLEARING AND GRADING AT STREAM CROSSINGS UNTIL THE TIME OF CROSSING
- 9. APPLY TEMPORARY OR PERMANENT STABILIZATION MEASURES IMMEDIATELY TO ANY DISTURBED AREAS WHERE WORK HAS REACHED FINAL GRADE, HAS BEEN DELAYED OR OTHERWISE TEMPORARILY
- INSTALL TEMPORARY WATERBARS AT LOCATIONS SHOWN ON THE DRAWINGS, WATERBARS WILL BE INSTALLED WITH FILTER SOCKS AT THE DISCHARGE TO HELP CONTROL THE VOLUME AND SPEED OF
- 11. INSTALL BMP's FOR TEMPORARY ROAD CROSSINGS OF WETLANDS AND WATER BODIES WITHIN THE PIPELINE ROW AS NECESSARY. FOLLOW STREAM AND WETLAND CROSSING DETAILS FOR ACCESS ROAD CROSSINGS OF THESE FEATURES. FILTER SOCKS SHALL BE USED AT ALL STREAM CROSSINGS, SEE STREAM CROSSING PROCEDURES AND WETLAND CROSSINGS PROCEDURES FOR ADDITIONAL INFORMATION ON WATER BODY AND WETLAND CROSSINGS.
- 12. CONSTRUCTION OF UTILITIES (INSTALL NATURAL GAS PIPELINE). WHEN TRENCH EXCAVATION TAKES PLACE IN AN AGRICULTURAL, WETLAND, OR RESIDENTIAL AREA, THEN SEGREGATION OF TOPSOIL AND SUBSOIL WILL BE PERFORMED. FOLLOW STREAM AND WETLAND CROSSING DETAILS LOCATED ON THE EROSION AND SEDIMENT CONTROL DRAWINGS FOR UTILITY CROSSINGS OF THESE FEATURES. SEE STREAM CROSSING PROCEDURES AND WETLAND CROSSING PROCEDURES FOR ADDITIONAL INFORMATION ON WATER BODY AND WETLAND CROSSING, DURING CONSTRUCTION, INSTALL AND MAINTAIN ANY ADDITIONAL EROSION AND SEDIMENT CONTROL BMP'S AND IMPLEMENT STRUCTURAL POST CONSTRUCTION STORMWATER BMP'S (PERMANENT WATERBARS) THAT MAY BE REQUIRED. SEE UTILITY UINE INSTALLATION REQUIREMENTS NOTES FOR LIMITS OF WORK.
- ANY WATER ENCOUNTERED WITHIN THE EXCAVATION AREAS DURING CONSTRUCTION SHALL BE REMOVED BY USING PUMPS, HOSES, AND PUMPED WATER FILTER BAGS WHICH SHALL BE DISCHARGED INTO UNDISTURBED WELL-VEGETATED UPLAND AREAS.
- 14. BACKFILL AREAS EXCAVATED FOR THE INSTALLATION OF UTILITIES WITH SUITABLE EXCAVATED MATERIAL, IN AREAS WHERE TOPSOIL HAS BEEN SEGREGATED, THE SUBSOIL SHALL BE REPLACED FIRST, FOLLOWED BY THE TOPSOIL BEING SPREAD OVER THE AREA FROM WHICH IT WAS REMOVED, FINAL GRADES SHALL BE THE SAME AS PRE-CONSTRUCTION CONTOURS.
- 15. AFTER CONSTRUCTION IS COMPLETE, FINAL SEEDING AND MULCHING OF ALL DISTURBED AREAS NOT YET STABILIZED SHALL BE COMPLETED. INSTALL EROSION CONTROL BLANKETING ON SLOPES WHICH ARE 3:1 OR STEEPER. STABILIZE AND SEED ALL OPEN AREAS INCLUDING BORROW AND SPOIL AREAS.
- REMOVAL OF ALL TEMPORARY BMP's CAN BE PERFORMED UPON ACHIEVEMENT OF A UNIFORM 70
 PERCENT PERENNIAL VEGETATIVE COVER WITH A DENSITY CAPABLE OF RESISTING ACCELERATED
 EROSION FOR ALL AREAS WHICH WOULD CONTRIBUTE RUNOFF TO THE BMP's. STABILIZE ANY
 OISTURBANCES ASSOCIATED WITH THE REMOVAL OF THE BMP's.

STREAM CROSSING (TEMPORARY) CONSTRUCTION SEQUENCE - ACCESS ROADS

- ALL IN STREAM DISTURBANCE ACTIVITY SHALL PROCEED IN ACCORDANCE WITH THE FOLLOWING SEQUENCE, EACH STAGE SHALL BE COMPLETED IN COMPLIANCE WITH WYDEP, THE WEST VIRGINIA OFFICE OF LIND AND STREAMS (WYOLS), THE WIDNR, AND THE U.S. ARMY CORPS OF ENGINEERS (USACE) RULES AND REGULATIONS.
- STREAM CROSSING SHALL MEET THE REQUIREMENTS OF THE WYDEP'S OFFICE OF CONSTRUCTION STORMWATER EROSION AND SEDIMENT CONTROL BEST MANAGEMENT PRACTICE MANUAL CHAPTER 3.21.
- 3. INSTALL TIMBER MATS AS SHOWN ON PLANS
- 4. INSTALL ACCESS ROAD TEMPORARY CROSSING AS SHOWN ON PLANS.
- 5. REMOVE COFFERDAM AND STABILIZE ANY REMAINING DISTURBED AREAS.

UTILITY LINE INSTALLATION REQUIREMENTS

- THE CONTRACTOR SHALL LIMIT TRENCH EXCAVATION TO THE LENGTH OF PIPE PLACEMENT AND BACKFILL THAT CAN BE INSTALLED IN ONE DAY.
- THE CONTRACTOR SHALL GRADE TO FINAL CONTOURS, INSTALL REQUIRED EROSION CONTROL MEASURES, AND SEED AND MULCH ALL DISTURBED AREAS AT THE END OF EACH WEEK.
- DEWATER ALL TRENCHES PRIOR TO PIPE INSTALLATION AND BACKFILLING. ALL WATER TO BE PUMPED INTO A SEDIMENT FILTER BAG.
- 4. ALL TRENCH EXCAVATION MATERIAL TO BE PLACED ON DOWNHILL SIDE OF TRENCH.
- IN THE EVENT THAT THESE REQUIREMENTS CAN'T BE MET DUE TO FIELD CONDITION, THE CONTRACTOR SHALL COORDINATE ALTERNATE REQUIREMENTS WITH OWNER'S REPRESENTATIVE.

UTILITY RIGHT-OF-WAY RESTRICTIONS

- CONSTRUCTION VEHICLES. VEHICLES WITH BOOMS AND EQUIPMENT OPERATING WITHIN OR ADJACENT TO A UTILITY RIGHT-OF-WAY MUST BE PROPERLY GROUNDED.
- 2. CHANGES TO GRADE ELEVATION WITHIN THE UTILITY RIGHT-OF-WAY ARE NOT PERMITTED.
- GROUND DISTURBANCE OR EXCAVATIONS ARE NOT PERMITTED WITHIN 50 FEET OF ANY UTILITY STRUCTURES (POLES, TOWERS, GUYS, ETC.)
- EXPLOSIVES OR COMBUSTIBLE LIQUIDS, SUBSTANCES, OR MATERIALS ARE NOT PERMITTED WITHIN THE RIGHT-OF-WAY, PROHIBITED MATERIALS INCLUDE BUT ARE NOT LIMITED TO FUEL, WOOD CHIPS, MULCH, BRUSH, AND TIRES.

IFO	s	UMMARY	OF MATERIALS	REFER	RENCE DRAWINGS		R	EVISIONS
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MEATHOUSE TO OX11 WATERLINE

SWPPP NOTES


STATION(S)


CONSOL ENERGY


200 EVERGREENE DRIVE WAYNESBURG, PA 15370

DATE:	07/29/14
JOB NO.:	750589
DESIGN:	вем
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CHECKED:	ВЈМ
SHEET NO.	


UPROJECTSICONSOL ENERGY/150589-01 - OX11 - MEATHOUSE FORK WATER LINE/03-CIVIL/PLAM/PIPELINE/150589-MEATHOUSE-OX11 TABLES,DWG - 7/30/2014 4:29 PM

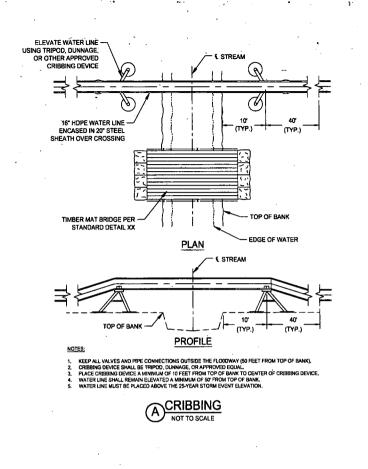


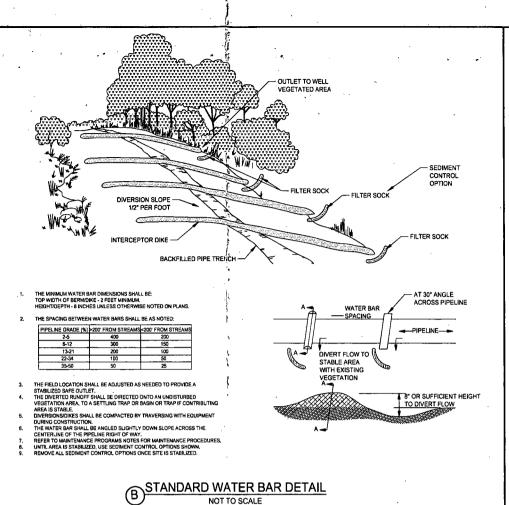


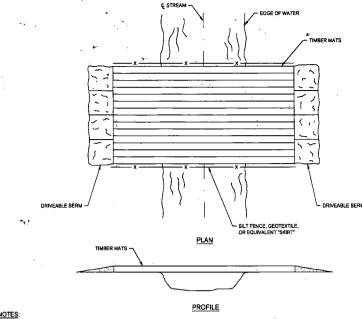

- 1. THIS TYPE OF BRIDGE IS GENERALLY USED FOR SMALL STREAM CROSSINGS LESS THAN 20 FEET IN WIDTH IN COMBINATION WITH A PROPER STREAM BANK CONFIGURATION.
- 2. BRIDGE WILL BE TEMPORARILY REMOVED IF HIGH WATER RENDERS IT UNSAFE FOR CROSSING.
- 3. BRIDGE TO REMAIN IN PLACE UNTIL THE COMPLETION OF FINAL RESTORATION.
- 4. SILT FENCE, SAND BAGS, DRIVABLE BERMS, OR OTHER APPROPRIATE EROSION CONTROL MAY BE USED INTERCHANGEABLY.
- 5. A *SKIRT* FORMED OF SILT FENCE, GEOTEXTILE FABRIC, OR EQUIVALENT SHALL BE PLACED ON THE SIDES AND BOTTOM OF THE BRIDGE TO TRAP
- 6. INDIVIDUAL MATS SHALL BE ANCHORED AND BUTTED TIGHTLY TO MINIMIZE THE INTRODUCTION OF SEDIMENT TO THE WATERBODY.

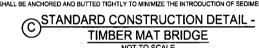


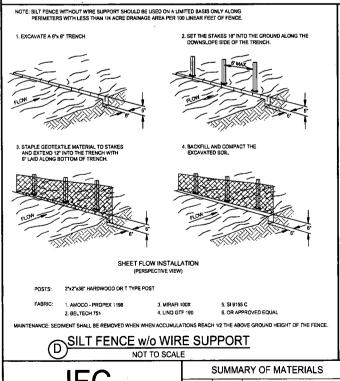

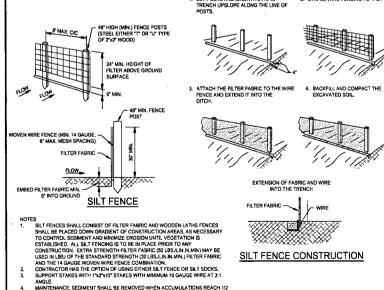

(E) REINFORCED (30" HIGH) SILT FENCE DETAIL

NOT TO SCALE

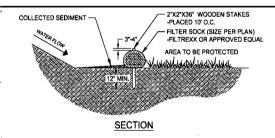


NOT TO SCALE

- FILTER SOCKS SHALL BE PLACED ON A LEVEL LINE ACROSS SLOPES
- FILTER SOCKS ARE NOT TO BE USED IN CONCENTRATED FLOW SITUATIONS OR IN RUNOFF CHANNELS

- ROUTINELY INSPECT FILTER SOCKS AFTER A RUNOFF EVENT, MAINTAINING FUNCTIONALITY AT ALL TIMES.
- REMOVE SEDIMENT COLLECTED AT THE BASE OF THE UPSLOPE SIDE OF THE FILTER SOCK WHEN SEDIMENT ACCUMULATION HAS REACHED 1/3 OF THE EXPOSED HEIGHT OF THE SOCK.
- WHERE THE FILTER SOCK IS DAMAGED, DETERIORATED, OR FAILS, IT SHALL BE REPAIRED OR REPLACED WITH MORE EFFECTIVE ALTERNATIVE.
- THE FILTER MEDIA WITHIN THE FILTER SOCK SHALL BE DISPERSED ON SITE ONCE THE DISTURBED AREA HAS BEEN PERMANENTLY STABILIZED, OR WHEN NO LONGER REQUIRED IN SUCH A WAY AS TO FACILITATE AND NO OSSTRUCT SEEDING.



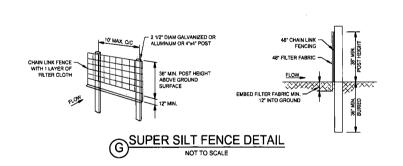

/ NOI 1	O SCALE							
IFA		SUMMARY	OF MATERIALS	REFE	RENCE DRAWINGS		RI	EVISIONS
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MEATHOUSE TO OX11 WATERLINE

SWPPP DETAILS

CONSOL ENERGY

200 EVERGREENE DRIVE WAYNESBURG, PA 15370

DATE:	07/29/14
JOB NO.:	750589
DESIGN:	ВЕМ
DRAWN:	ВЕМ
CHECKED:	ВЈМ
SHEET NO.	

EROSION AND SEDIMENT CONTROL NARRATIVE:

PLAN DESIGNER: CESO, INC 2800 CORPORATE EXCHANGE DRIVE, SUITE 160 COLUMBUS, OH 43231 JANE LEW, WV 26378

CONTACT: ADAM WHITE CONTACT: BENJAMIN J. MILLER, PE

: 240-506-7299 E: ADAMWHITE@CONSOLENERGY.COM E: MILLER@CESOINC.COM

WV DEP PERMIT # PROJECT DESCRIPTION:

XXXXXXXX

THIS PROJECT CONSISTS OF CONSTRUCTING AN ABOVE AROUND WATER LINE IN DODDRIDGE COUNTY, WEST VIRGINIA.

58.35 ACRES TOTAL PROJECT AREA

O ACRES PROPOSED IMPERVIOUS AREA

10,523 CY CUT/ 10,429 CY FILL (94 CY SPOIL - TO BE SPOILED IN TAR-7 LAY YARD)

REQUIREMENTS FOR WORKING IN OR NEAR CRITICAL AREAS CAN BE FOUND ON SHEETS 2-5.

EXISTING SITE CONDITIONS:

THE TOPOGRAPHY OF THIS SITE CONSISTS OF MANY RIDGES AND VALLEYS. THIS SITE CONSISTS PREDOMINATELY OF WOODS AND OPEN FIELDS. THIS SITE DRAINS TO S FORK HUGHES RIVER, MEATHOUSE FORK,

ADJACENT AREAS:

ADJACENT AREAS THAT MAY BE AFFECTED BY SITE DISTURBANCE INCLUDE WETLAND G71, STREAM G72, STREAM G73, WETLAND A, WETLAND B, WETLAND C, STREAM 3, STREAM 4, STREAM 5, WETLAND G 54, STREAM G54, STREAM G51, STREAM G49, STREAM G47, STREAM G45, STREAM G45, STREAM G43, STREAM G40, STREAM G39, STREAM G39, WETLAND G37, WETLAND G34, WETLAND G63, WETLAND C6, WET STREAM EH, WETLAND EM, STREAM EJ, STREAM EH, WETLAND G29, STREAM G60, WETLAND G61, WETLAND G63, STREAM CE, CR 13/3, MAXWELL RIDGE RD (CR 13), CAIN RUN RD (CR 49), AND S FORK HUGHES RIVER

THE DRAINAGE PATH LEADING FROM THE SITE TO THE RECEIVING BODY OF WATER CONSISTS OF VEGETATED SWALES, EXISTING EROSIONAL FEATURES, AND TRIBUTARIES OF STREAMS,

CRITICAL AREAS:

PIPELINE: STREAM 1 (MEATHOUSE FORK), WETLAND E. STREAM G.S. STREAM GSS. STREAM

STREAM CC, STREAM ZZ, STREAM ZA, STREAM G62, STREAM G64, STREAM G65, STREAM G66, STREAM G67, STREAM G68, AND STREAM CF.

SOILS

Soil name	Soil Mapping Unit	Erodibility (K Factor, Whole Soil)	Settleshility	Permeability	Depth (cm)	Texture	Soil Structure (Unavailable)
CHAGRIN SILT LOAM	Ch	0.37	,	Well drained	>200	Silt loam	
GILPIN-PEABODY COMPLEX, 25 TO 35 PERCENT SLOPES	GpE	0.43		Well drained	69	Silt loam	•
GILPIN-PEABODY COMPLEX, 15 TO 35 PERCENT SLOPES, VERY STONY	GsE	0.37		Well drained	84	Silt loam	
GILPIN-PEABODY COMPLEX, 35 TO 70 PERCENT SLOPES, VERY STONY	GsF	0.37		Well drained	84	Silt loam	
GILPIN UPSHUR COMPLEX, 8 TO 15 PERCENT SLOPES	GuC	0.43		Well drained	84	Silt loam	
GILPIN UPSHUR COMPLEX, 15 TO 25 PERCENT SLOPES	GuD	0.43		Well drained	84	Silt loam	·
MONONGAHELA SILT LOAM, B TO 15 PERCENT SLOPES	MoC	0.43		Moderately well drained	56	Silt loam	
SENSABAUGH SILT LOAM	Se	0.37	-	Well drained	>200	Silt loam	-
SENSABAUGH SILT LOAM, 3 TO 8 PERCENT SLOPES, RARELY FLOODED	SeB	0.37		Well drained	>200	Silt Ipam	
VANDALIA SILT LOAM, 15 TO 25 PERCENT SLOPES	VaD	0.32	-	Well drained	>200	Silt loam	-
VANDALIA ŞILT LOAM, 25 TO 35 PERCENT SLOPES	VaE	0.49	-	Well drained	>200	Silt loam	
VANDALIA SILT LOAM, 15 TO 35 PERCENT SLOPES, VERY STONY	VsE	0.49	-	Well drained	>200	Silt loam	· -

*Data obtained from NRCS-USDA Web Soil Survey

EROSION PROBLEM AREAS: POTENTIAL EROSION PROBLEMS ON THIS SITE EXIST ALONG STEEP SLOPES WHERE THE PIPELINE WILL BE LAID.

CONSTRUCTION STORMWATER THE SEDIMENT CONTROL PLAN SHOWS ALL CLEARING LIMITS AND PROPOSED SEDIMENT CONTROLS. THE GENERAL NOTES ADDRESS THE STABILIZATION OF SOILS, SLOPE PROTECTION, CONTROL OF OTHER POLLUTANTS, DEWATERING CONTROL, MAINTENANCE OF BMPs, MANAGEMENT OF THE PROJECT, AND STABILIZATION. TYPES OF BMPs USED ON THIS PROJECT INCLUDE FILTER SOCKS, WATER BARS, SUPER SILT FENCE AND SILT FENCE. REFER TO SHEETS 6-49 FOR LOCATIONS.

SCHEDULE:

CONSTRUCTION PHASING AND THE CONSTRUCTION SEQUENCE FOR THIS PROJECT CAN BE FOUND ON SHEET 2, WET SEASON CONSTRUCTION ACTIVITIES INCLUDE BUT ARE NOT LIMITED TO CLEARING, EROSION & SEDIMENT CONTROL INSTALLATION, ACCESS ROAD CONSTRUCTION, TRENCH EXCAVATION, UTILITY PLACEMENT, BACKFILLING, AND OPEN CUTTING OF STREAMS, CONSTRUCTION RESTRAINTS FOR ENVIRONMENTALLY CRITICAL AREAS CAN BE FOUND ON SHEET 2.

ENGINEERING CALCULATIONS: ENGINEERING CALCULATIONS ARE NOT REQUIRED FOR THIS PROJECT.

÷	EMPORARY SEEDING CHART		PLS
Common Name	Scientific Name	Planting Dates	Lbs/Acre
Annual Ryegrass	Lolium multiflorum	2/16-5/15, 8/1-11/1	40
Field Bromegrass	Bromus ciliatus	3/1-6/15, 8/1-9/15	40
Spring Oats	Avena sativa	3/1-6/15	100
Winter Rye	Secale cereale	8/15-2/28	170
Winter Wheat	Triticum aestivum	8/18-2/28	180
Japanese Millet	Echinochloa crusgalli	5/15-8/15	30
Redtop	Agrostis alba	3/1-6/15	10
Annual Ryegrass and Spring Oats	Lolium multiflorum, Avena sativa	3/1-6/15	30, 70
German, Foxtail Millet	Setaria italica	5/1-8/1	40
Hairy Vetch	Vicia villosa	8/15-4/1	60

- 1. PRIOR TO SEEDING, INSTALL NECESSARY EROSION CONTROL PRACTICES SUCH AS DIKES, WATERWAYS, AND
- SEED SHALL BE EVENLY APPLIED WITH A BROADCAST SEEDER, ORILL, CULTIPACKER SEEDER, OR
 HYDROSEEDER. SMALL GRAINS SHALL BE PLANTED NO MORE THAN 1.5 INCHES DEEP. SMALL SEEDS, SUCH AS
 ANNUAL RYE, SHALL BE PLANTED NO MORE THAN A QUARTER INCH DEEP. OTHER GRASSES AND LEGUMES SHALL BE PLANTED NO MORE THAN A HALF INCH DEEP.
- TEMPORARY SEEDING CONDUCTED IN FALL FOR WINTER COVER AND DURING HOT AND DRY SUMMER MONTHS SHALL BE MULCHED WITH STRAW AND HAY ACCORDING TO THE STANDARD FOR MULCHING, HYDROMULCHES (FIBER MULCH) MAY NOT PROVIDE ADEQUATE TEMPERATURE AND MOISTURE CONTROL.

PERMANENT SEEDING CHART

FERMANENT SEEDING CHART								
			PLS					
Seed Mix	Common Name	Scientific Name	Lbs/Acre					
0	Perennial Ryegrass	Lolium perenne	40					
	Birdsfoot Trefoil	Lotus corniculatus	15					
	Redtop	Agrostis alba	5					
р	Serecia Lespedeza	Lespedeza cunata	40					
	Orchardgrass	Dactylis glomerata	30					
	Redtop	Agrostis alba	5					

- 1. ALL PERMANENT SEEDING SHALL CONFORM TO WV DEP EROSION AND SEDIMENT CONTROL BEST MANAGEMENT PRACTICE MANUAL, SECTION 3.10-1.

2. SEED MIX O OR P SHALL BE USED FOR PERMANENT SEEDING.

CREATION TO COMPLETION

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SWPPP NOTES

STATION(S):

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KAPROJECTSCONSOL FNERGYJ750589-01 - 0X11 - MEATHOUSE FORK WATER LINEUG-CIVIL/PLAMPIPELINEJ750589-MEATHOUSE-OJ

JOB NO.: 750589 DESIGN: BEM DRAWN: BEM CHECKED: ВЈМ SHEET NO.

07/29/14

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EROSION & SEDIMENT CONTROL PLAN NOTES

- ALL EROSION AND SEDIMENTATION CONTROL SHALL BE PERFORMED ACCORDING TO: THIS PLAN; WEST VIRGINIA GENERAL WATER POLLUTION CONTROL PERMIT; ANY AND ALL REQUIRED PERMITS, REPORTS, AND RELATED DOCUMENTS. ALL CONTRACTORS AND SUBCONTRACTORS MUST BECOME FAMILIAR WITH
- CONTRACTOR SHALL IMPLEMENT BEST MANAGEMENT PRACTICES AS REQUIRED BY THE EROSION CONTROL PLAN. ADDITIONAL BEST MANAGEMENT PRACTICES SHALL BE IMPLEMENTED AS DICTATED BY CONDITIONS AND GRADE CHANGES TO THE SITE AT NO ADDITIONAL COST TO OWNER THROUGHOUT ALL
- CONTRACTOR SHALL MINIMIZE CLEARING AND DISTURBANCE TO THE ENVIRONMENT TO THE MAXIMUM EXTENT POSSIBLE OR AS REQUIRED BY THE GENERAL PERMIT.
- PERIMETER SEDIMENT BARRIERS SHALL BE IMPLEMENTED AS THE FIRST STEP OF GRADING WITHIN SEVEN (7) DAYS FROM THE START OF CLEARING AND GRUBBING, AND SHALL CONTINUE TO FUNCTION UNTIL THE SLOPE DEVELOPMENT AREA IS RESTABILIZED.
- 5. STABILIZATION MEASURES SHALL BE INITIATED AS SOON AS PRACTICABLE IN PORTIONS OF THE SITE WHERE CONSTRUCTION ACTIVITIES HAVE TEMPORARILY OR PERMANENTLY CEASED, BUT IN NO CASE MORE THAN SEVEN DAYS AFTER THE CONSTRUCTION ACTIVITY IN THAT PORTION OF THE SITE HAS
- WHERE THE INITIATION OF STABILIZATION MEASURES BY THE SEVENTH DAY AFTER CONSTRUCTION ACTIVITY TEMPORARILY OR PERMANENTLY CEASES IS PRECUIDED BY SNOW COVER, STABILIZATION MEASURES SHALL BE INITIATED AS SOON AS CONDITIONS ALLOW.
- WHERE CONSTRUCTION ACTIVITY WILL RESUME ON A PORTION OF THE SITE WITHIN 14 DAYS FROM WHEN ACTIVITIES CEASED, (E.G., THE TOTAL TIME PERIOD THAT CONSTRUCTION ACTIVITY IS TEMPORARILY HALTED IS LESS THAN 14 DAYS) THEN STABILIZATION MEASURES DO NOT HAVE TO BE INITIATED ON THAT PORTION OF THE SITE BY THE SEVENTH DAY AFTER CONSTRUCTION ACTIVITIES HAVE TEMPORARILY CEASED.
- AREAS WHERE THE SEED HAS FAILED TO GERMINATE ADEQUATELY (UNIFORM PERENNIAL VEGETATIVE COVER WITH A DENSITY OF 70%) WITHIN 30 DAYS AFTER SEEDING AND MULCHING MUST BE RESEEDED IMMEDIATELY, OR AS SOON AS WEATHER CONDITIONS ALLOW.
- TEMPORARY SEEDING SHALL BE IN ACCORDANCE WITH WYDEP'S OFFICE OF CONSTRUCTION STORMWATER EROSION AND SEDIMENT CONTROL BEST MANAGEMENT PRACTICE MANUAL, CHAPTER
- PERMANENT SEEDING SHALL BE IN ACCORDANCE WITH WYDEP'S OFFICE OF CONSTRUCTION STORMWATER EROSION AND SEDIMENT CONTROL BEST MANAGEMENT PRACTICE MANUAL, CHAPTER
- 11. SLOPES SHALL BE LEFT IN A ROUGHENED CONDITION DURING THE GRADING PHASE TO REDUCE RUNOFF VELOCITIES AND EROSION, ALL SLOPES 3:1 OR GREATER THAN 3:1 SHALL BE FERTILIZED, SEEDED, AND CURLEX BLANKETS BY AMERICAN EXCELSION COMPANY, NORTH AMERICAN GREEN, INC. OR AN APPROVED EQUAL AS SPECIFIED IN THE PLANS SHALL BE INSTALLED ON THE SLOPES.
- NO SOLID (OTHER THAN SEDIMENT) OR LIQUID WASTE, INCLUDING BUILDING MATERIALS, SHALL BE DISCHARGED IN STORM WATER RUNOFF, ALL NON-SEDIMENT POLLUTANTS MUST BE DISPOSED OF IN OCCUR IN DESIGNATED PIT OR DIKED AREAS, WHERE WASHINGS CAN BE REMOVED AND PROPERLY DISPOSED OF THE HARDEN. STORAGE TANKS SHOULD ALSO BE LOCATED IN PIT OR DIKED AREAS, WHERE WASHINGS CAN BE REMOVED AND PROPERLY DISPOSED OF AREAS, IN ADDITION, SUFFICIENT OIL AND GREASE ABSORBING MATERIALS AND FLOTATION BOOMS TO CLEAN AND CONTAIN FUEL AND CHEMICAL SPILLS MUST BE KEPT ON SITE
- 13. IF THE ACTION OF VEHICLES TRAVELING OVER THE STABILIZED CONSTRUCTION EXIT DOES NOT SUFFICIENTLY REMOVE MOST OF THE DIRT AND MUD, THEN THE TIRES MUST BE WASHED BEFORE VEHICLES ENTER A PUBLIC ROAD, PROVISIONS MUST BE MADE TO INTERCEPT THE WATER AND TRAP THE SEDIMENT BEFORE IT IS CARRIED OFF THE SITE.
- RUBBISH, TRASH, GARBAGE, LITTER, OR OTHER SUCH MATERIALS SHALL BE DISPOSED INTO SEALED CONTAINERS, MATERIALS SHALL BE PREVENTED FROM LEAVING THE SITE THROUGH THE ACTION OF WIND OR STORM WATER DISCHARGE INTO DRAINAGE DITCHES OR WATERS OF THE STATE.
- DUST CONTROL USING APPROVED MATERIALS MUST BE PERFORMED AT ALL TIMES. THE USE OF MOTOR OILS AND OTHER PETROLEUM BASED OR TOXIC LIQUIDS FOR DUST SUPPRESSION IS PROHIBITED.
- 16. ALL MATERIALS SPILLED, DROPPED, WASHED, OR TRACKED ONTO THE ROADWAYS OR INTO THE STORM


EROSION & SEDIMENT CONTROL MAINTENANCE NOTES

ALL CONTROL MEASURES STATED IN THIS PLAN SHALL BE MAINTAINED IN FULLY FUNCTIONAL CONDITION LINTE TEMPORARY OR PERMANENT STABILIZATION OF THE SITE IS ACHIEVED. ALL EROSION AND SEDIMENTATION CONTROL MEASURES SHALL BE INSPECTED BY A QUALIFIED PERSON IN ACCORDANCE TO THE CONTRACT DOCUMENTS OR THE APPLICABLE PERMIT, WHICHEVER IS MORE STRINGENT, AND REPAIRED ACCORDING TO


- ALL SEEDED AREAS SHALL BE CHECKED REGULARLY TO ENSURE THAT A GOOD STANDING OF GRASS IS MAINTAINED. AREAS SHOULD BE FERTILIZED, WATERED, AND RESEEDED AS NEEDED.
- SILT FENCES, AND CHECK DAMS SHALL BE REPAIRED TO THEIR ORIGINAL CONDITION IF DAMAGED SEDIMENT ACCUMULATION MUST BE REMOVED WHEN SEDIMENT HEIGHT REACHES ONE-HALF THE HEIGHT OF THE SILT FENCE OR CHECK DAM.
- SEDIMENTATION TRAPS SHALL BE MAINTAINED IN OPERATIONAL CONDITIONS AT ALL TIMES. SEDIMENT MUST BE REMOVED FROM TRAPS WHEN THE DESIGN CAPACITY HAS BEEN REDUCED BY 40%.
- MINIMIZE OFF-SITE SEDIMENT TRACKING OF VEHICLES BY THE USE OF STONE MATERIAL IN ALL CONSTRUCTION ENTRANCES, ALONG WITH REGULARLY SCHEDULED SWEEPING/GOOD HOUSEKEEPING. STABILIZED CONSTRUCTION ENTRANCES TO BE PROPERLY MAINTAINED BY GENERAL CONTRACTOR AND
- THE TEMPORARY PARKING AND STORAGE AREA SHALL BE KEPT IN GOOD CONDITION (SUITABLE FOR PARKING AND STORAGE) BY GENERAL CONTRACTOR. THIS MAY REQUIRE PERIODIC TOP DRESSING OF THE TEMPORARY PARKING AS CONDITIONS DEMAND.
- CONTRACTORS AND SUBCONTRACTORS WILL BE RESPONSIBLE FOR REMOVING ALL SEDIMENT FROM THE SITE, INCLUDING SEDIMENT TRAPS AND STORM SEWER PIPES. SEDIMENT DEPOSITION DURING SITE STABILIZATION MUST ALSO BE REMOVED
- ALL ROCK CHANNEL PROTECTION MUST BE PLACED OVER GEOTEXTILE FILTER.
- 8. ROCK CHECK DAMS SHOULD BE ROUTINELY CLEANED ONCE SEDIMENT BEGINS TO APPEAR ON THE
- CONTAINERS SHALL BE AVAILABLE FOR DISPOSAL OF DEBRIS, TRASH, HAZARDOUS OR PETROLEUM WASTES, ALL CONTAINERS MUST BE COVERED AND LEAK-PROOF, ALL WASTE MATERIAL SHALL BE DISPOSED OF AT FACILITIES APPROVED FOR THE PERTINENT MATERIAL
- AREA SHALL BE DESIGNATED BY CONTRACTOR AND SHOWN ON SWPPP MAP FOR MIXING OR STORAGE OF COMPOUNDS SUCH AS FERTILIZERS, LIME ASPHALT, OR CONCRETE, THESE DESIGNATED AREAS SHALL BE LOCATED AWAY FROM WATERCOURSES, DRAINAGE DITCHES, FIELD DRAINS, OR OTHER STORMWATER DRAINAGE AREA.
- EQUIPMENT FUELING & MAINTENANCE SHALL BE IN DESIGNATED AREAS ONLY.
- A SPILL PREVENTION CONTROL AND COUNTERMEASURE (SPCC) PLAN MUST BE DEVELOPED FOR SITES 12. WITH ONE ABOVE-GROUND STORAGE TANK OF 660 GALLONS OR MORE, TOTAL ABOVE-GROUND STORAGE OF 1,330 GALLONS OR BELOW-GROUND STORAGE OF 4,200 GALLONS OF FUEL
- ALL CONTAMINATED SOIL MUST BE TREATED AND/OR DISPOSED IN AN WYDEP APPROVED SOLID WASTE MANAGEMENT FACILITY OR HAZARDOUS WASTE TREATMENT, STORAGE OR DISPOSAL FACILITIES.
- THE CONTRACTOR SHALL CONTACT THE WYDEP THE LOCAL FIRE DEPARTMENT AND THE LOCAL EMERGENCY PLANNING COMMITTEE IN THE EVENT OF A PETROLEUM SPILL (>25 GALLONS) OR THE PRESENCE OF SHEEN.


EROSION & SEDIMENT CONTROL MAINTENANCE NOTES


ALL EROSION AND SEDIMENT CONTROLS ON THE SITE SHALL BE INSPECTED AT LEAST ONCE EVERY SEVEN CALENDAR DAYS AND WITHIN 24 HOURS AFTER ANY STORM EVENT GREATER THAN 0.5 INCHES PER 24 HOUR PERIOD, ANY REQUIRED REPAIRS OR MAINTENANCE SHALL BE MADE IMMEDIATELY.

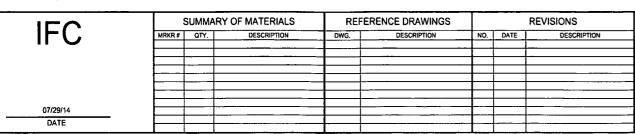


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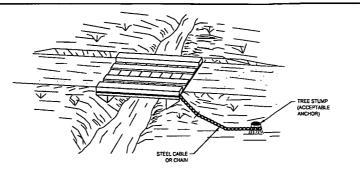


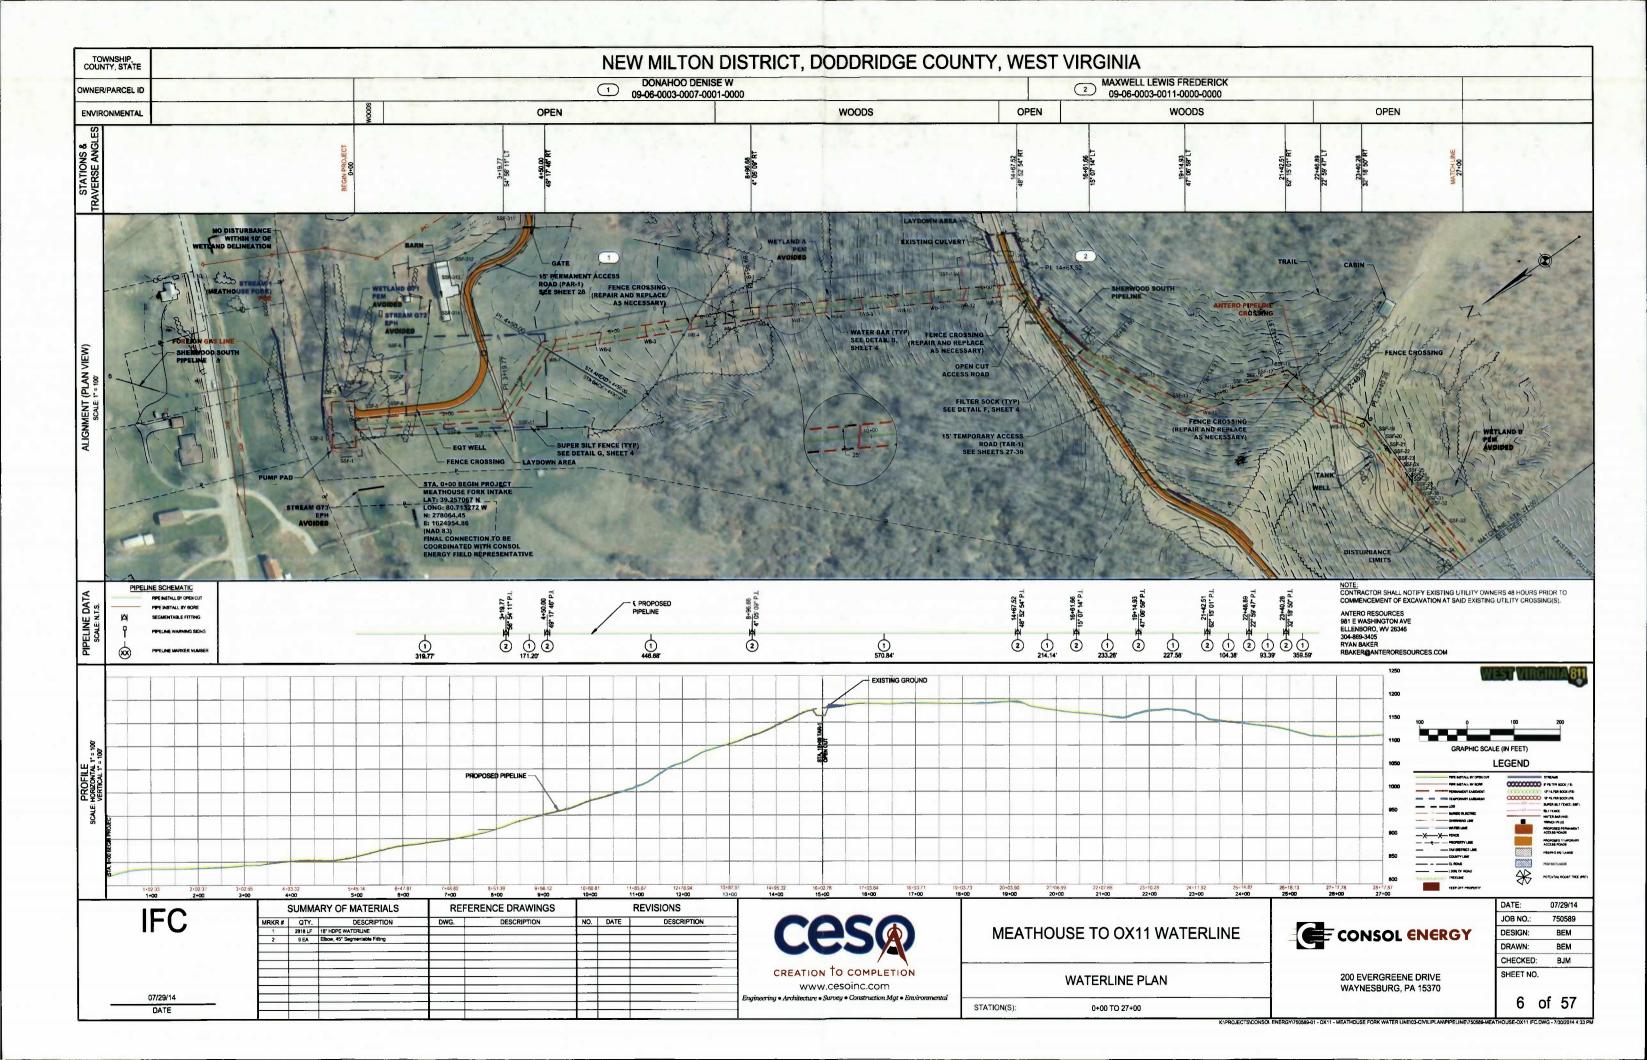


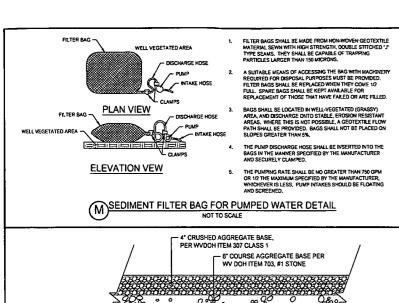

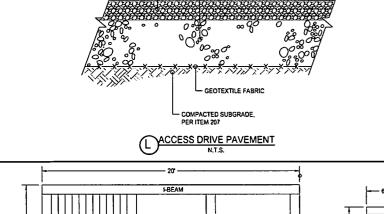

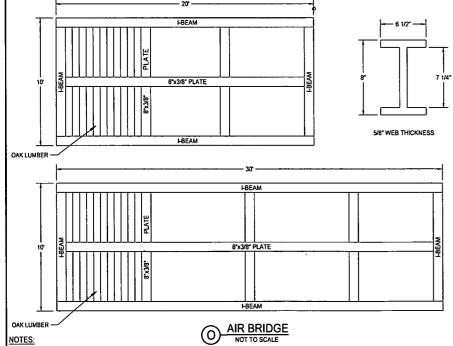- CONTACT ANTERO AT LEAST 72 HOURS PRIOR TO CONSTRUCTION TO HAVE THE EXISTING TRANSMISSION LINE FLAGGED
- ANTERO REPRESENTATIVES MUST BE ON SITE DURING CONSTRUCTION TO APPROVE INSTALLATION.
- THE CURRENT PIPELINE COVER MUST BE MAINTAINED. DURING CONSTRUCTION, CONTRACTOR SHALL STRIP TOPSOIL AND PLACE MATTING BOARDS FOR EQUIPMENT CROSSING THE GAS TRANSMISSION EASEMENT. MATTING BOARDS BENEATH THE EMBANKMENT ARE TO REMAIN IN PLACE.
- AIR BRIDGE IS TO BE REMOVED DURING SITE RESTORATION PHASE. ANTERO REPRESENTATIVES MUST BE ON SITE DURING REMOVAL FOR CONSTRUCTION APPROVAL. AFTER AIR BRIDGE IS REMOVED, FILL AIR GAP WITH SUBSOIL AND COMPACT TO SPECIFICATION. SEED AND MULCH FILL SLOPES.




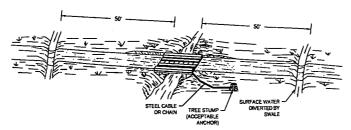

TEMPORARY ACCESS BRIDGE DETAIL


NOTES:

1. THE STRUCTURE SHALL BE LARGE ENOUGH TO HANDLE A 1-YEAR FREQUENCY STORM, 24 HOUR DURATION.

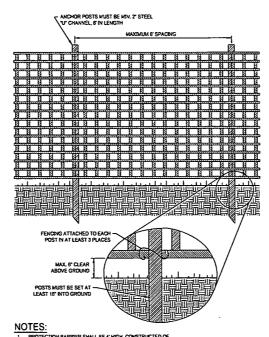


- PROTECTION BARRIER SHALL BE 4'HIGH, CONSTRUCTED OF DURABLE AND HIGHLY VISSIE MATERNAL (PLASTIC ORANGE CONSTRUCTION FENCE AND SHOWN-FENCE MAY SELVED), PROTECTION BARRIERS SHALL BE WARTHANED THROUGHOUT THE DURATION OF THE WORK AT THE STE. ADDITIONAL WARRING SIGNS SHOULD ALSO BE PLACED ON THE FENCING AND IN APPROPRIENT RAILES NEAR THE WORK ZONE.

(N) CONSTRUCTION FENCE DETAIL NOT TO SCALE

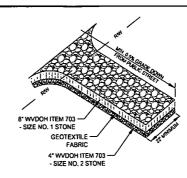

(J)STABILIZED CONSTRUCTION ENTRANCE

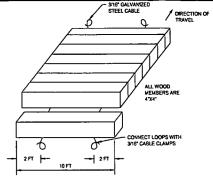

TYPICAL TIMBER MAT K FOR WETLAND CROSSING NOT TO SCALE


OPTION A


"Wooded Wetland Establishment Seed Mix" (available from JFNew or Ernst)							
Violet Victorio Colosiani	ion cose him (evenesis nem		PLS				
Scientific Name	Common Name		Ounces/Acre				
Permanent Grasses/Sedges:							
Calamagrostis canadensis	Bluejoint Grass		1.00				
Carex crinita	Fringed Sedge		2.00				
Carex tuputina	Common Hop Sedge		4.00				
Cerex turida	Bottlebrush Sedge		1.50				
Carex frankli	Bristly Cattal Sedge		3.00				
Carex squarrosa	Narrow-Leaved Cattail Sedge	ė	1.00				
Carex typhinia	Common Cettail Sedge		1.00				
Carex vulpinoidea	Brown Fox Sedge		4.00				
Elymus virginicus	Virginia Wild Rye		20.00				
Glyceria striata	Fowl Manna Grass		2.00				
Leersia oryzoides	Rice Cut Grass		2.00				
Scirpus atrovirens	Dark Green Rush		2.00				
Spartina pectinata	Prairie Cord Grass		1.00				
		Total	44.50				
Temporary Cover:							
Avena sativa	Common Oat		360.00				
Lolium multibrum	Annual Rye		100.00				
		Total	460.00				
Temporary Cover:							
Alisma spp.	Water Plantain Mix		3.00				
Angelica altropurpurea	Great Angelica		1.00	_			
Aster puniceus	Bristly Aster		0.75	ı			
Aster umbellatus	Flat-Top Aster		0.25				
Bidens cernua	Nodding Bur Marigold		2.50	l			
Cephalanthus occidentalis	Buttonbush		0.50				
Campanula americana	Tall Bellflower		0.25	l			
Helenium autumnale	Sneezeweed		2.00	l			
Heradeum lanatum	Cow Persnip		0.75	ı			
Hibiscus moscheutos	Swamp Rose Mallow		2.00	ı			
Lobelia siphilitica	Great Blue Lobelia		1.50	١			
Lycopus americanus	Common Water Horehound		0.25	l			
Mimulus ringens	Monkey Flower		1.25	۱			
Penthorum sedoides	Ditch Stonecrop		0.50	l			
Polygonum spp.	Pinkweed mbx		0.50	۱			
Rudbeckia laciniata	Wild Golden Glow		0.75	۱			
Verbesina alternifolia	Wingstern		2.00	۱			
		Total	19.75	۱			

Scientific Name	OPTION B Wetland Restoration Mixture Common Name		PLS Ounces/Acre
Avena sativa	Common Oat		480.00
Secale cereale	Cereal Rye		480.00
Panicum virgatum	Switch Grass		32.00
Panicum dandestinum	Deer-tongue Grass		32,00
Elymus ripartus	Riverbank Wild Rye		32.00
Poa patustris	March Bluegrass		32.00
Sorghastrum nutans	Indian Grass		16.00
Glyceria striata	Fowl Manna Grass		8.00
Carex crinita	Fringe Sedge		8.00
Cerex turida	Bottlebrush Sedge		8.00
Schrpus atrovirens	Dark Green Rush		8.00
Polygonum pensylvanicu	m Pinkweed		8.00
Verbena hastata	Blue Vervain		8.00
Verbesina alternifolia	Wingstem		8.00
Senna hebecarpa	Wild Senna		8.00
		Total	1168 00

STREAM/WETLAND CROSSING NOTES

- ALL TREES AND WOODY DEBRIS REMOVED FROM STREAM OR WETLAND CROSSINGS MUST BE DISPOSED OF OUTSIDE THE RIPARIAN OR WETLAND CROSSING AREAS.
- 2. CONSTRUCTION TIMBER MATTING MUST BE USED WHEN EQUIPMENT IS CROSSING WETLANDS AND/OR SOFT GROUND. ...
- 3. THE SEED MIX FOR STREAMWETLAND CROSSING AREAS (OPTIONS A OR B) SHALL BE USED.
- 4. NO FERTILIZER OR LIME SHALL BE USED IN STREAMWETLAND CROSSING AREAS.
- 5. NO GRUBBING IS ALLOWED AT TEMPORARY ACCESS CROSSINGS OF STREAMS OR WETLANDS.

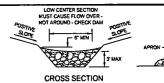

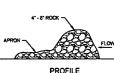

- NOTES:

 1. THE CHECK DAM SHALL BE CONSTRUCTED OF 4-8" DUAMETER STONE, PLACED SO THAT IT COMPLETELY COVERS THE WIDTH OF THE CHANNEL.

 2. MAXMUM HIGHT OF CHECK DAM SHALL NOT EXCEED 3.0 FEET.

 3. THE MIDDRONT OF THE ROCK CHECK DAM SHALL BE A MINIMUM OF 6" LOWER THAN THE SIDES IN ORDER TO DIRECT ACROSS THE CENTER AND AWAY FROM THE CHANNEL SIDES.

 4. THE BASE OF THE CHECK DAMS SHALL BE IN A MANDER SUCH THAT THE TOE OF THE OWNER DAM SHALL BE INFRENCHED APPROXIMATIELY 6 INCHES.

 5. SPACING OF CHECK DAMS SHALL BE IN A MANDER SUCH THAT THE TOE OF THE UPSTREAM DAM IS AT THE SAME LEXATION AS THE TOP OF THE DOWNSTREAM DAM.

 6. A SPLASH APRON SHALL BE CONSTRUCTED WHERE CHECK DAMS ARE EXPECTED TO BE IN USE FOR AN EXTENDED PERSON OF THE, A STONE APRON SHALL BE CONSTRUCTED IMAGENATELY DOWNSTREAM OF THE CHECK DAM TO PREVENT FLOWS FROM UNDERCUTTING THE STRUCTURE. THE APRON SHOULD BE 6 IN, THICK AND TIS LENGTH TWO THASE THE HEIGHT OF THE DOWNSTALL SLONG AS THE CENTER OF CHECK DAM SI DOWER THAN THE SIDES AND EXTENDED ACROSS THE ENTIRE CHANNEL.

 8. SIDE SLOPES SHALL BE A MINIMUM OF 2-1.

ROCK CHECK DAM DETAIL NOT TO SCALE

IFO	SUMMARY OF MATERIAL		OF MATERIALS	REFERENCE DRAWINGS			REVISIONS			
IFC	MRKR#	OTY.	DESCRIPTION	DWG.	DESCRIPTION	NO.	DATE	DESCRIPTION		
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07/29/14										



CREATION TO COMPLETION www.cesoinc.com

MEATHOUSE TO OX11 WATERLINE

NOTE: APPLY AT 32.8 PLS POUNDS PER ACRE.

STATION(S):

Total

SWPPP DETAILS

CONSOL ENERGY

JOB NO.: 750589 DESIGN: BEM DRAWN: BEM CHECKED: SHEET NO. 200 EVERGREENE DRIVE


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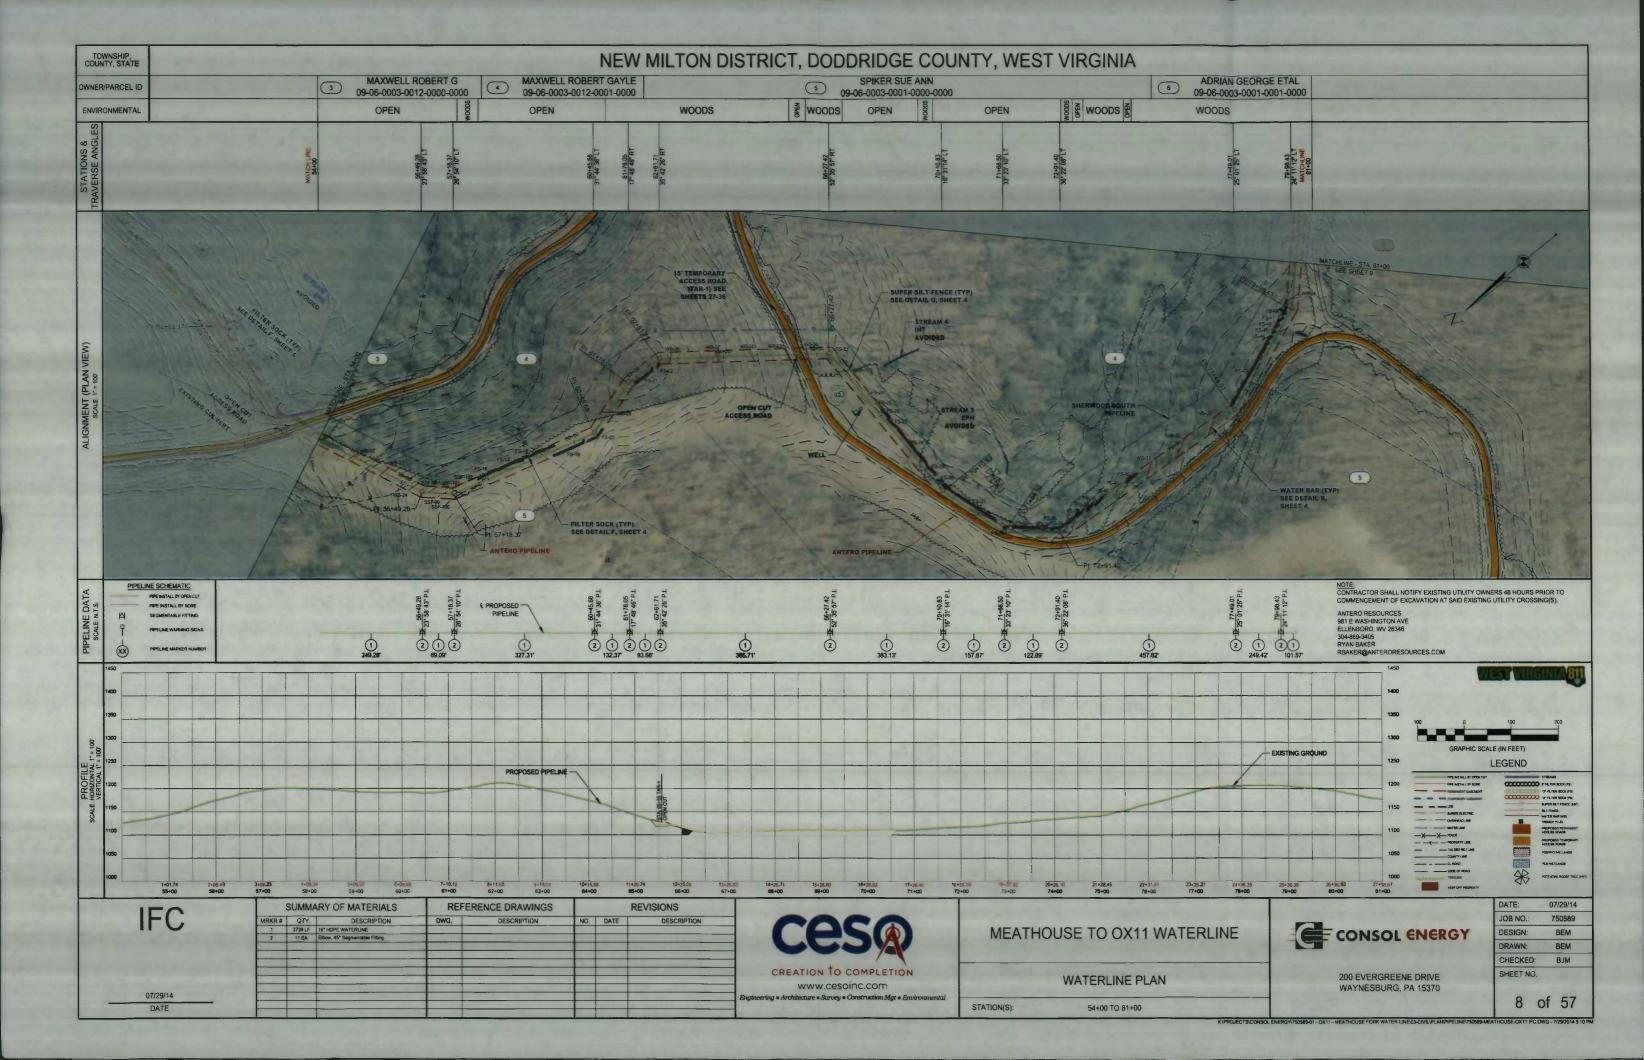
WAYNESBURG, PA 15370


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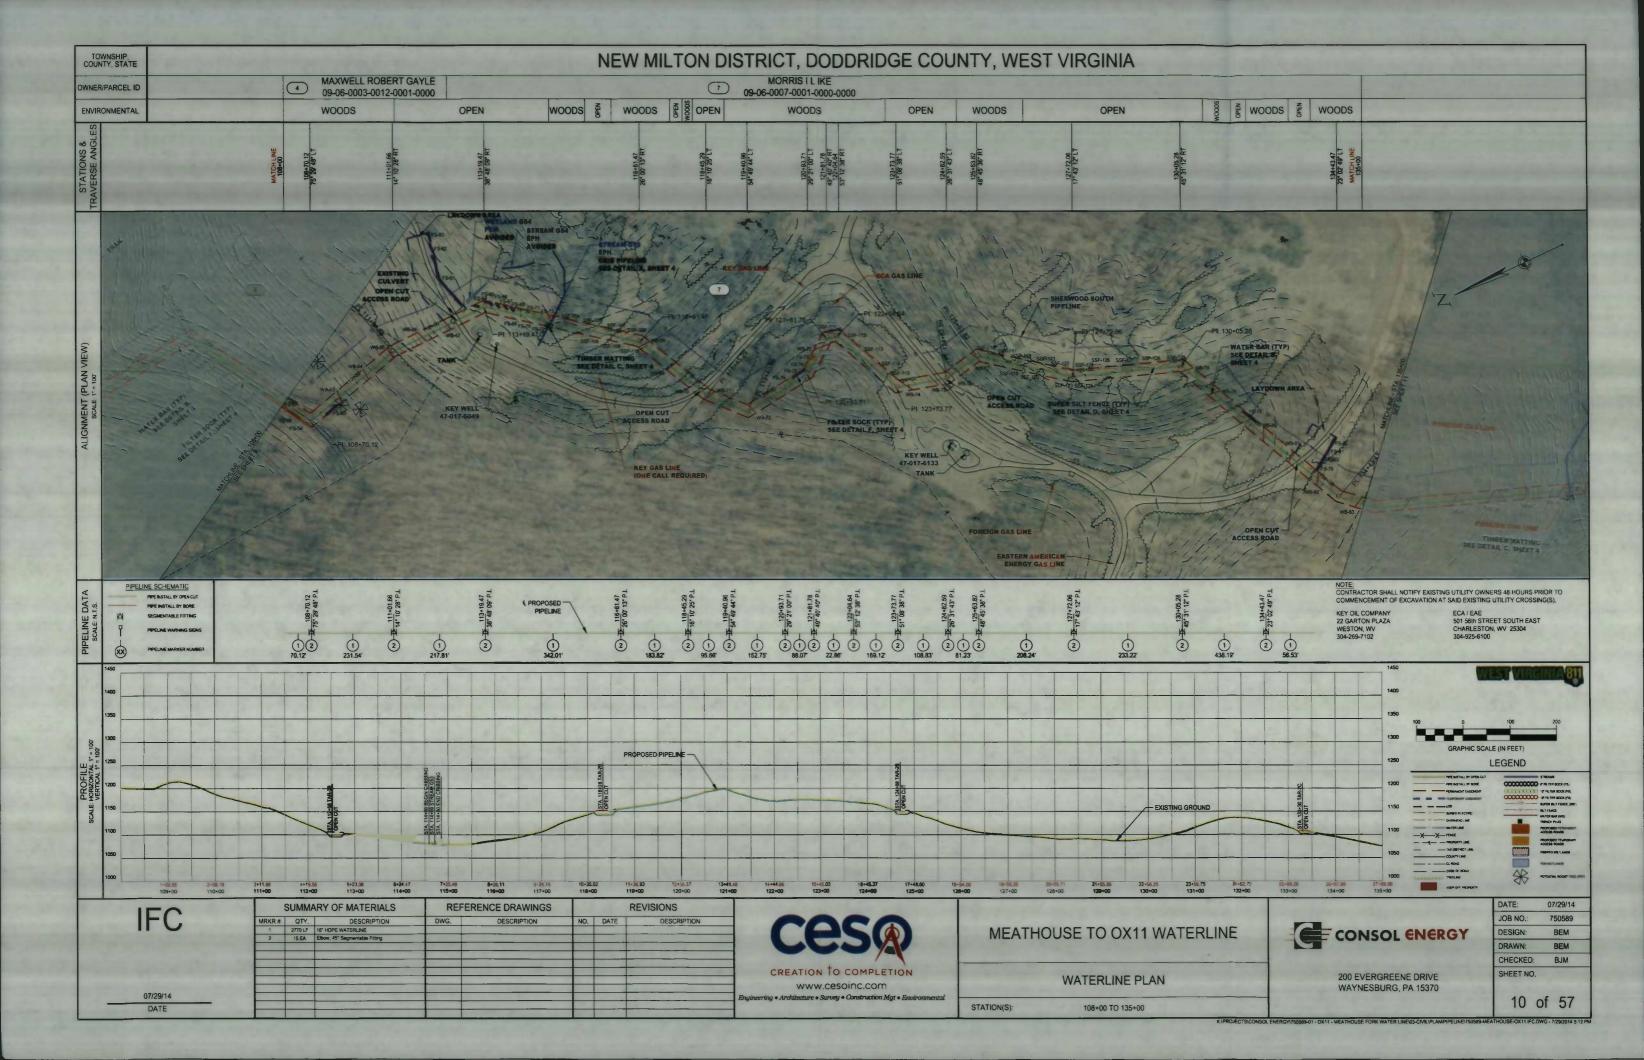
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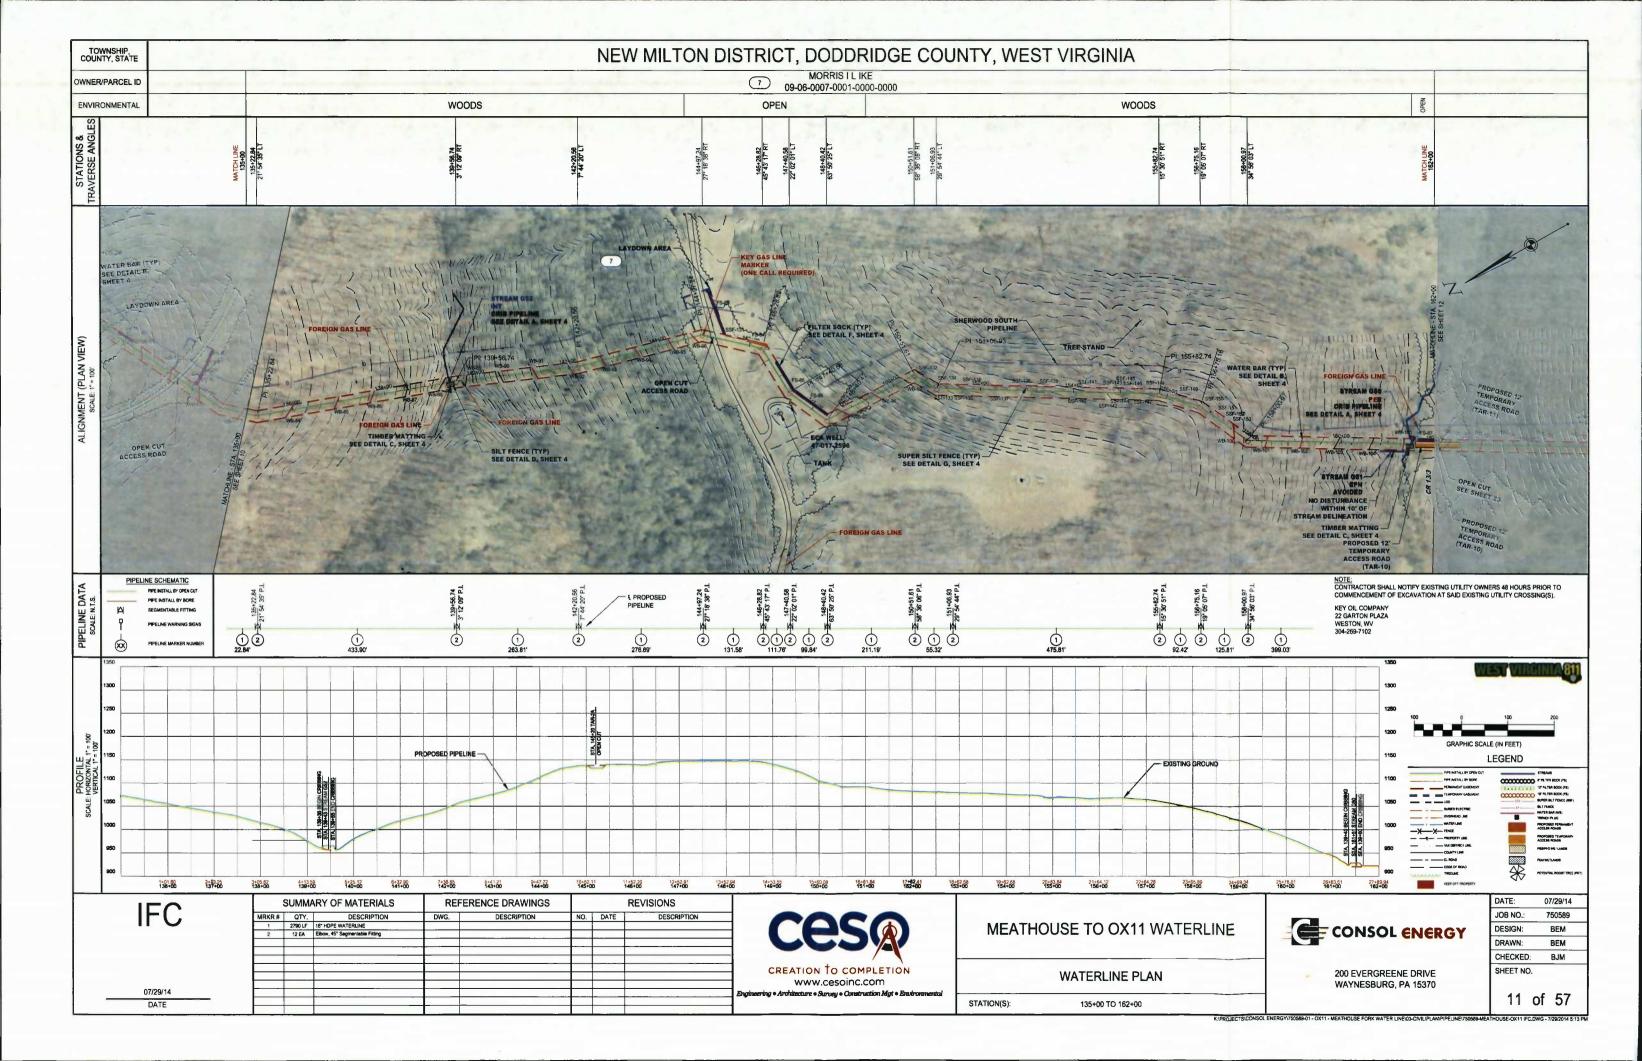
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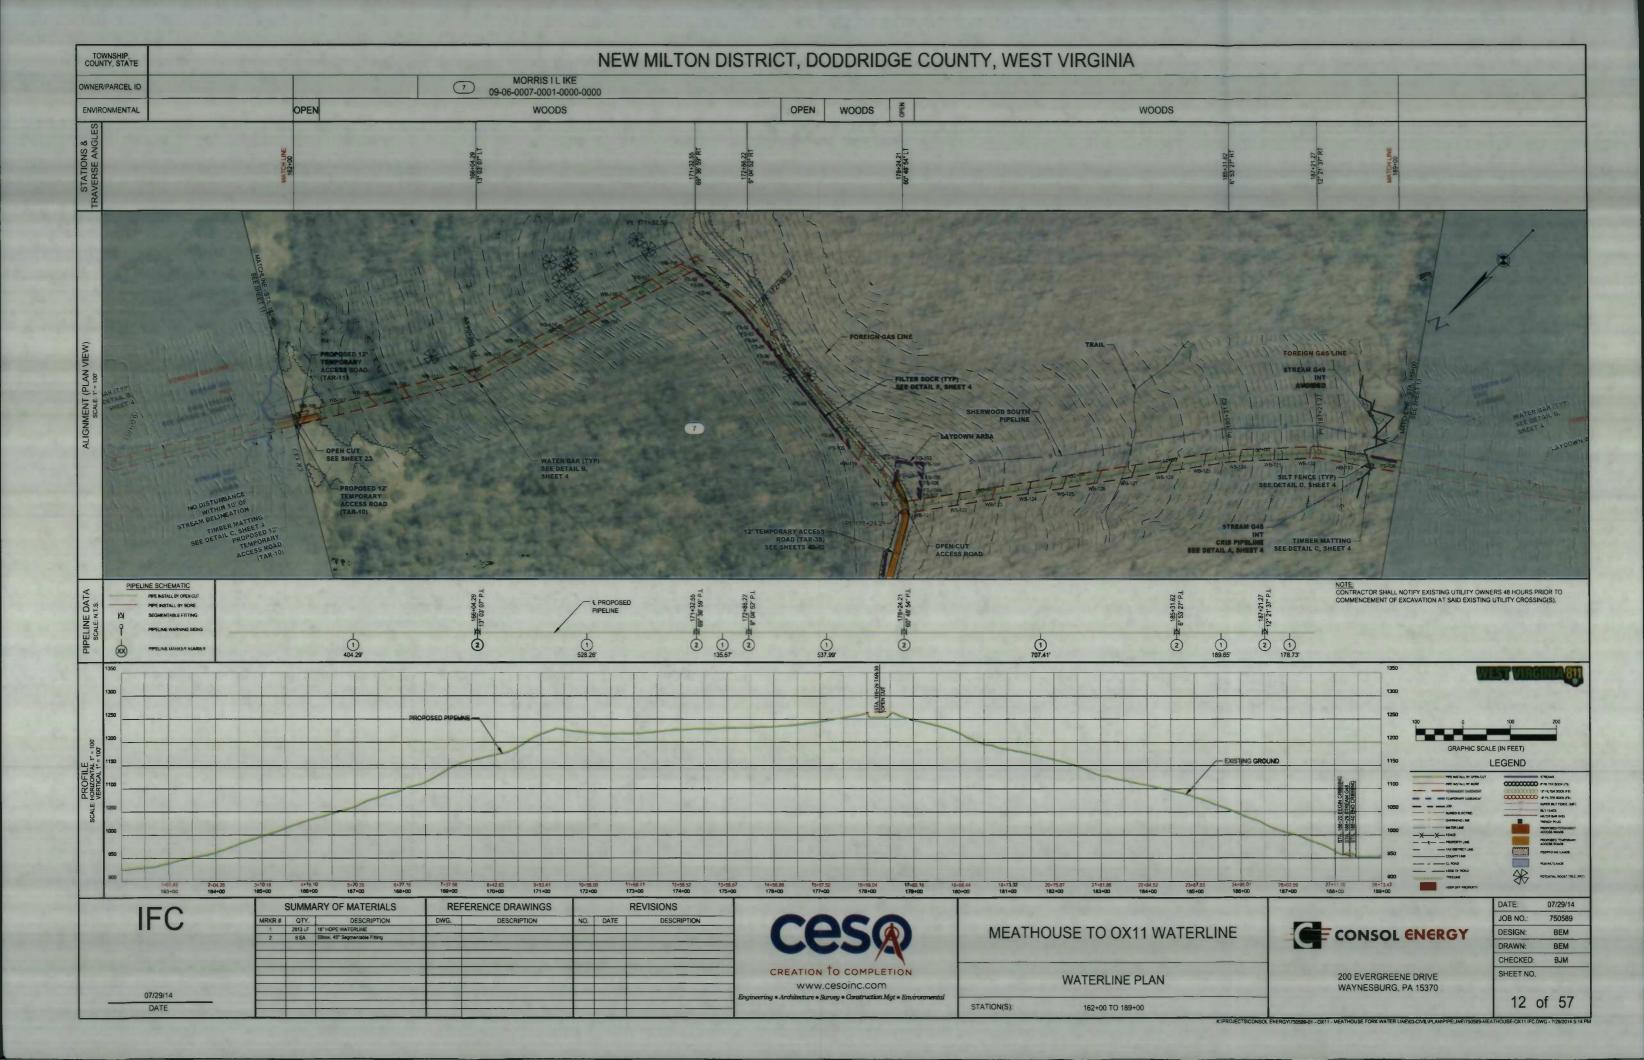











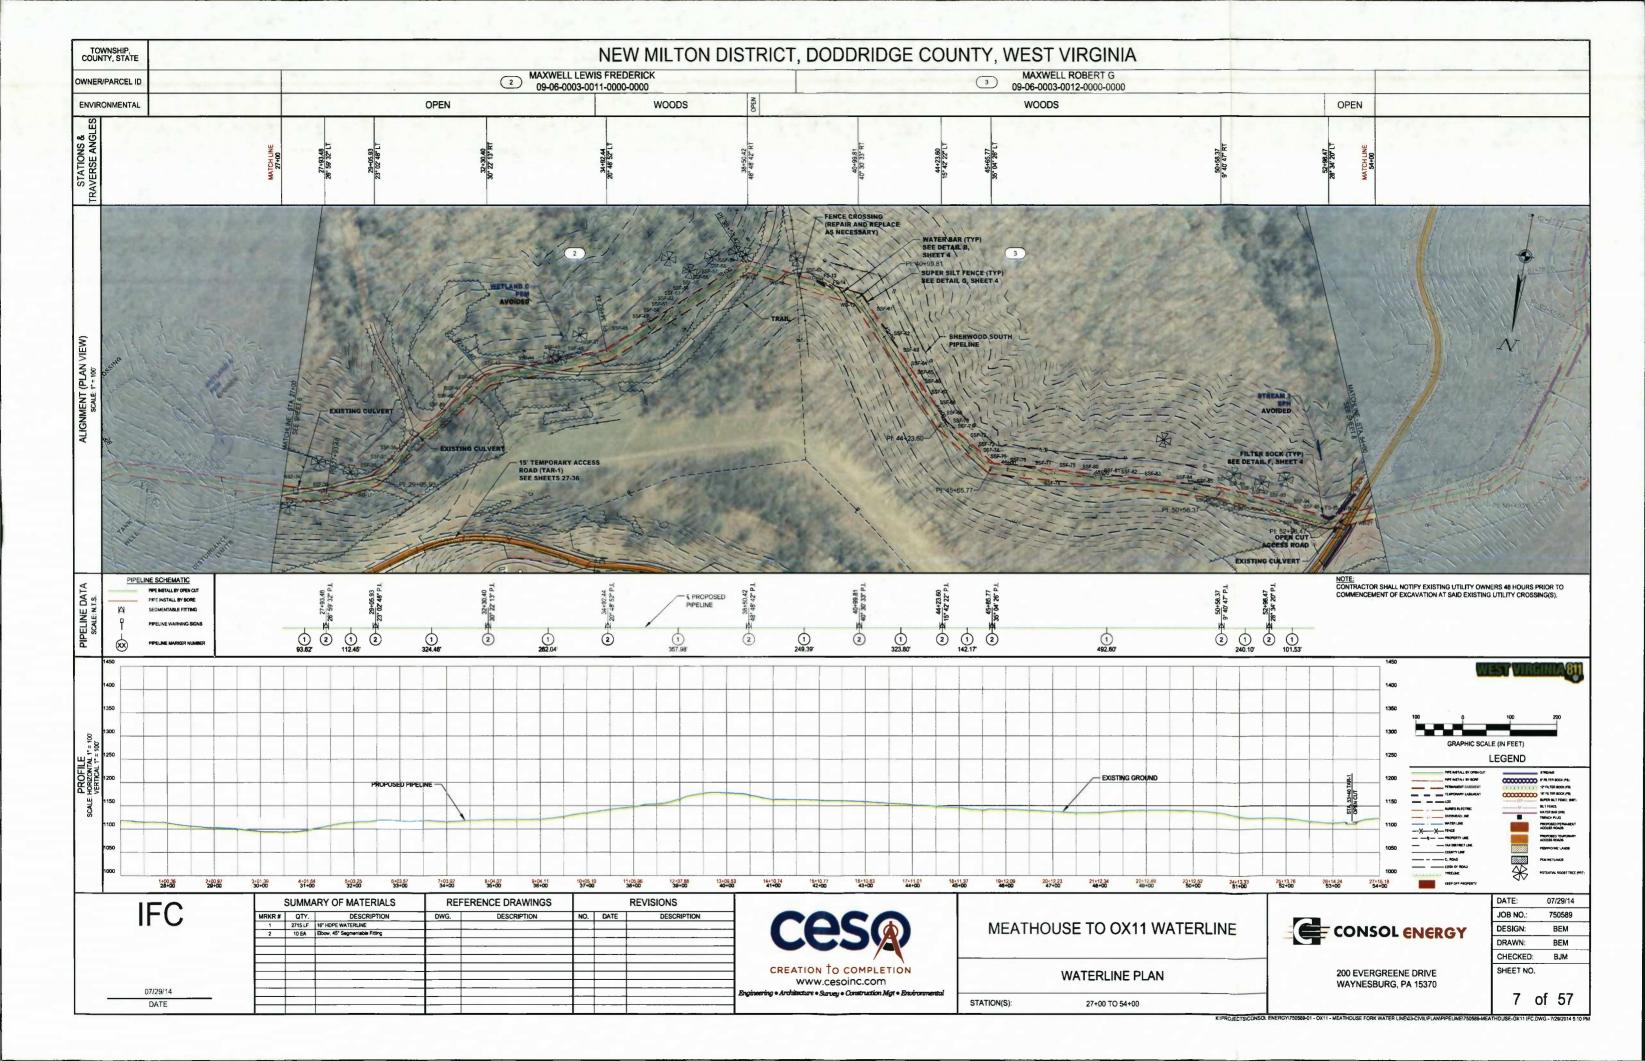


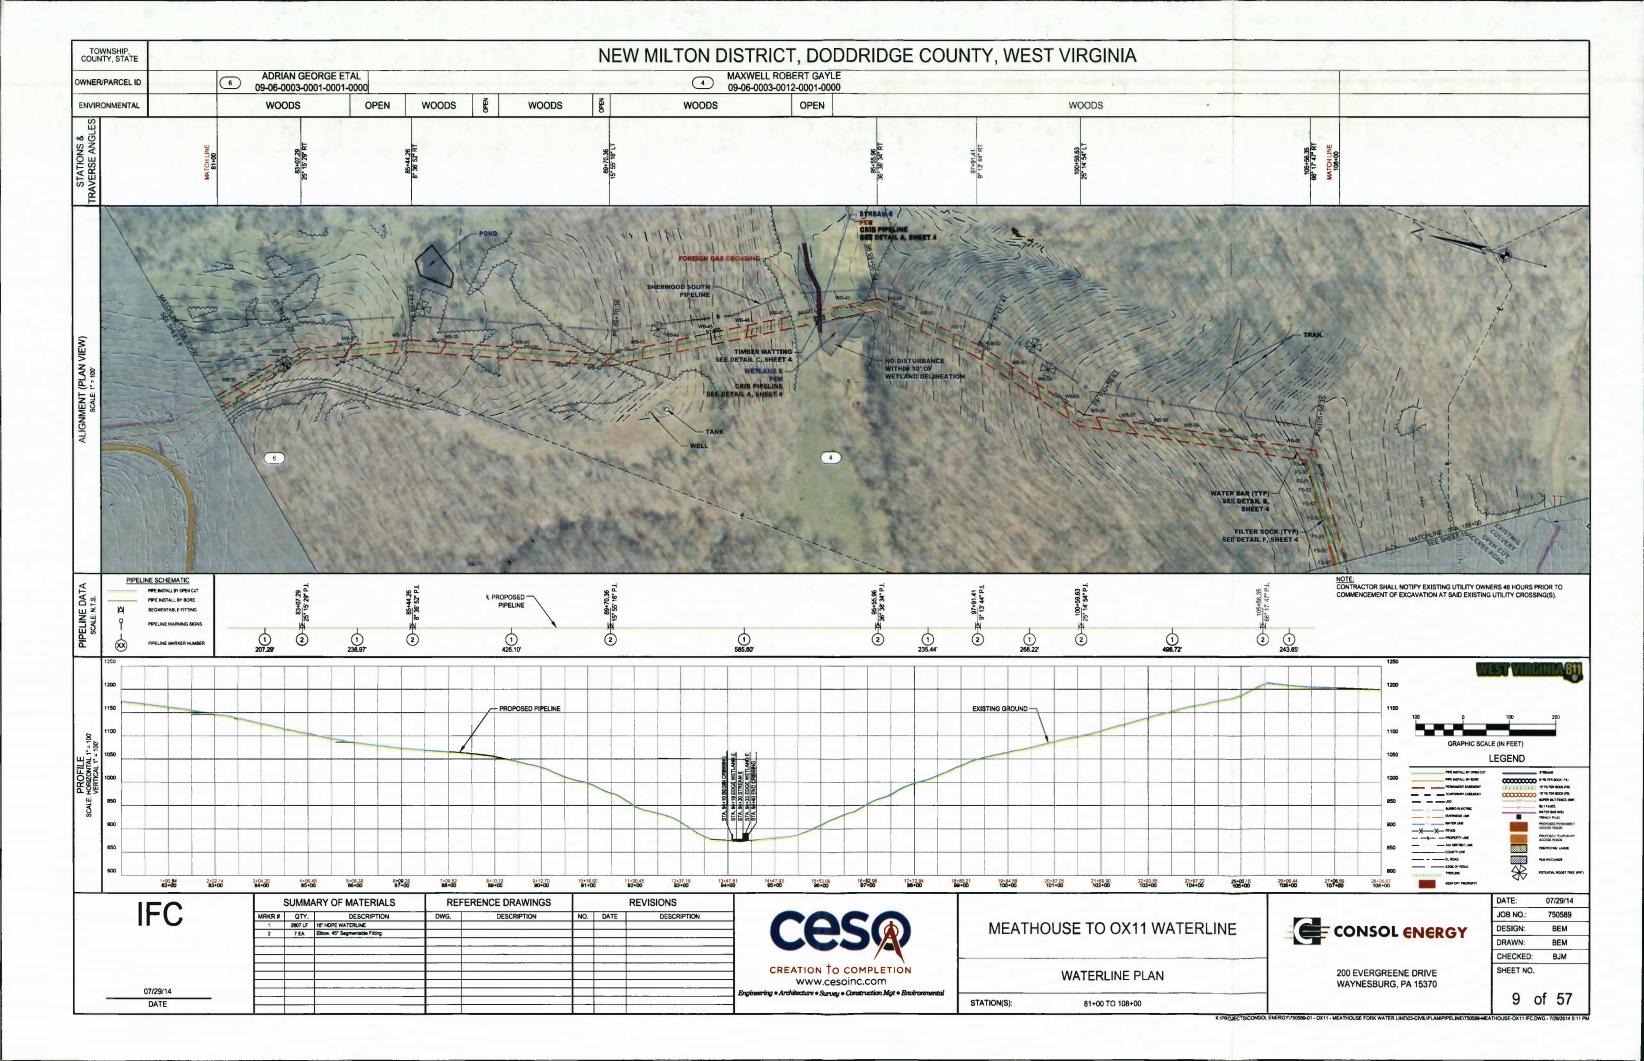


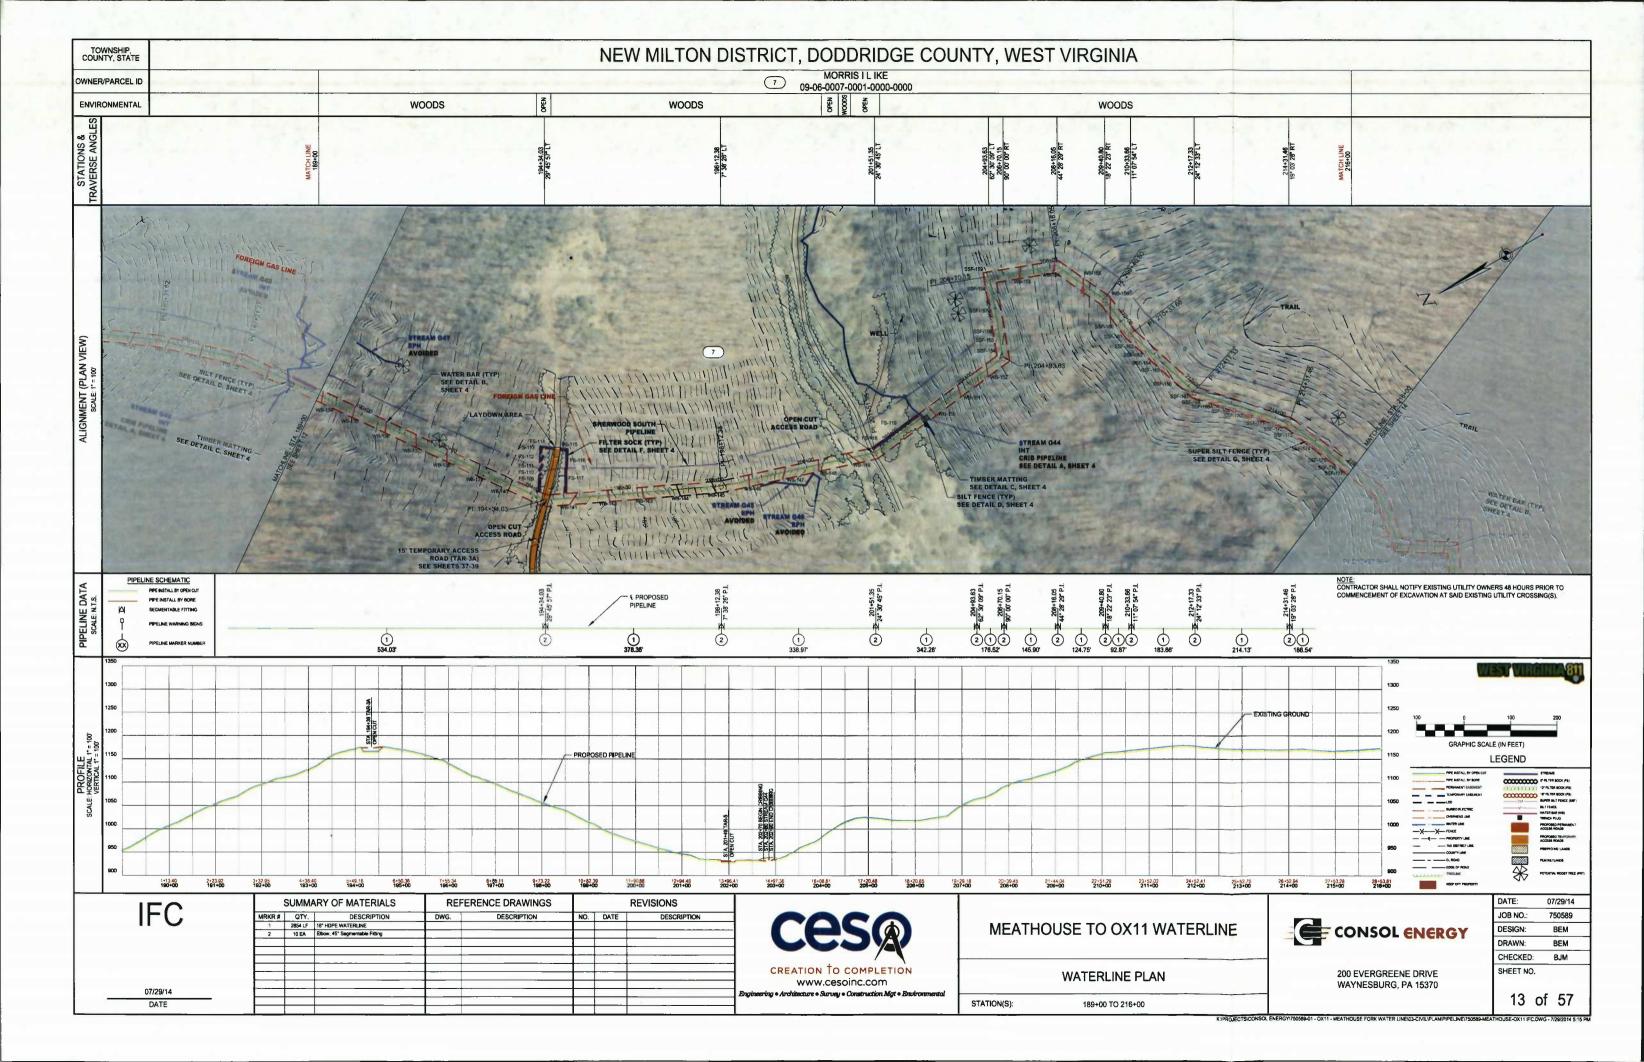


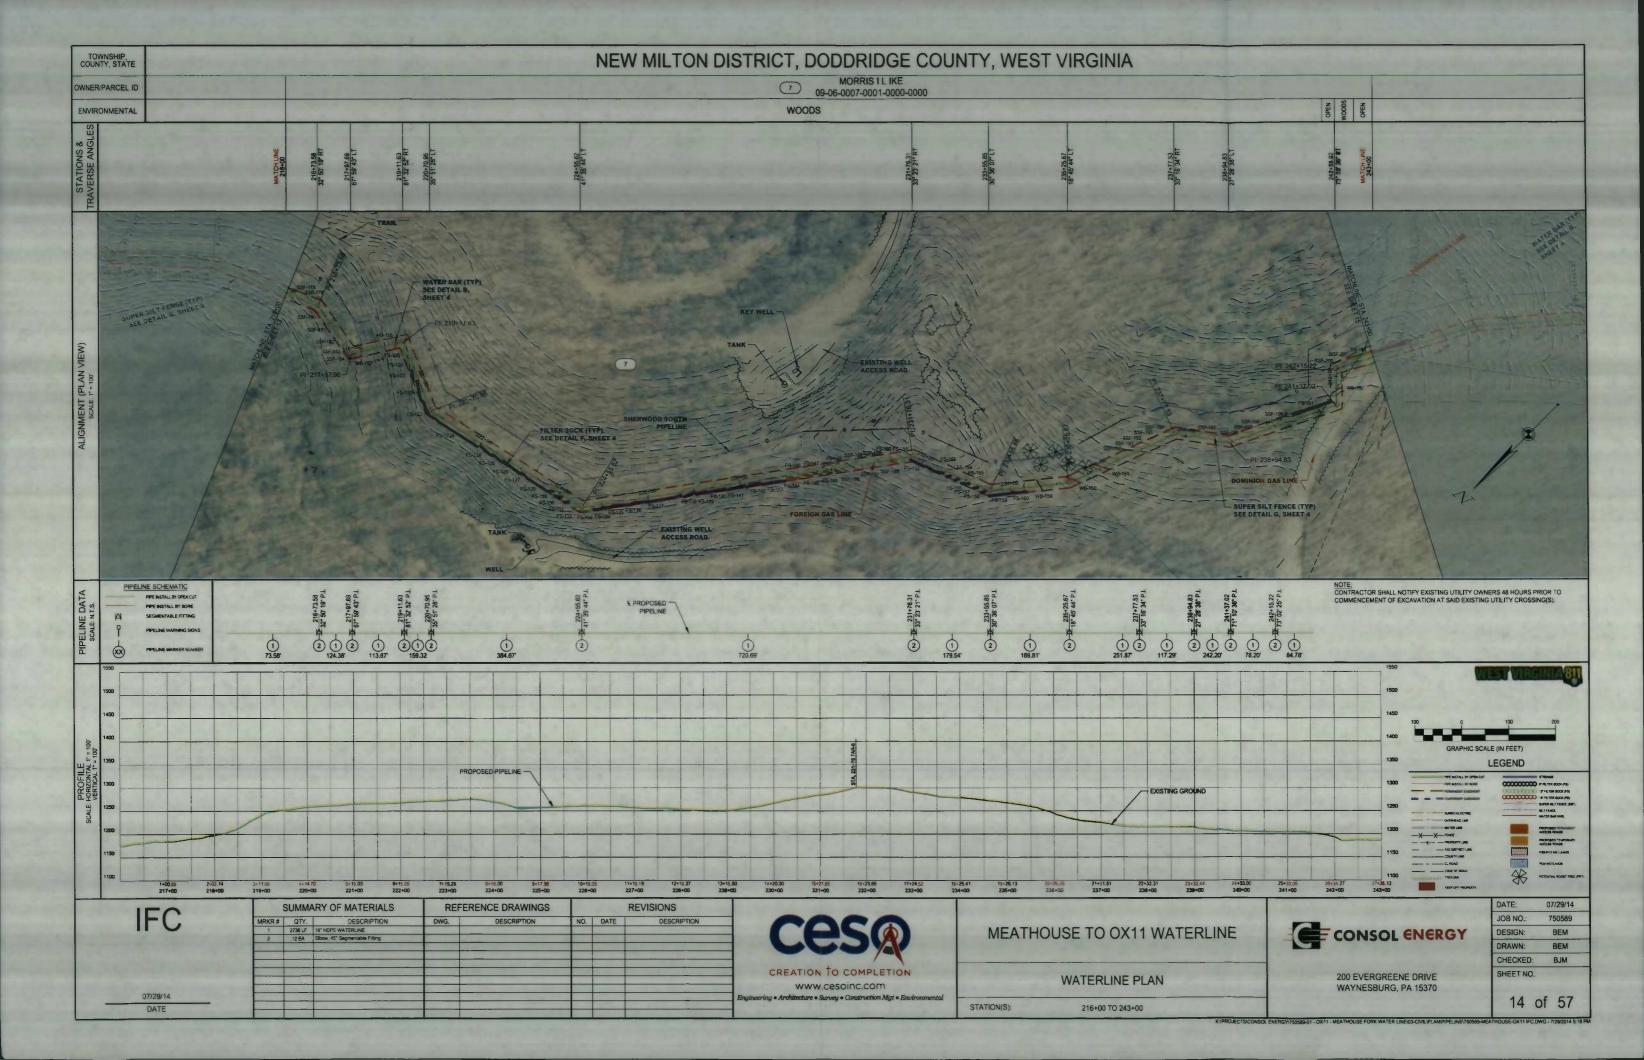


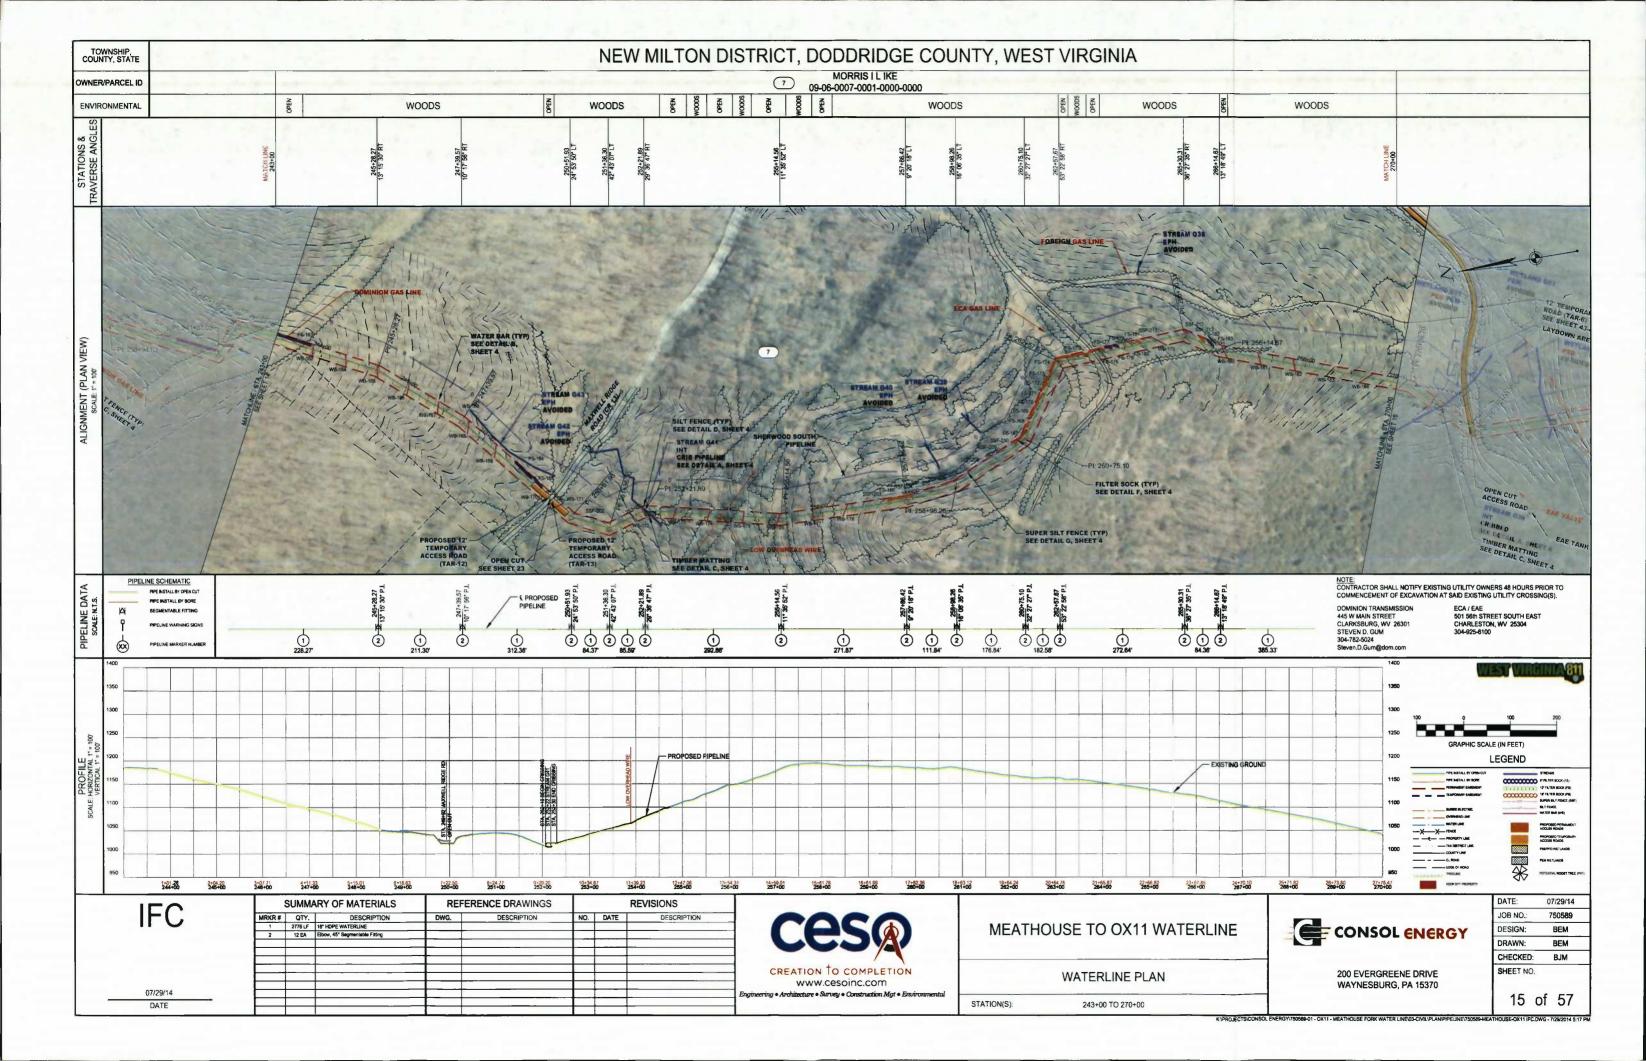


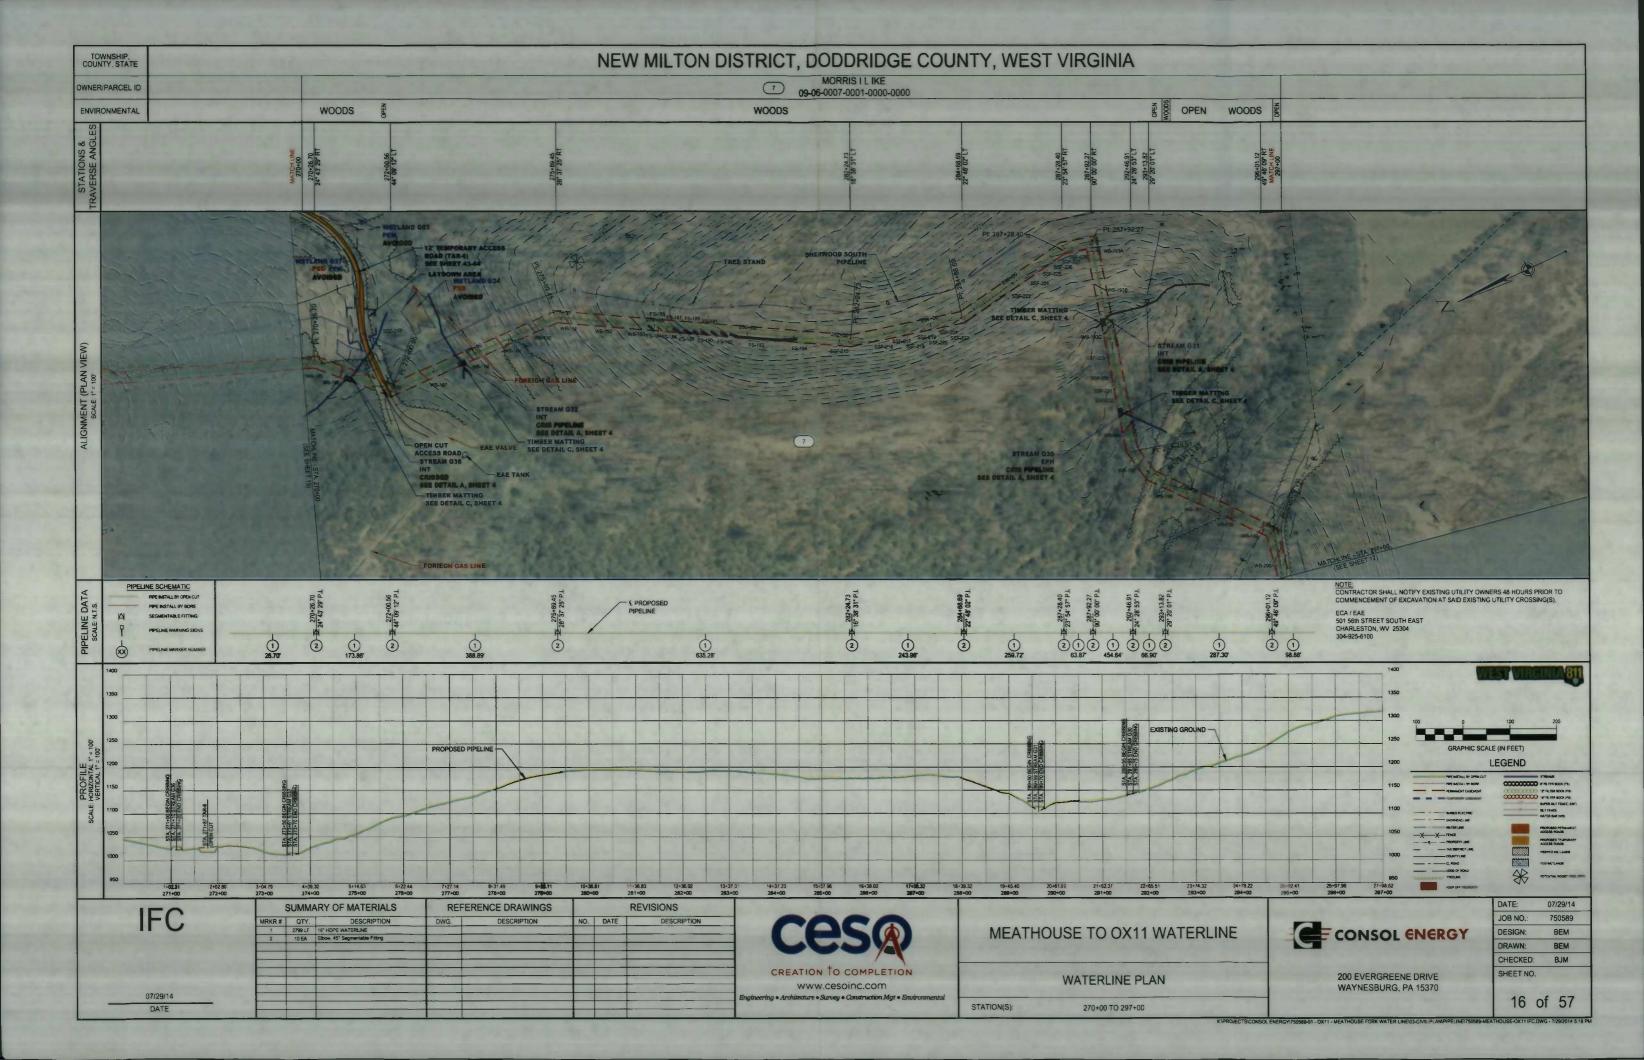


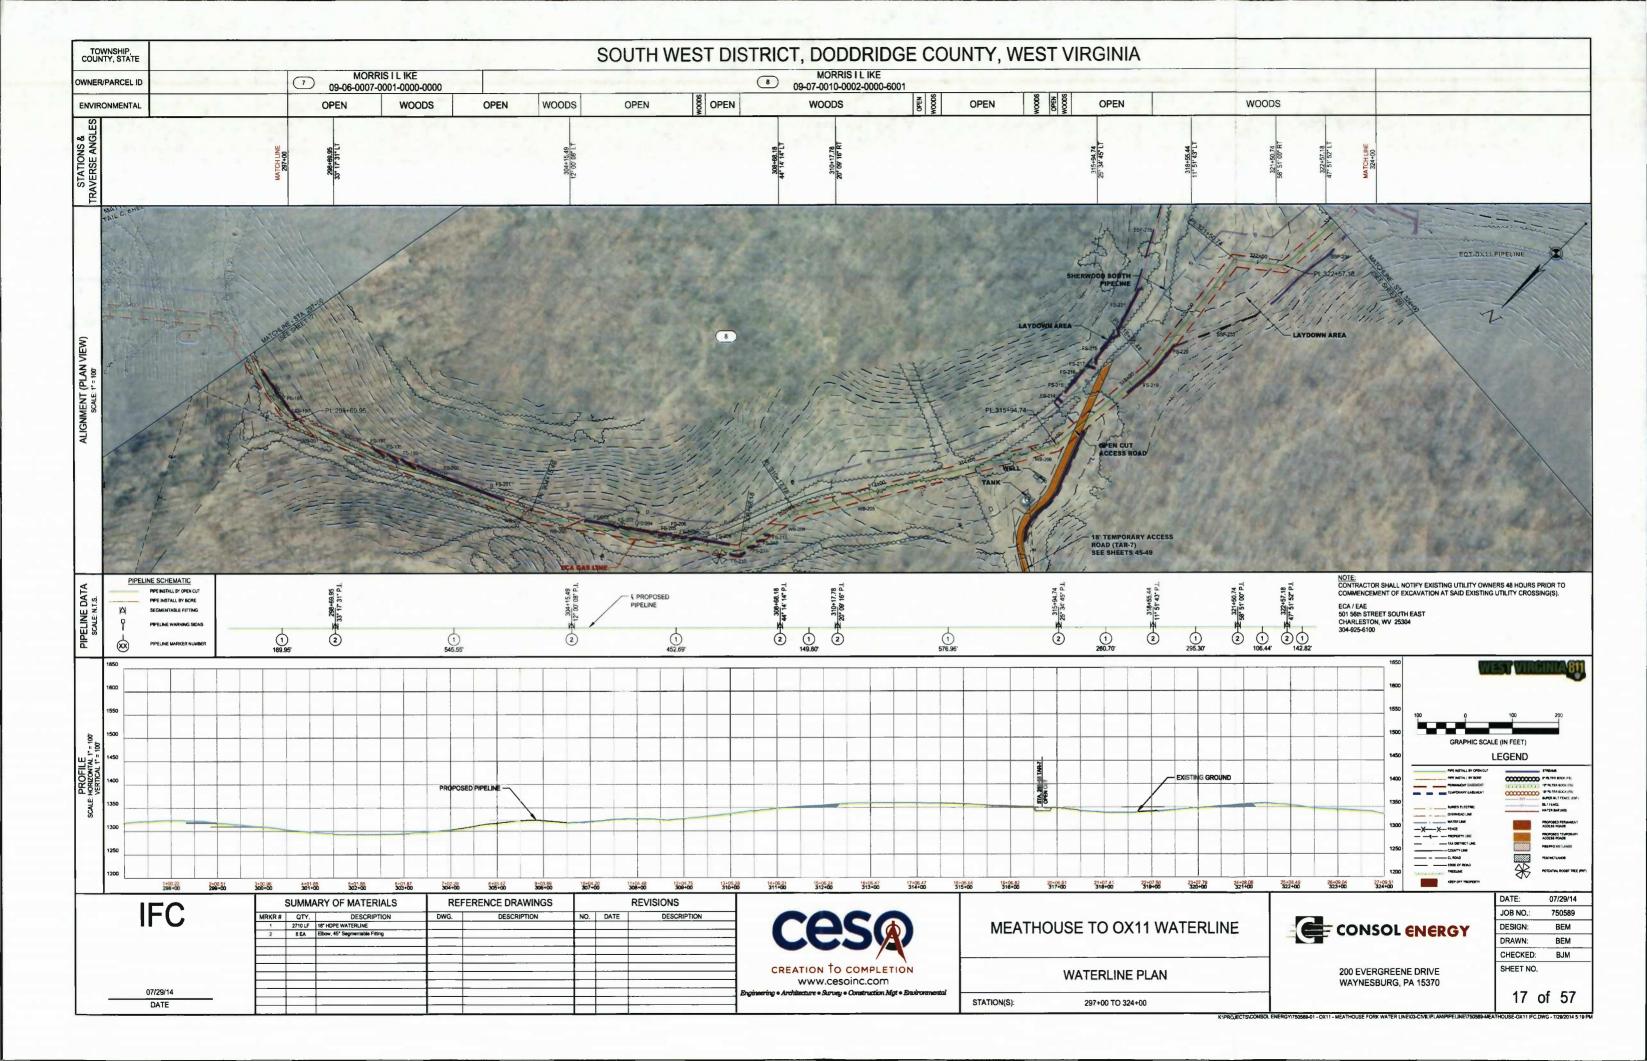


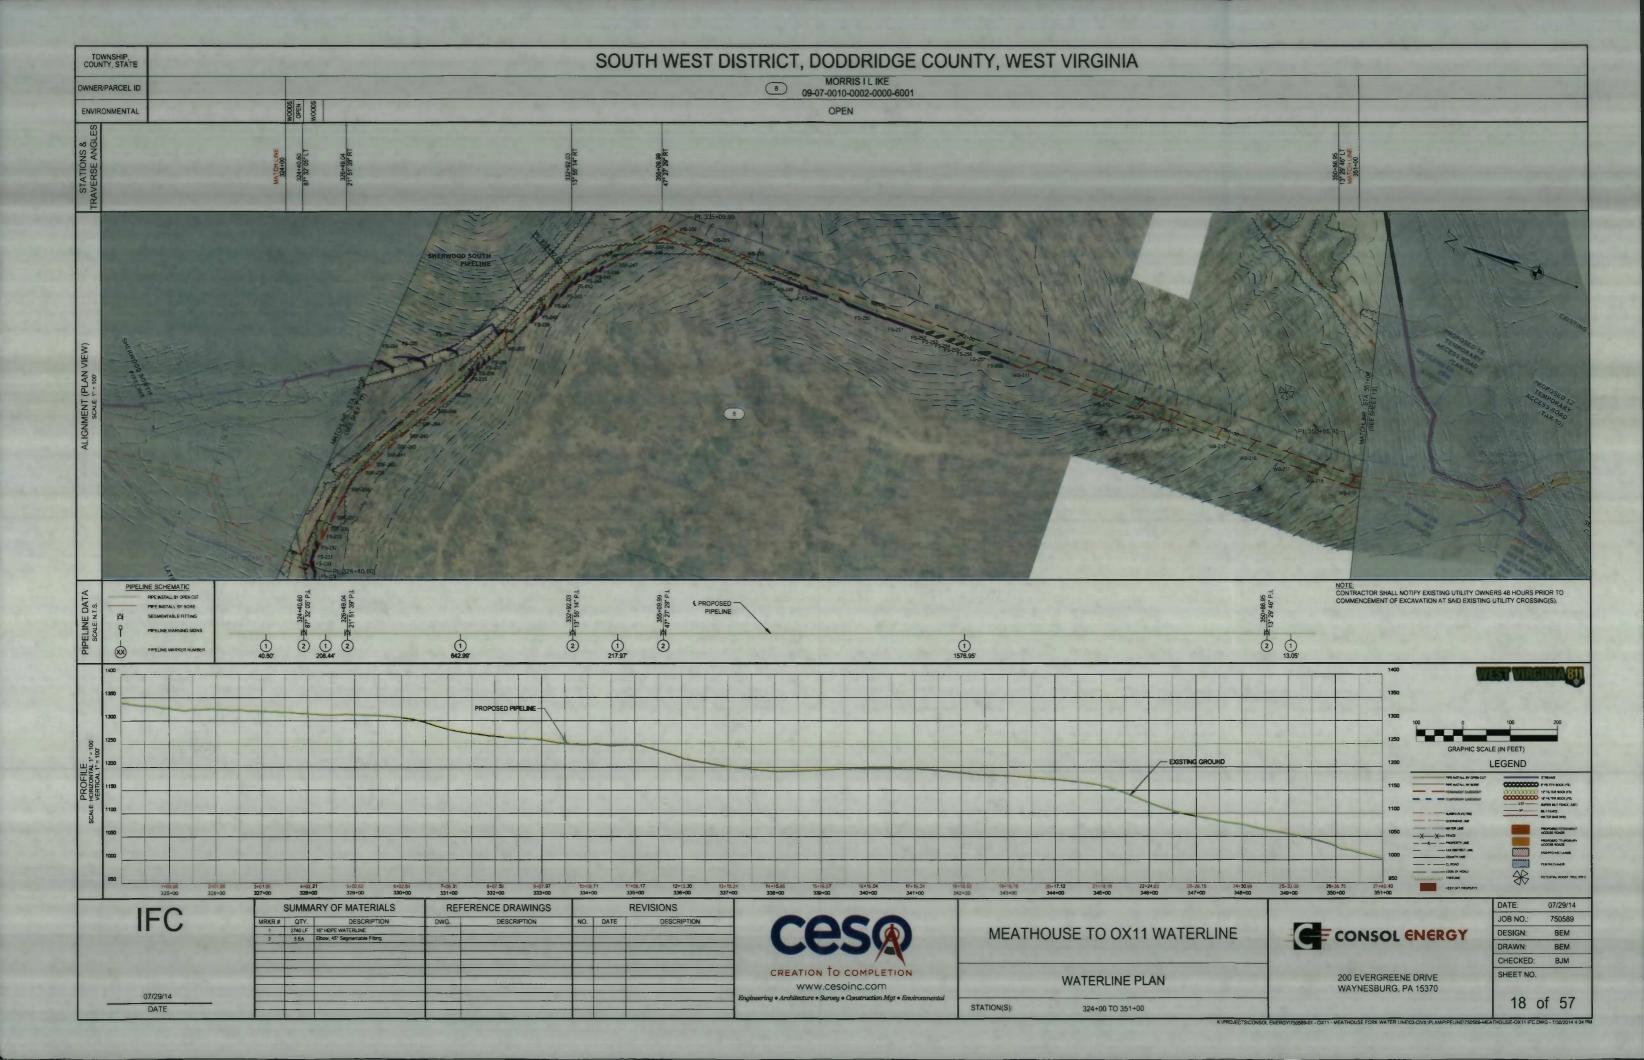


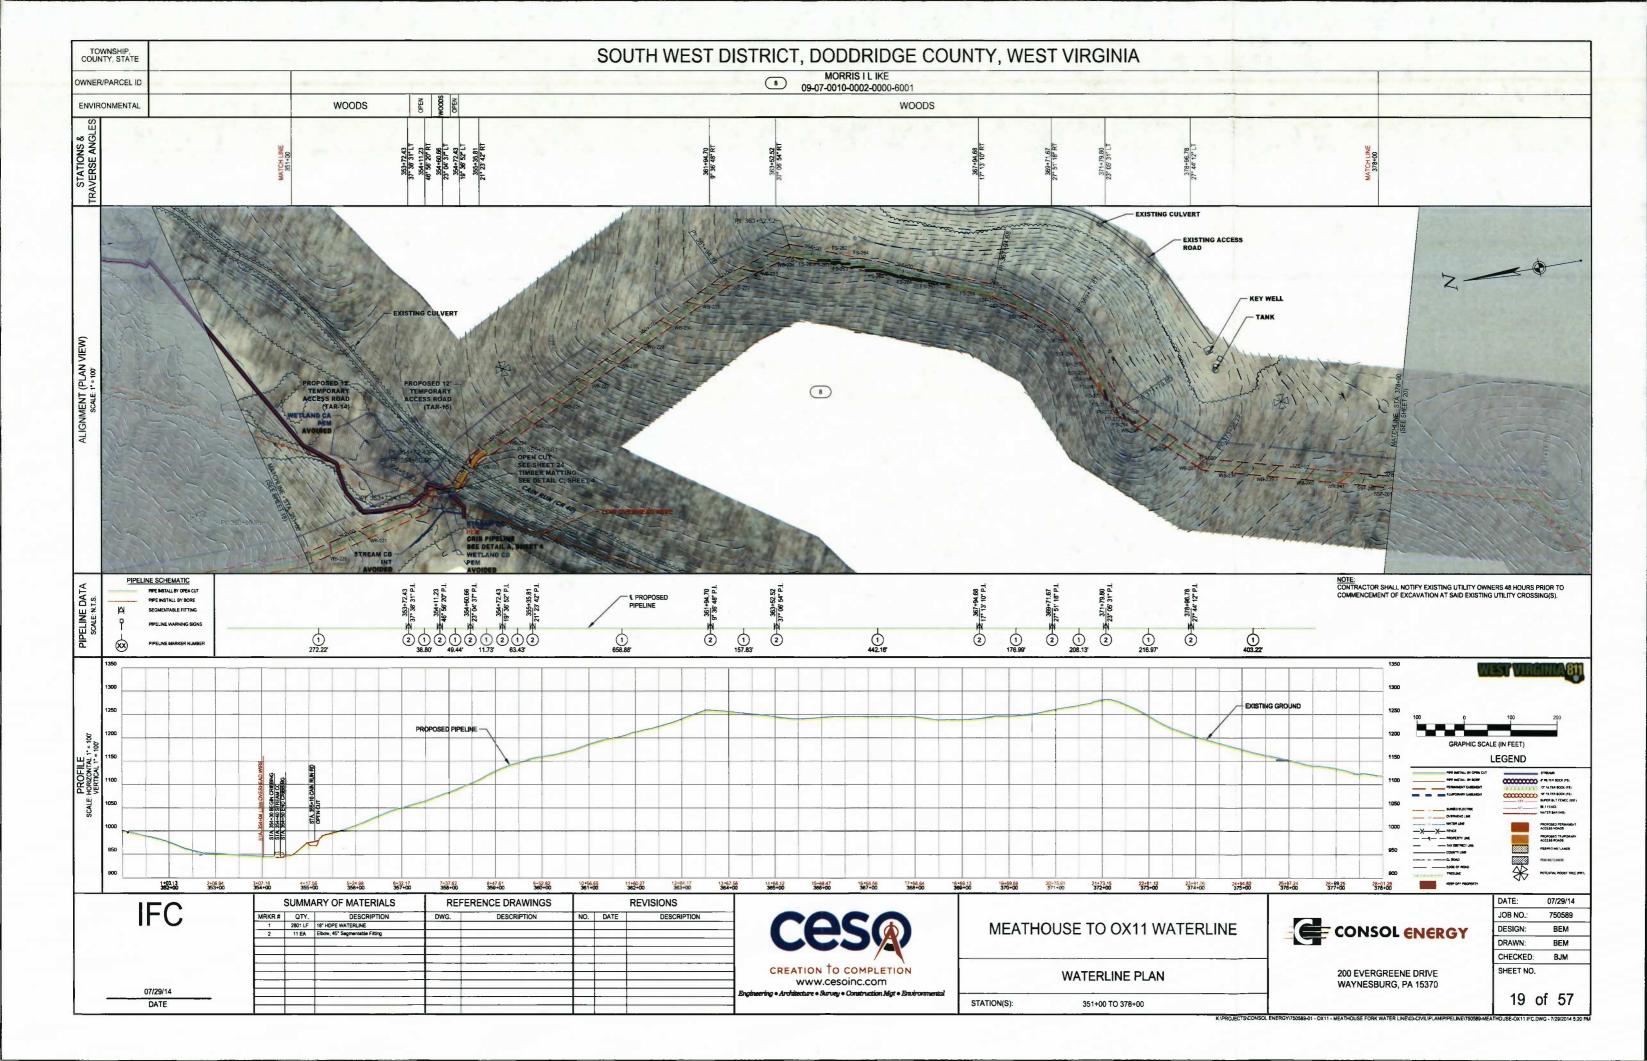


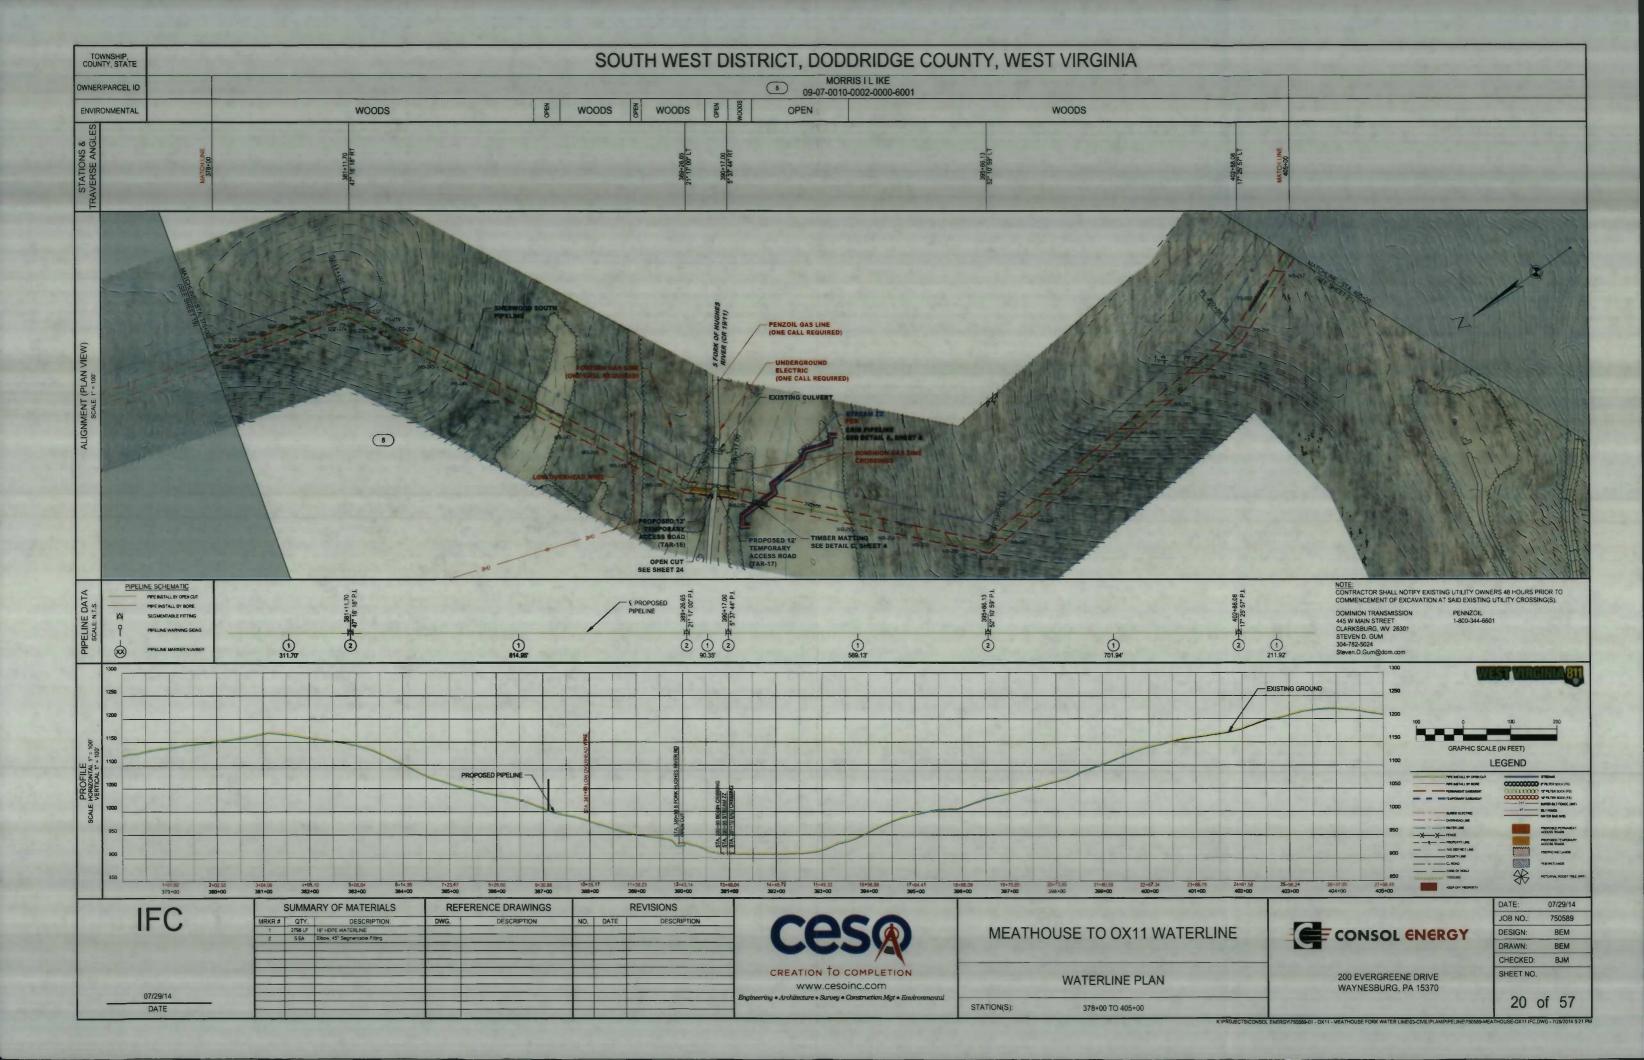

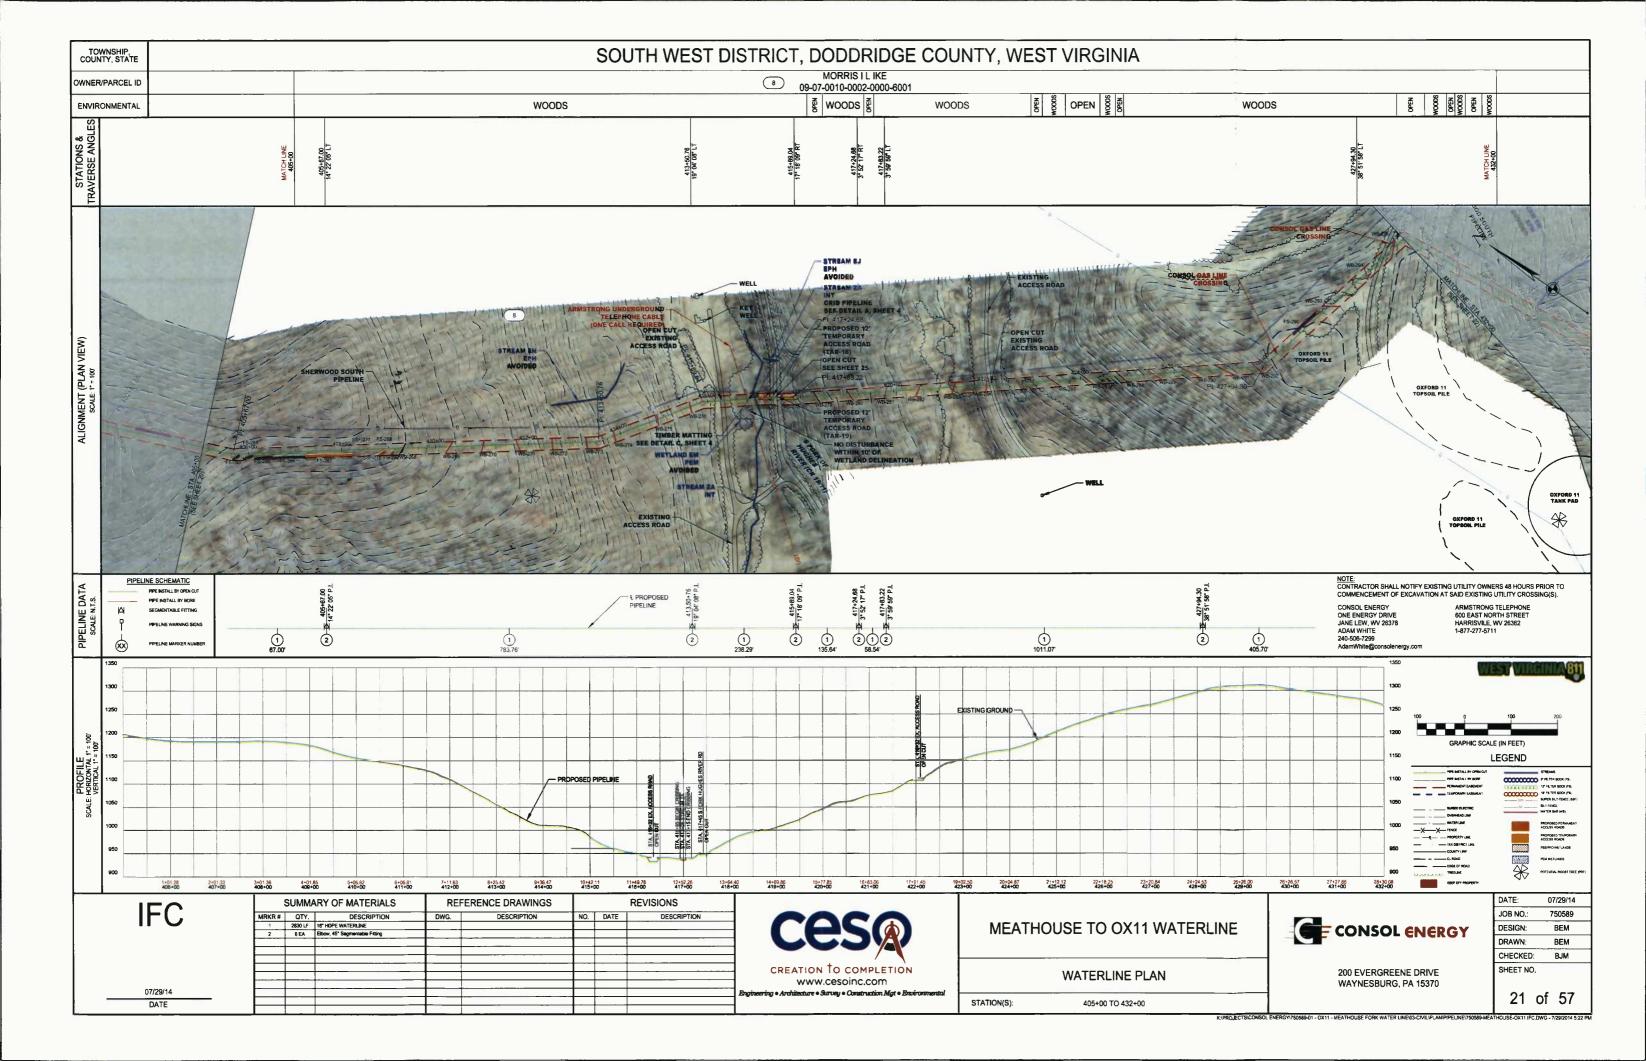

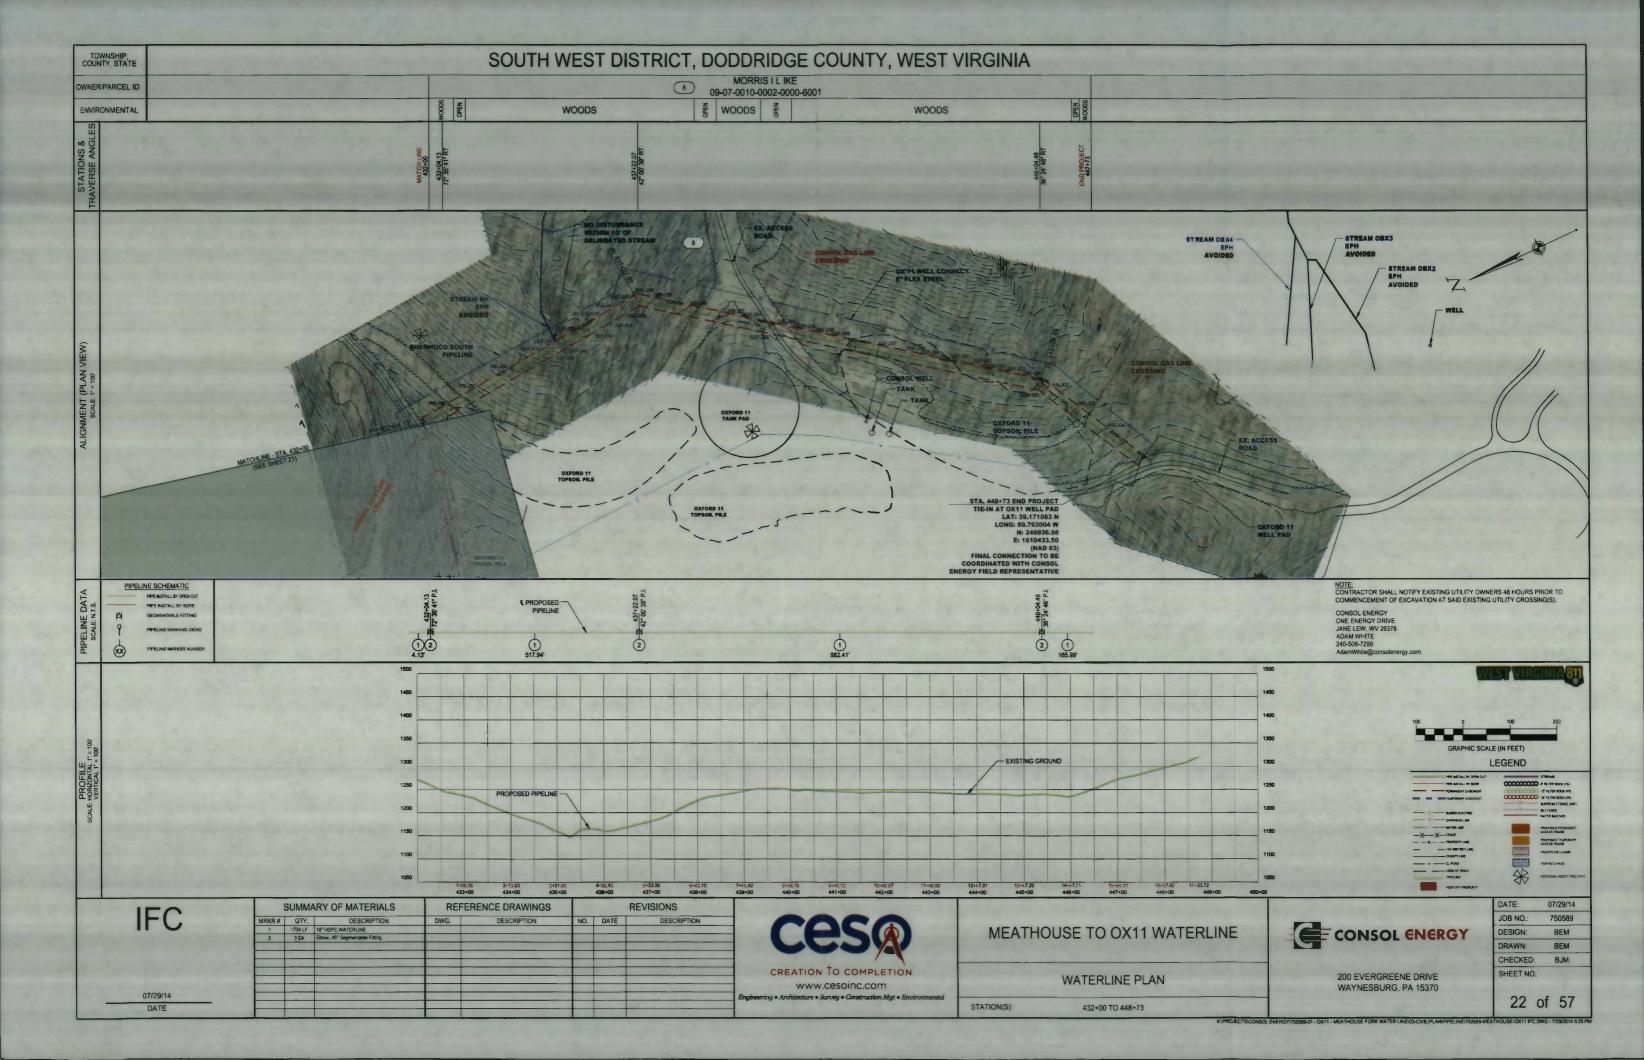

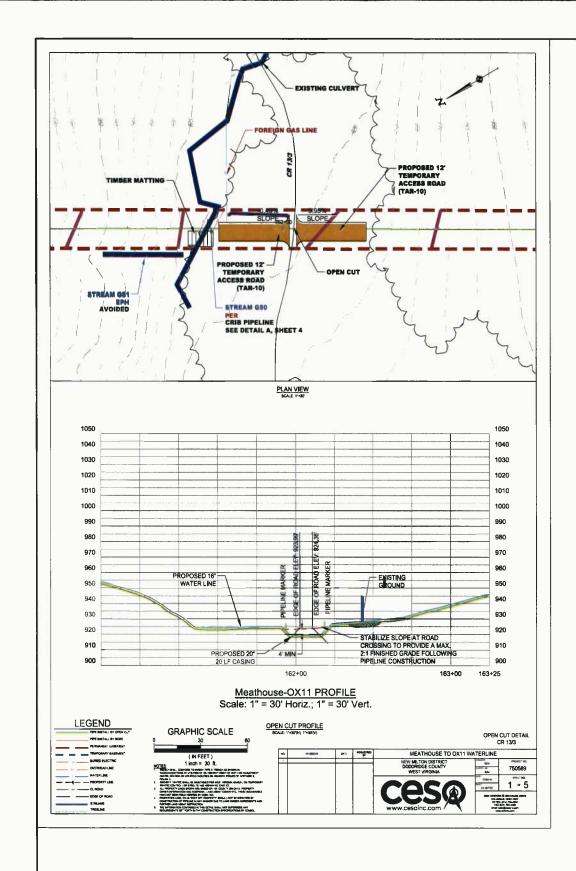

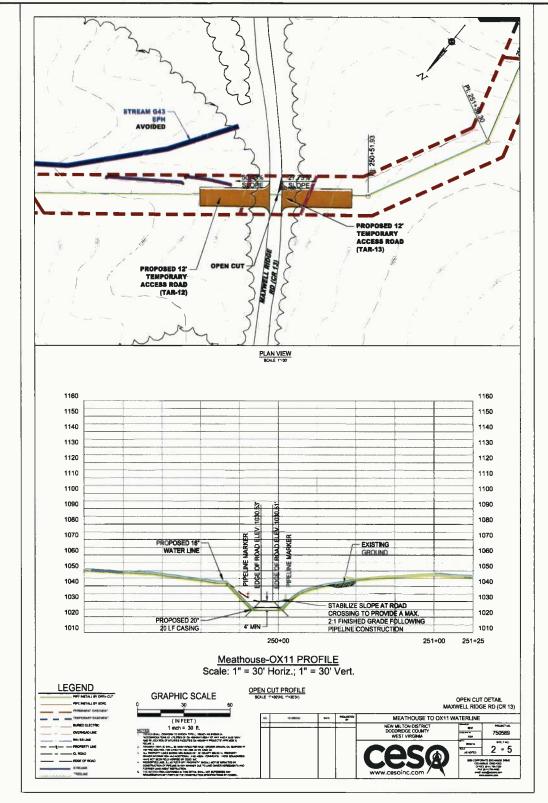

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ROAD CROS


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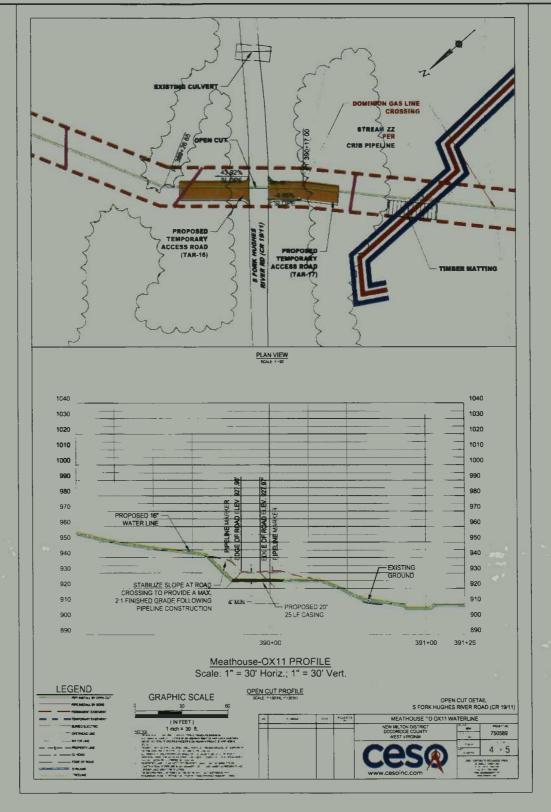
SSING DETAILS	200 EVERGREENE D WAYNESBURG, PA 1

	DATE:	07/29/14
	JOB NO.:	750589
CONSOL ENERGY	DESIGN:	ВЕМ
CONTROL CINCKO	DRAWN:	BEM
	CHECKED:	ВЈМ
200 EVEDODEENE DON'E	SHEET NO.	

15370

K (PROJECTS)CONSOL ENERGY(750589-01 - 0X11 - MEATHOUSE FORK WATER LINE(G-CIVILIPLAMPIPELINE)ROAD CROSSING DETAILS, DWG - 7/29/2014 3:59 PM



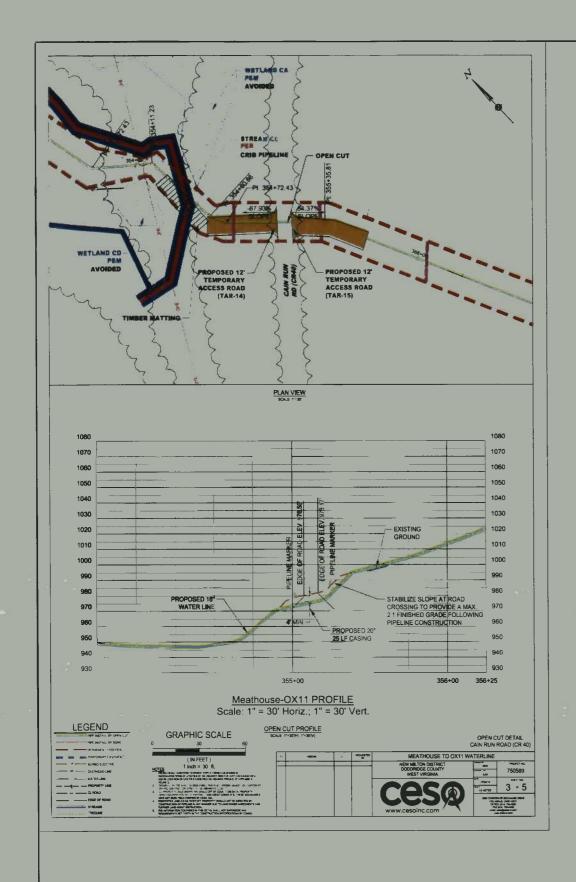

IFO		SUMMARY OF MATERIALS			REFERENCE DRAWINGS		REVISIONS		
IFC	MRKR#	QTY.	DESCRIPTION	DWG.	DESCRIPTION	NO.	DATE	DESCRIPTION	
07/29/14									
DATE	<u> </u>					_			





ROAD CROSSING DETAILS

STATION(S):

200 EVERGREENE DRIVE WAYNESBURG, PA 15370

DATE:	07/29/14
JOB NO.:	750589
DESIGN:	BEM
DRAWN:	BEM
CHECKED:	BJM
SHEET NO.	

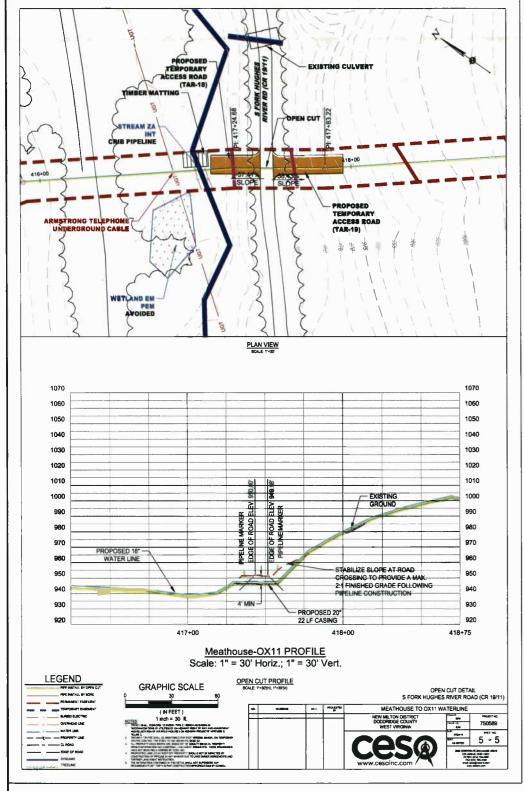

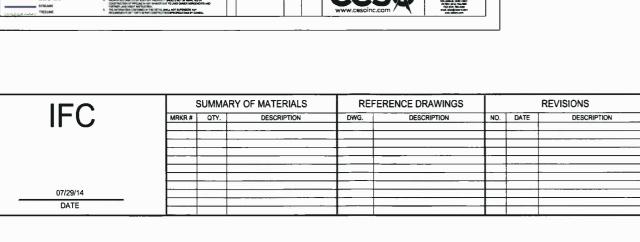





ROAD CROSSING DETAILS


CONSOL ENERGY


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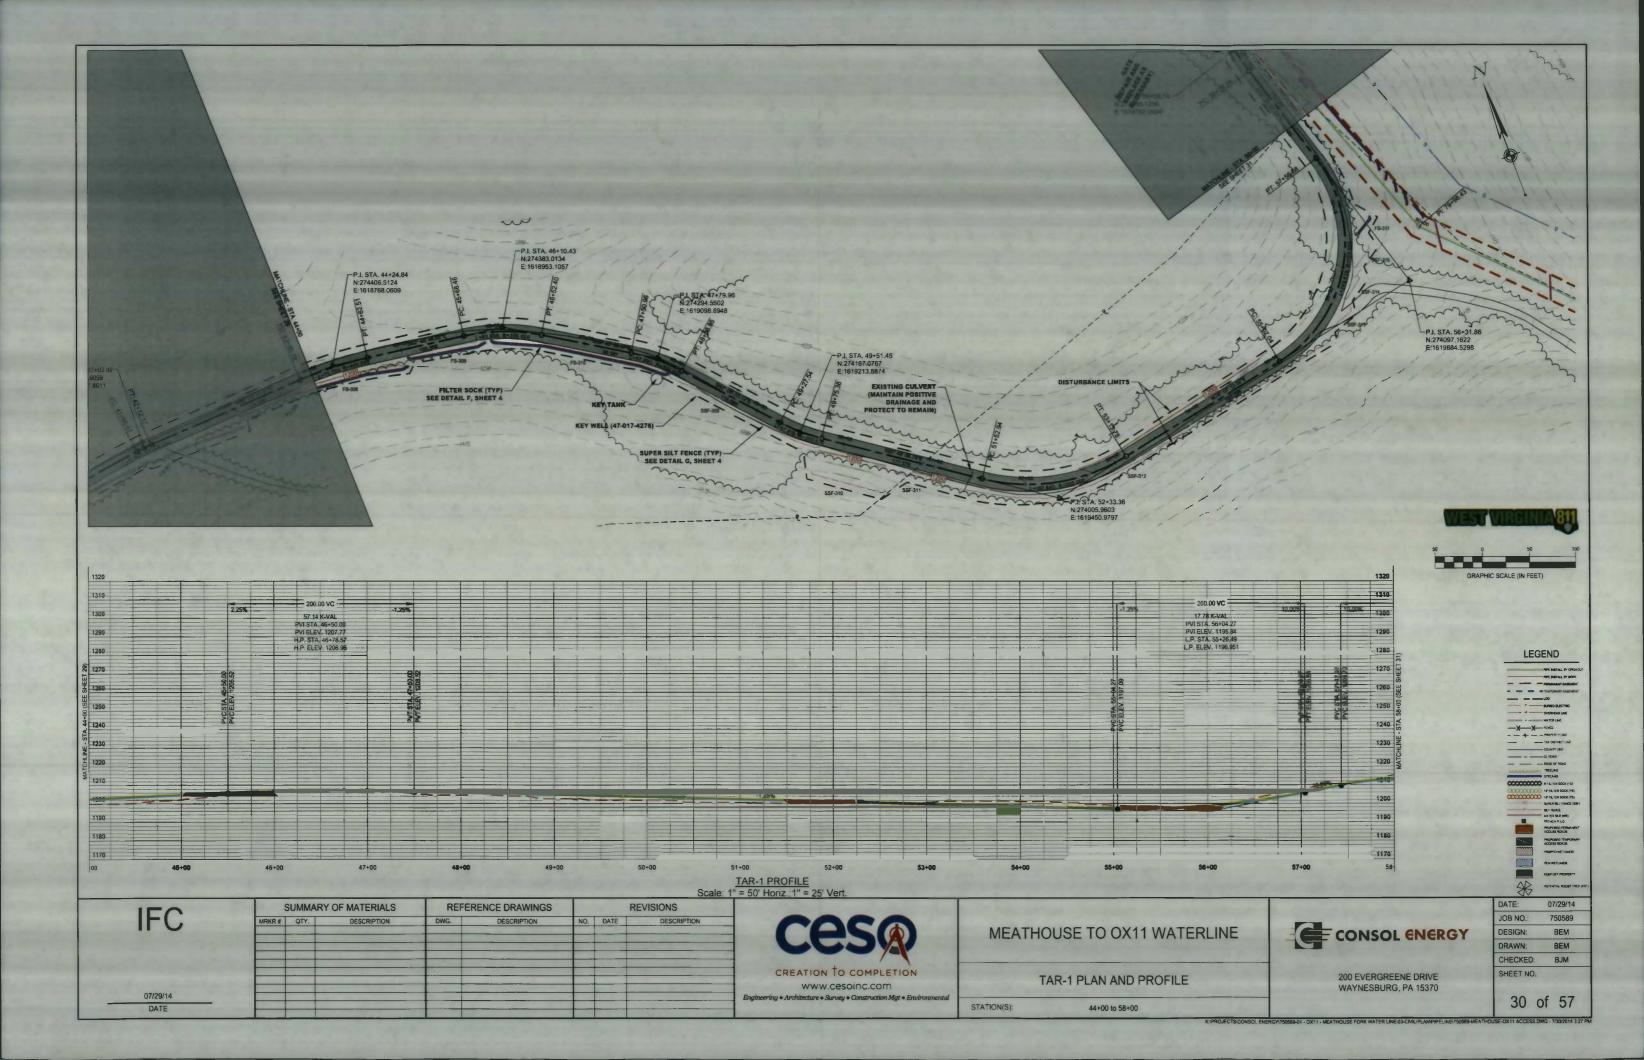
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CHECKED:	ВЈМ
SHEET NO.	




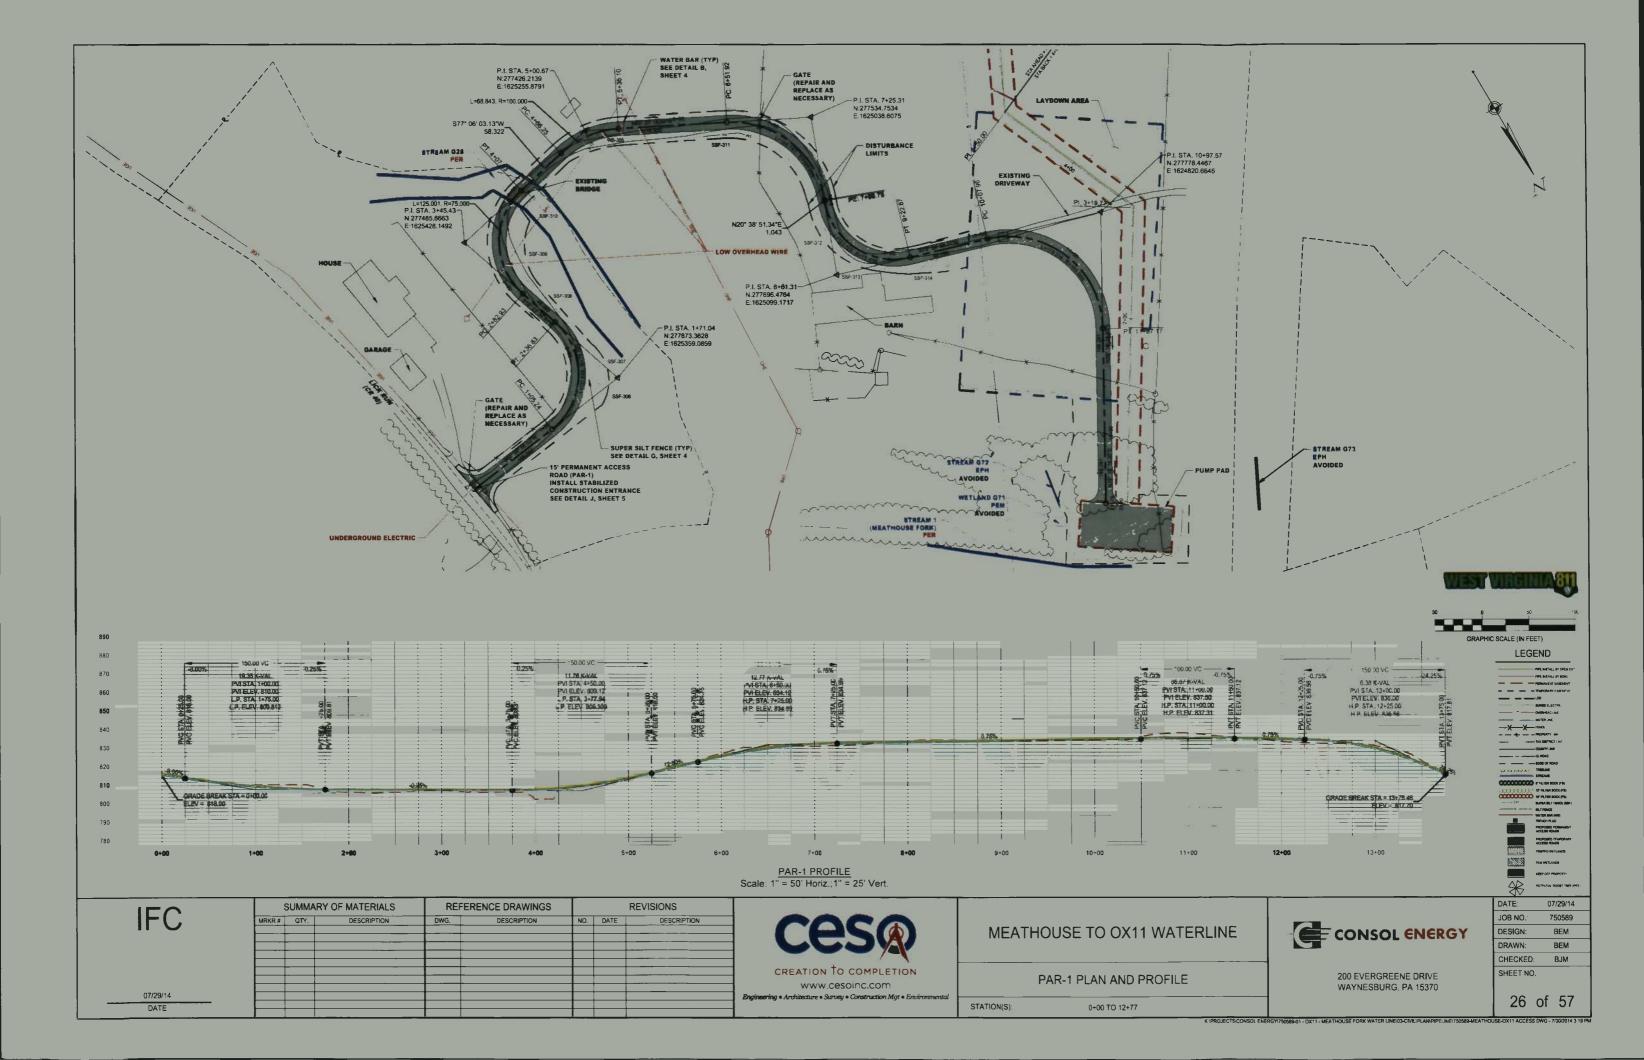


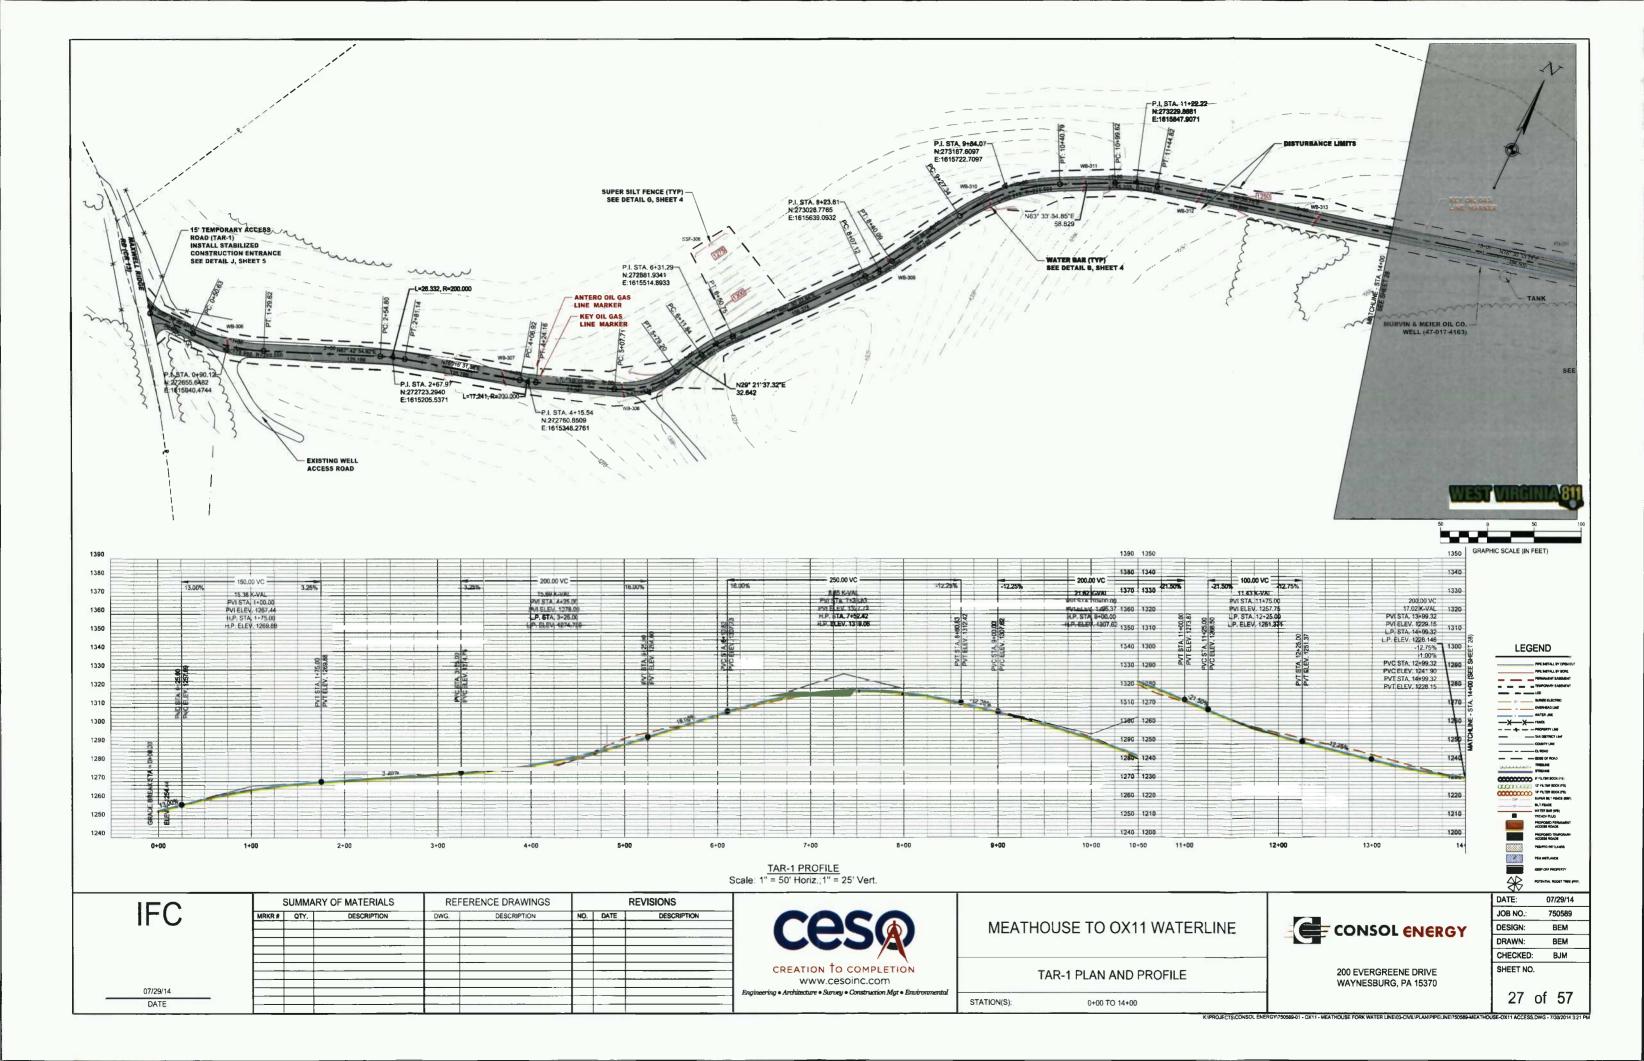


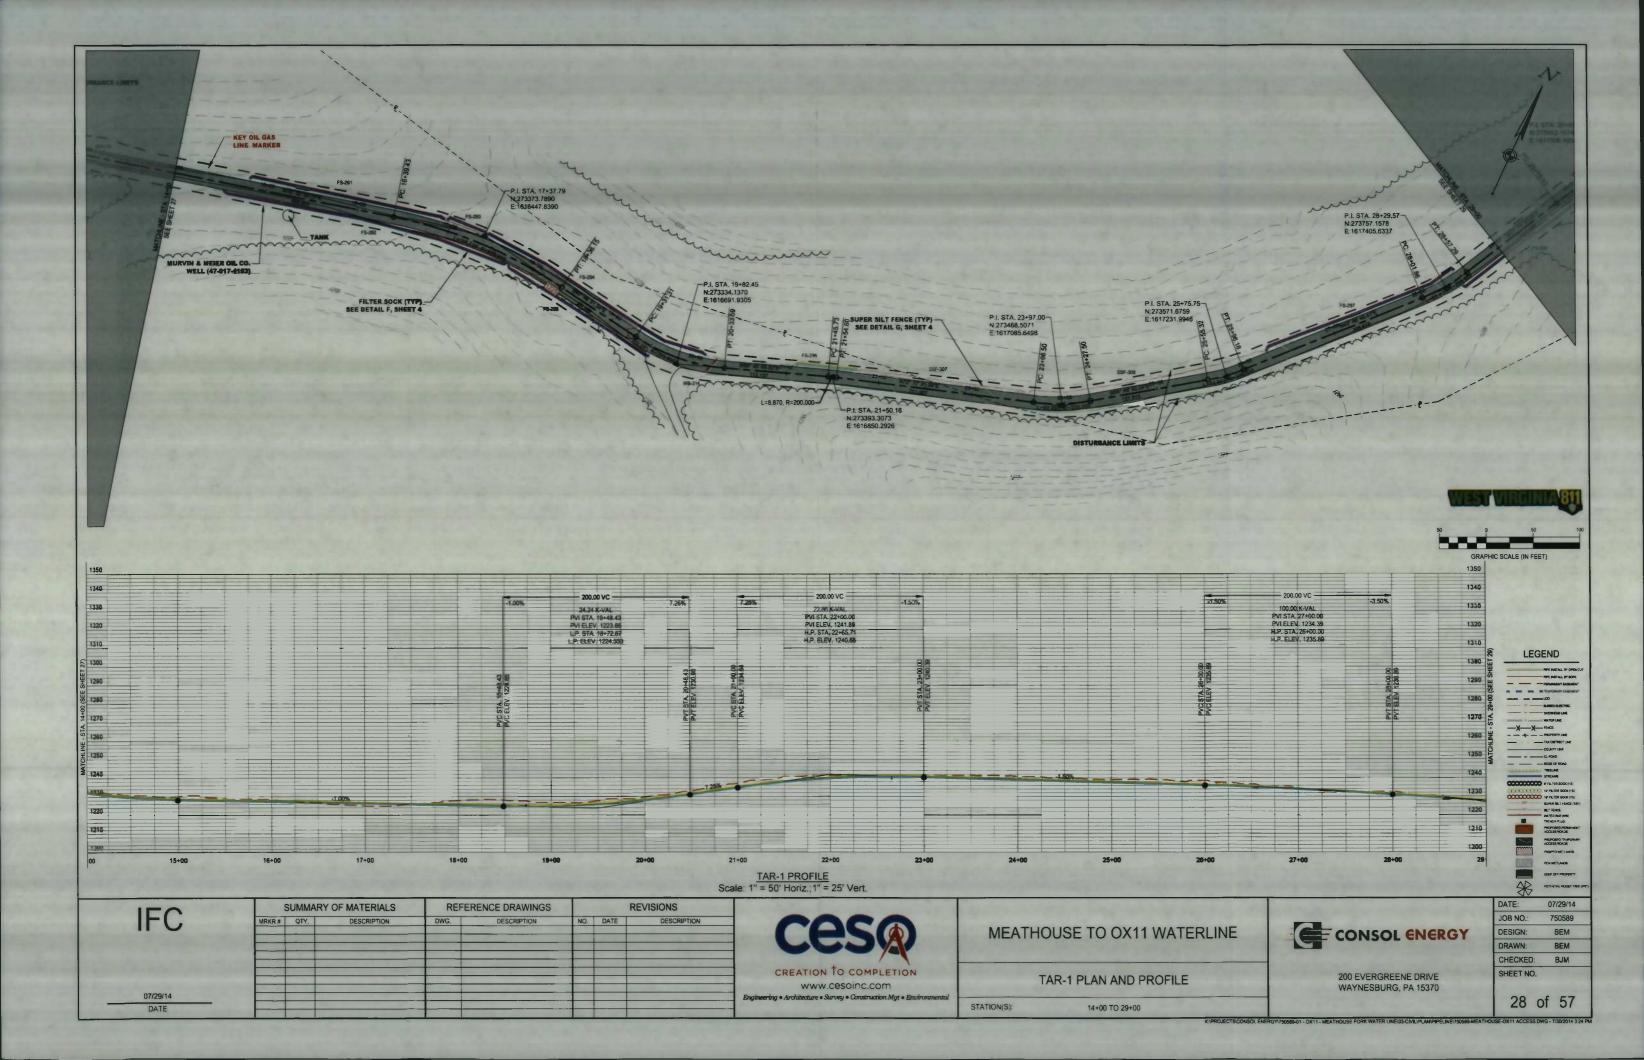


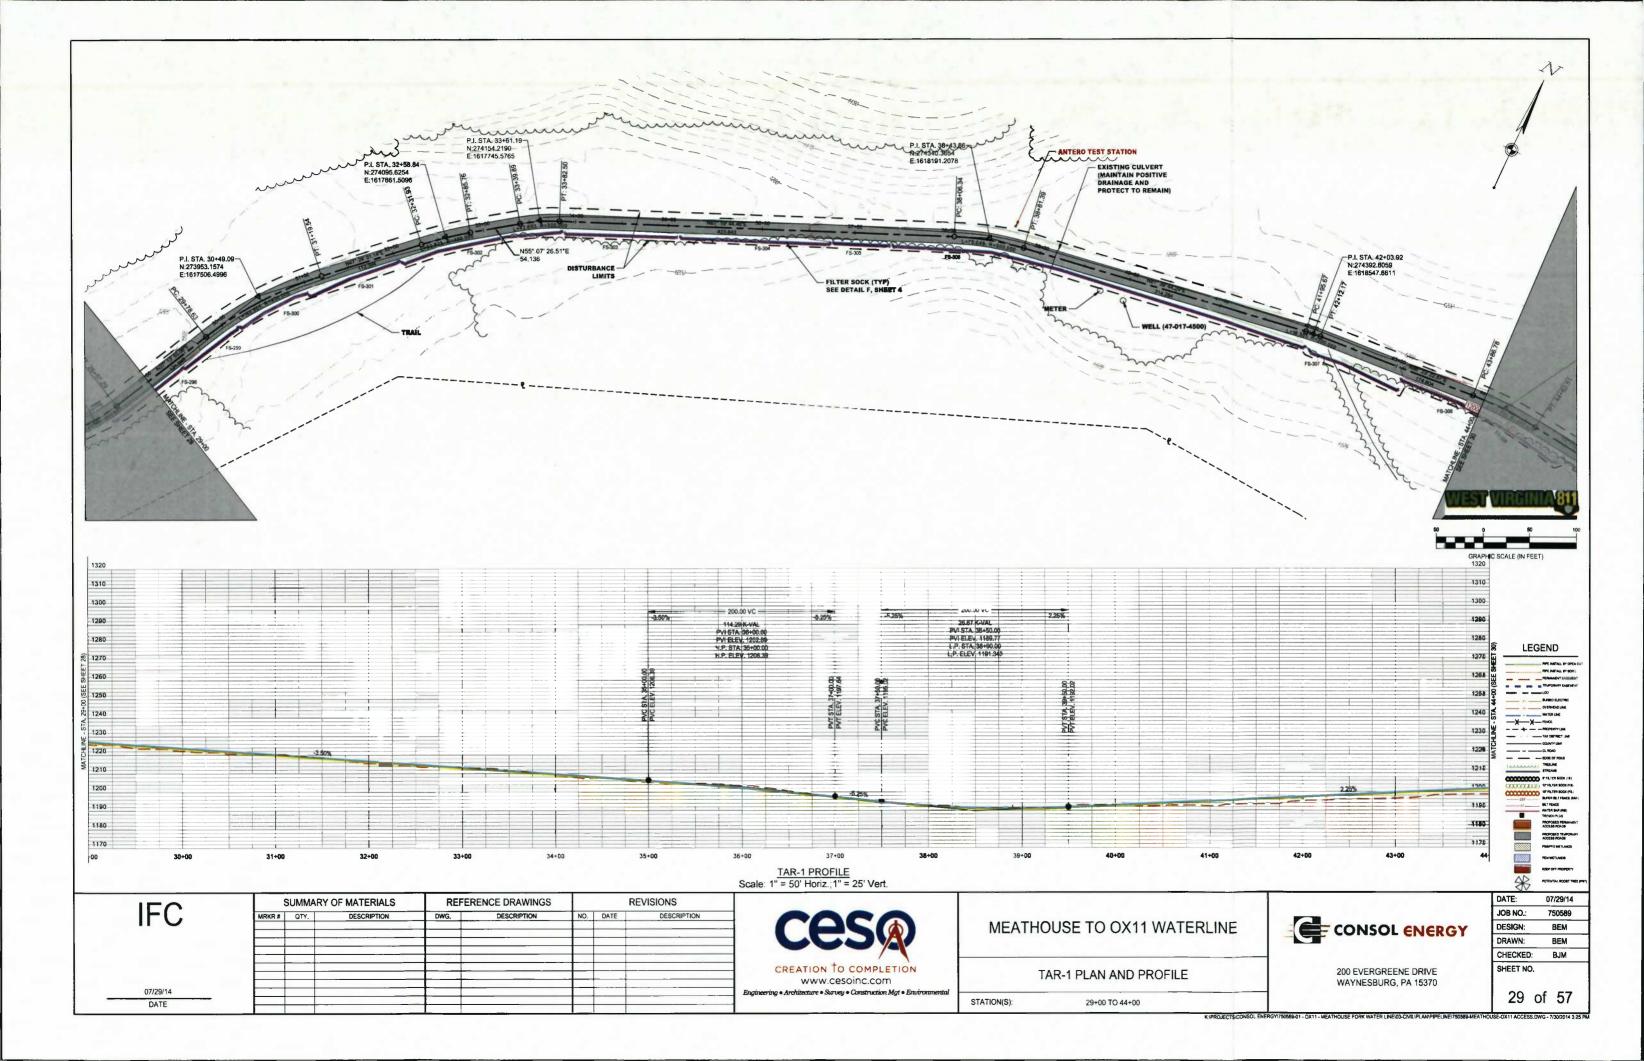


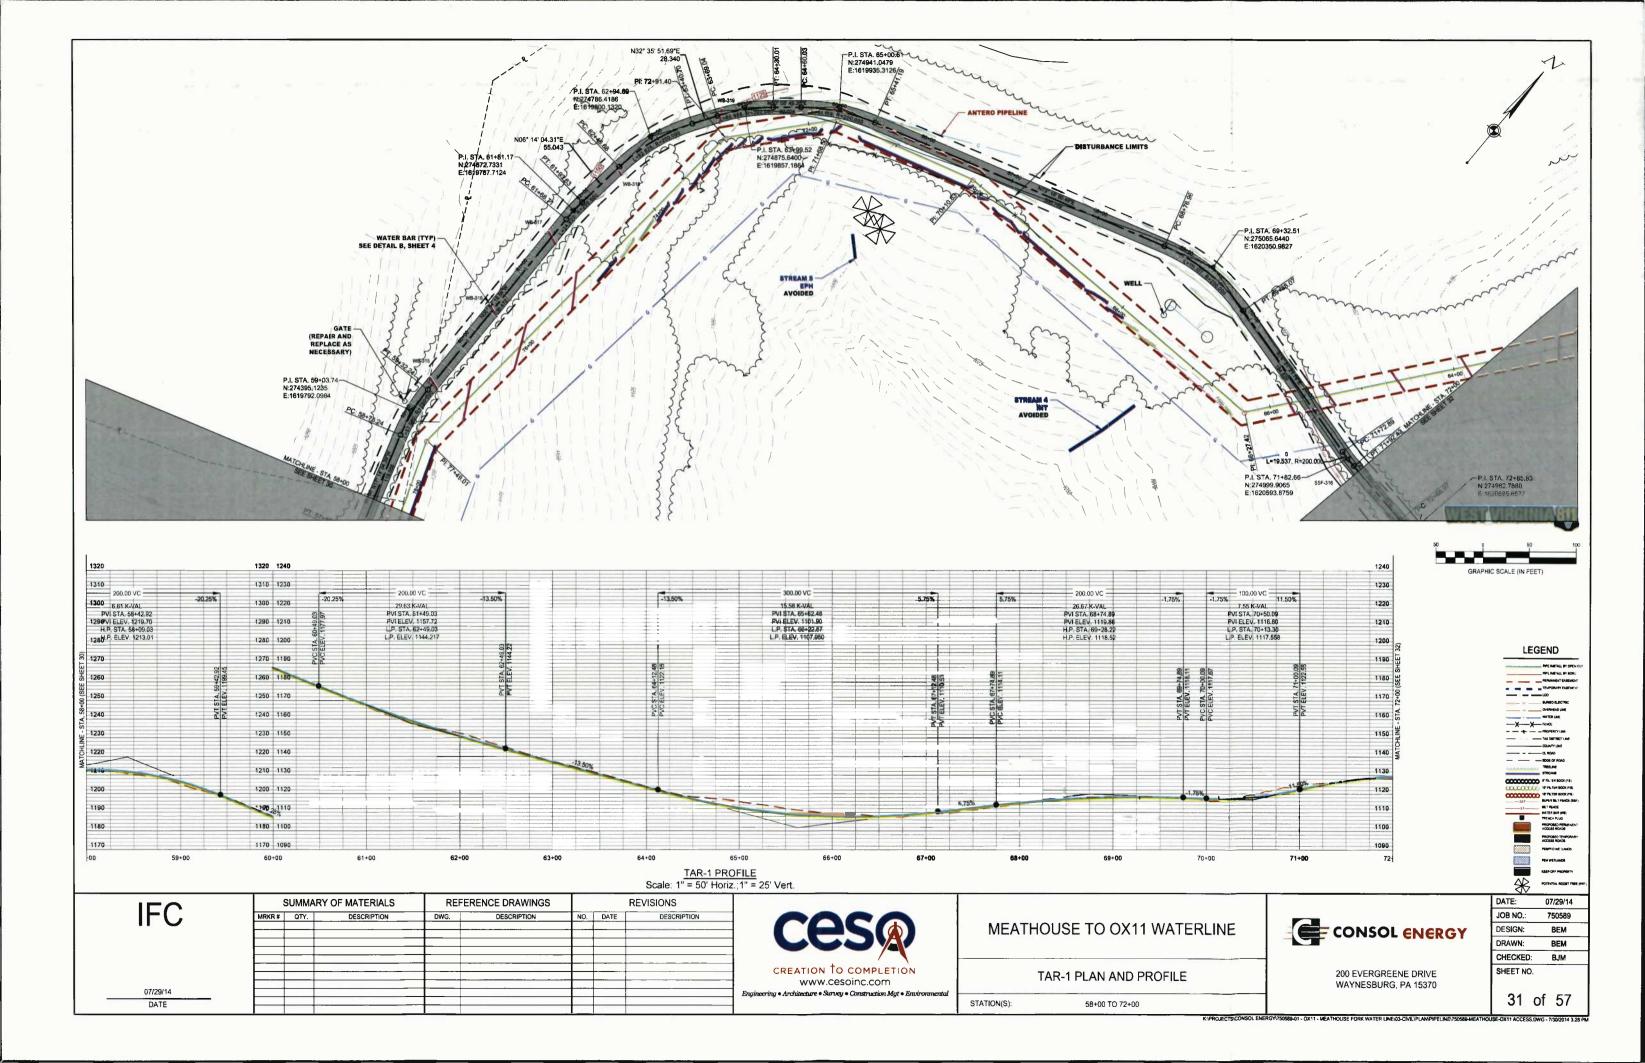


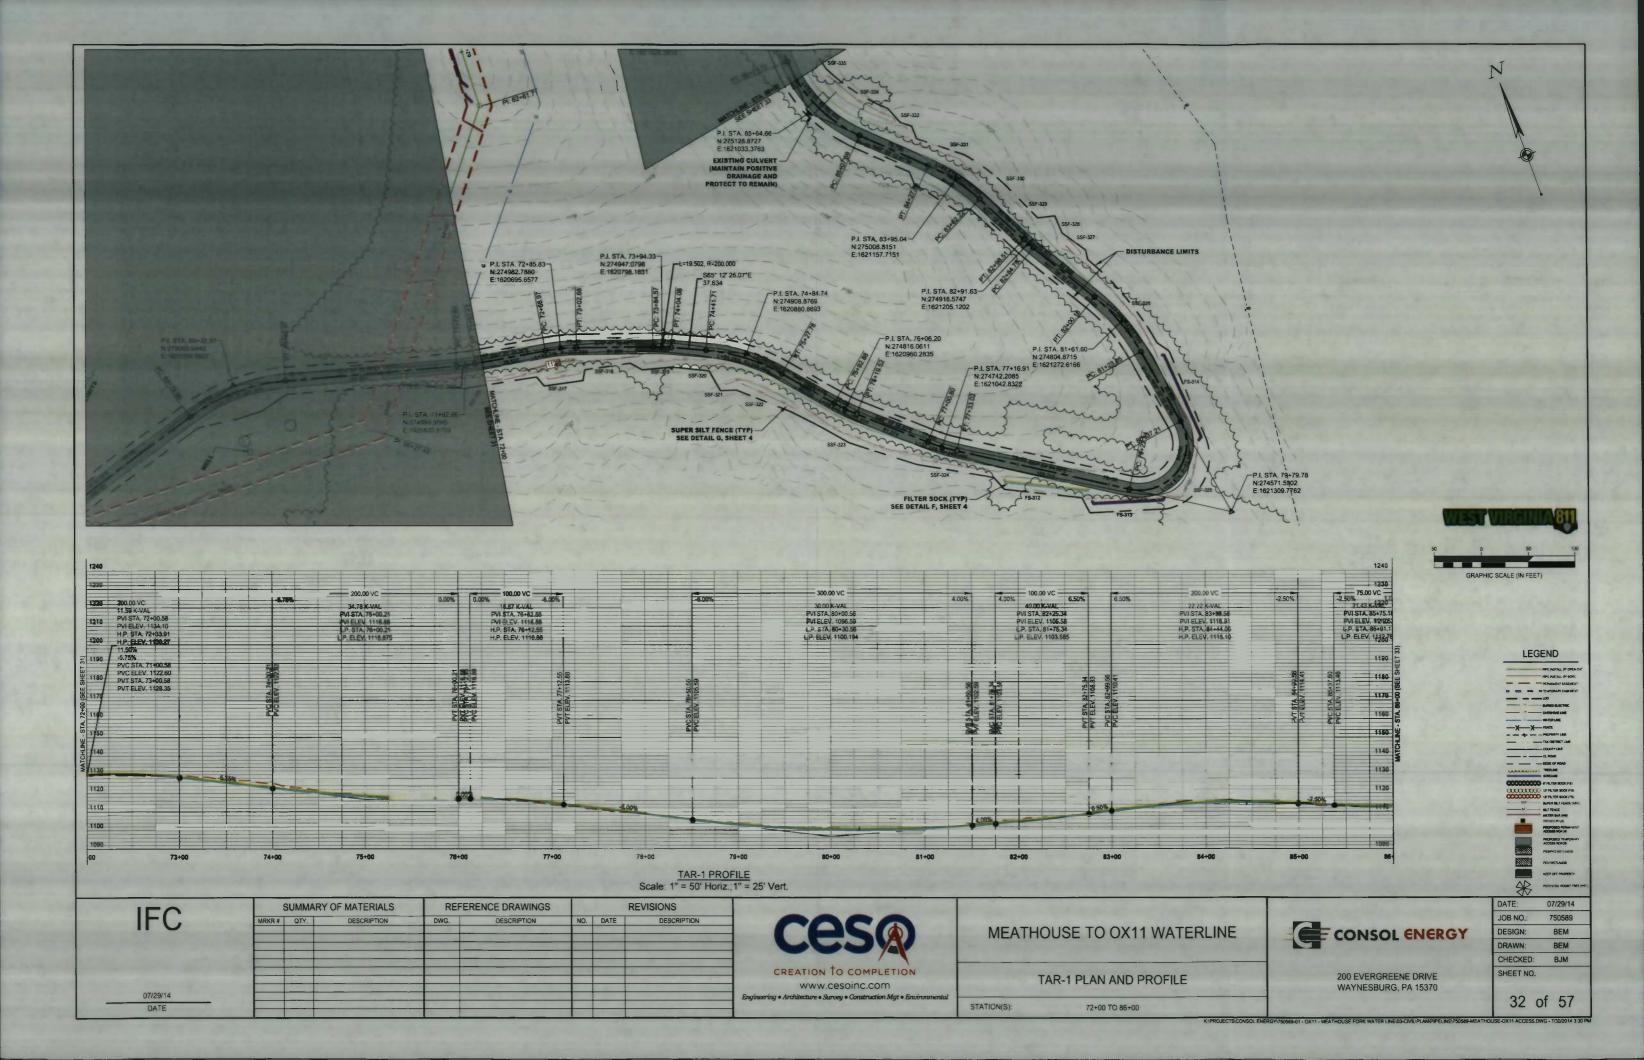


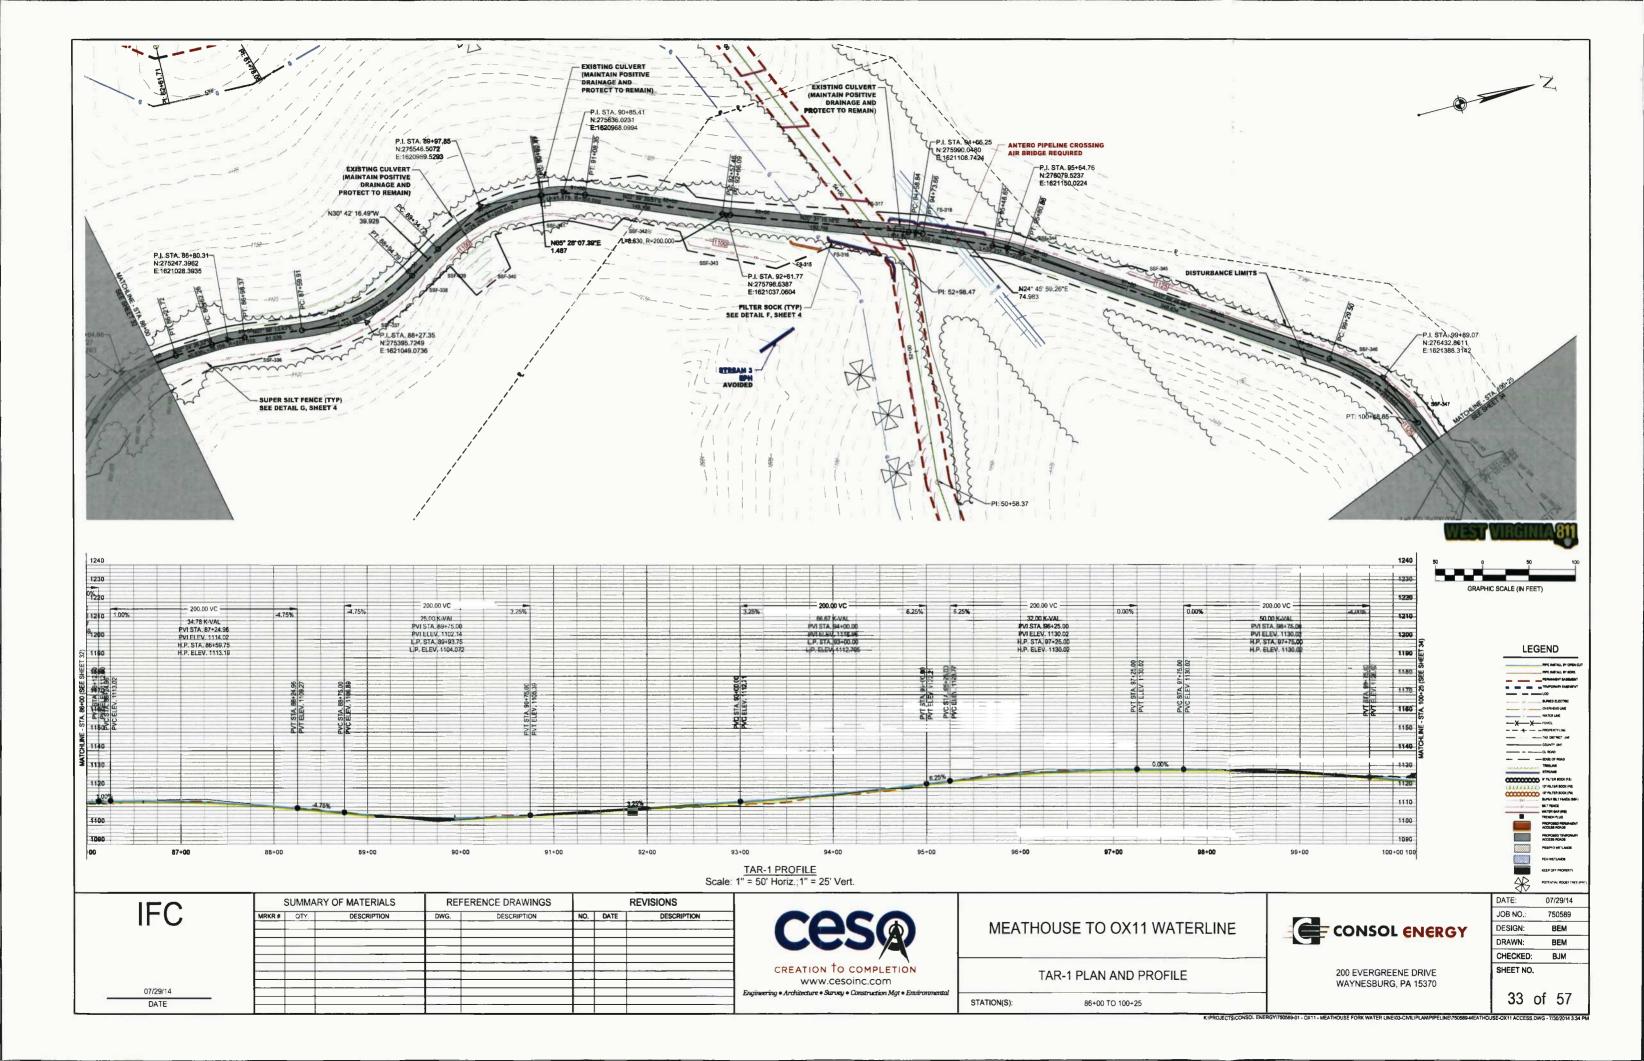


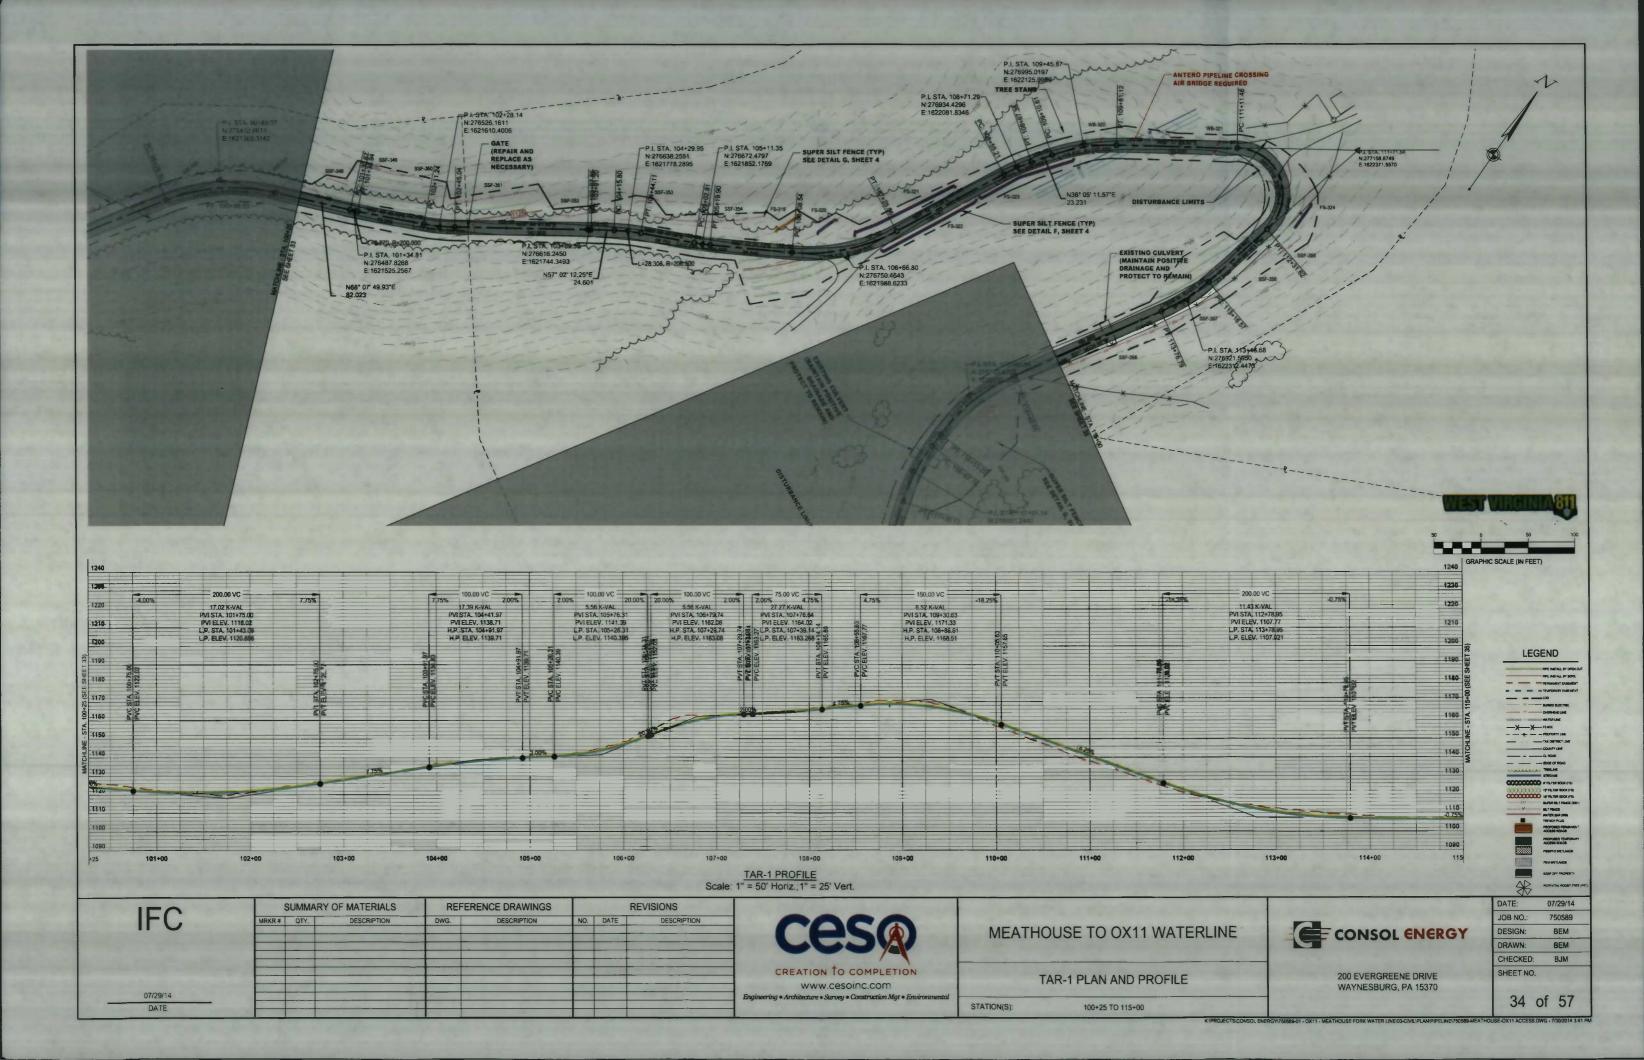


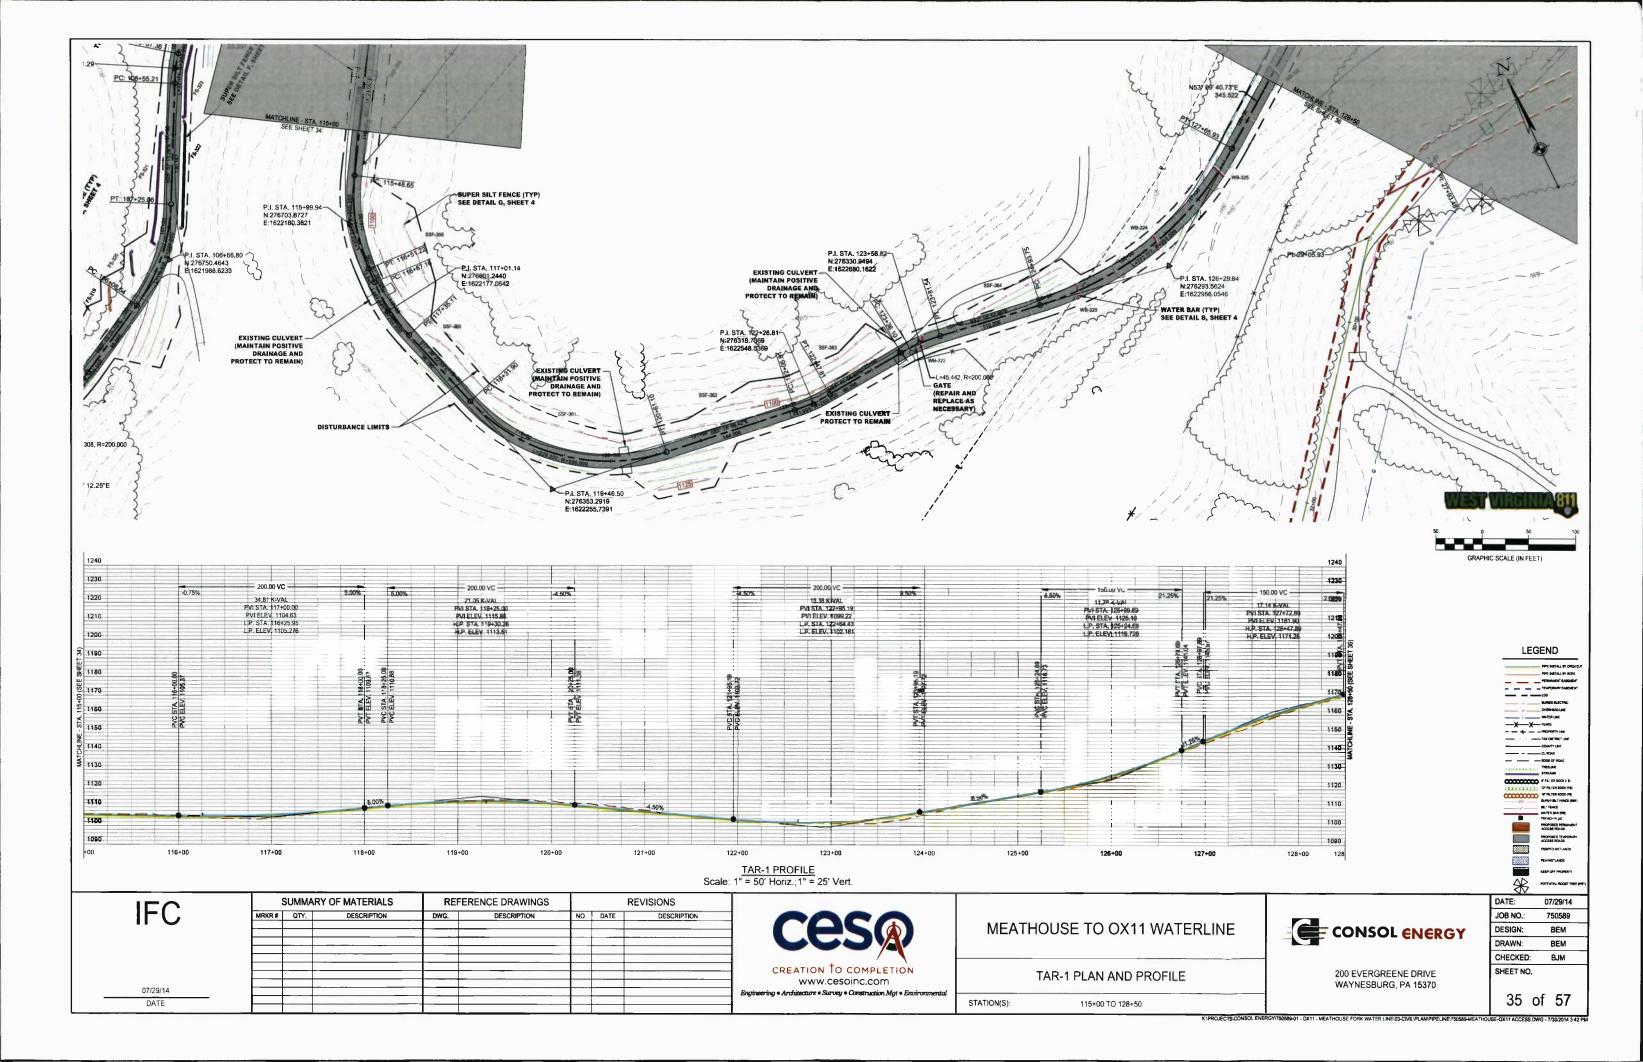

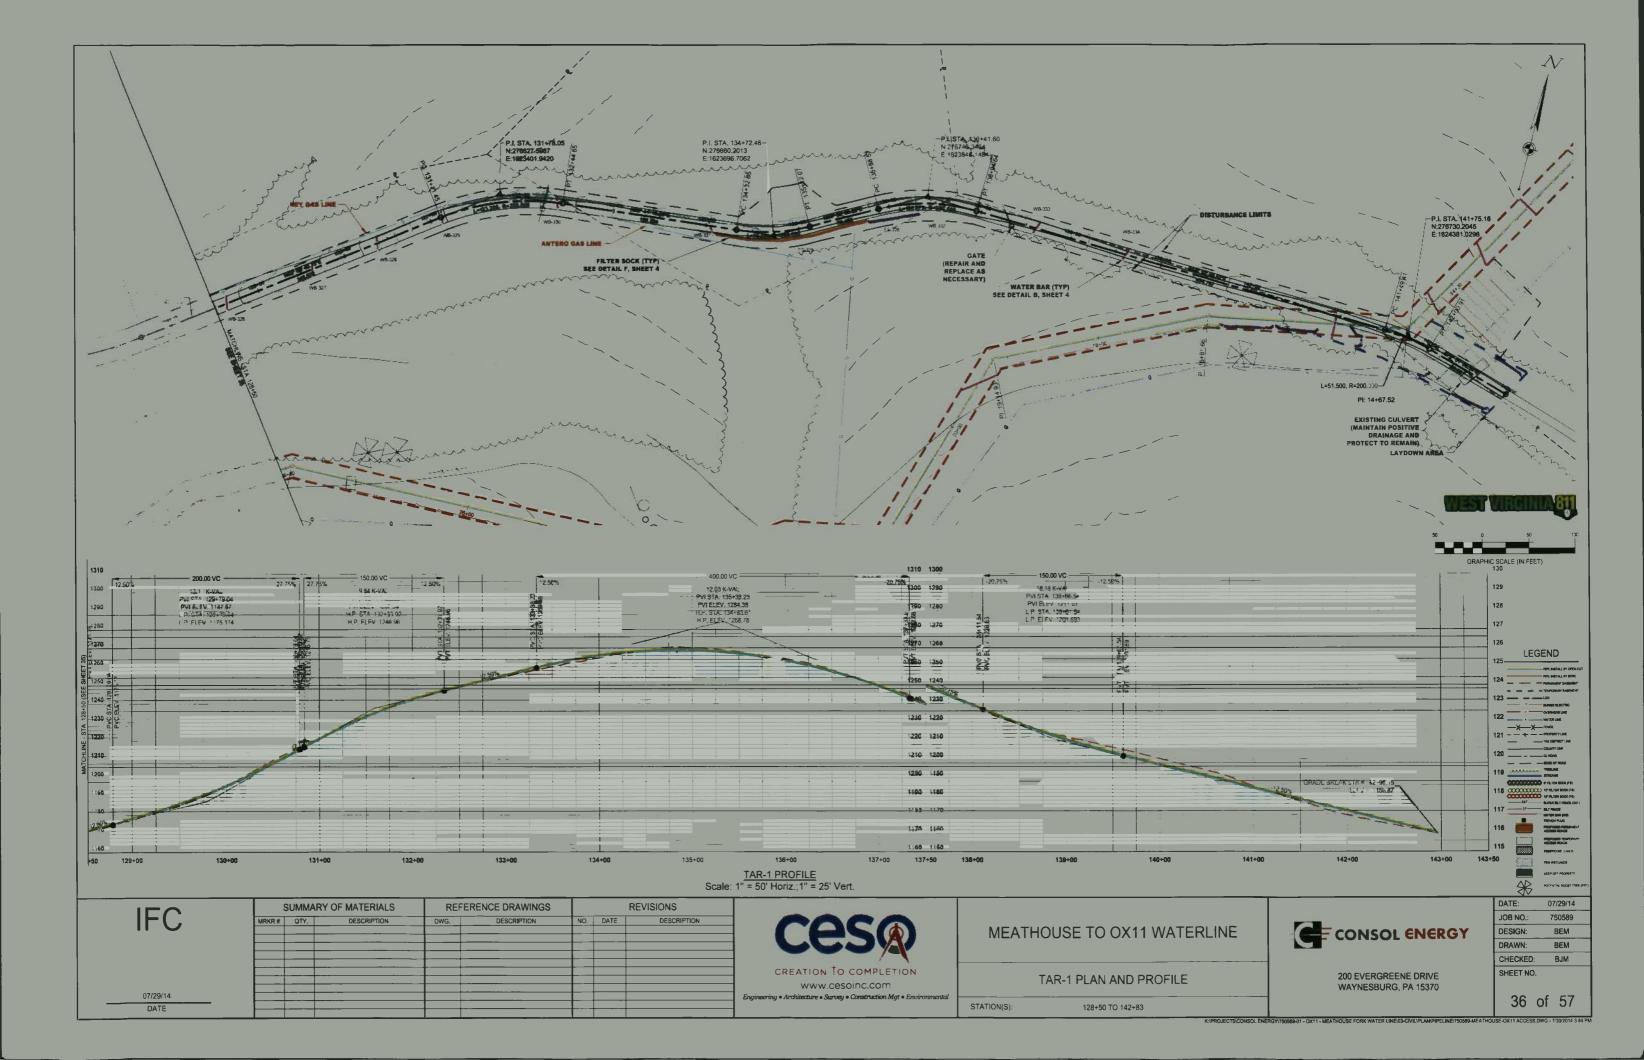

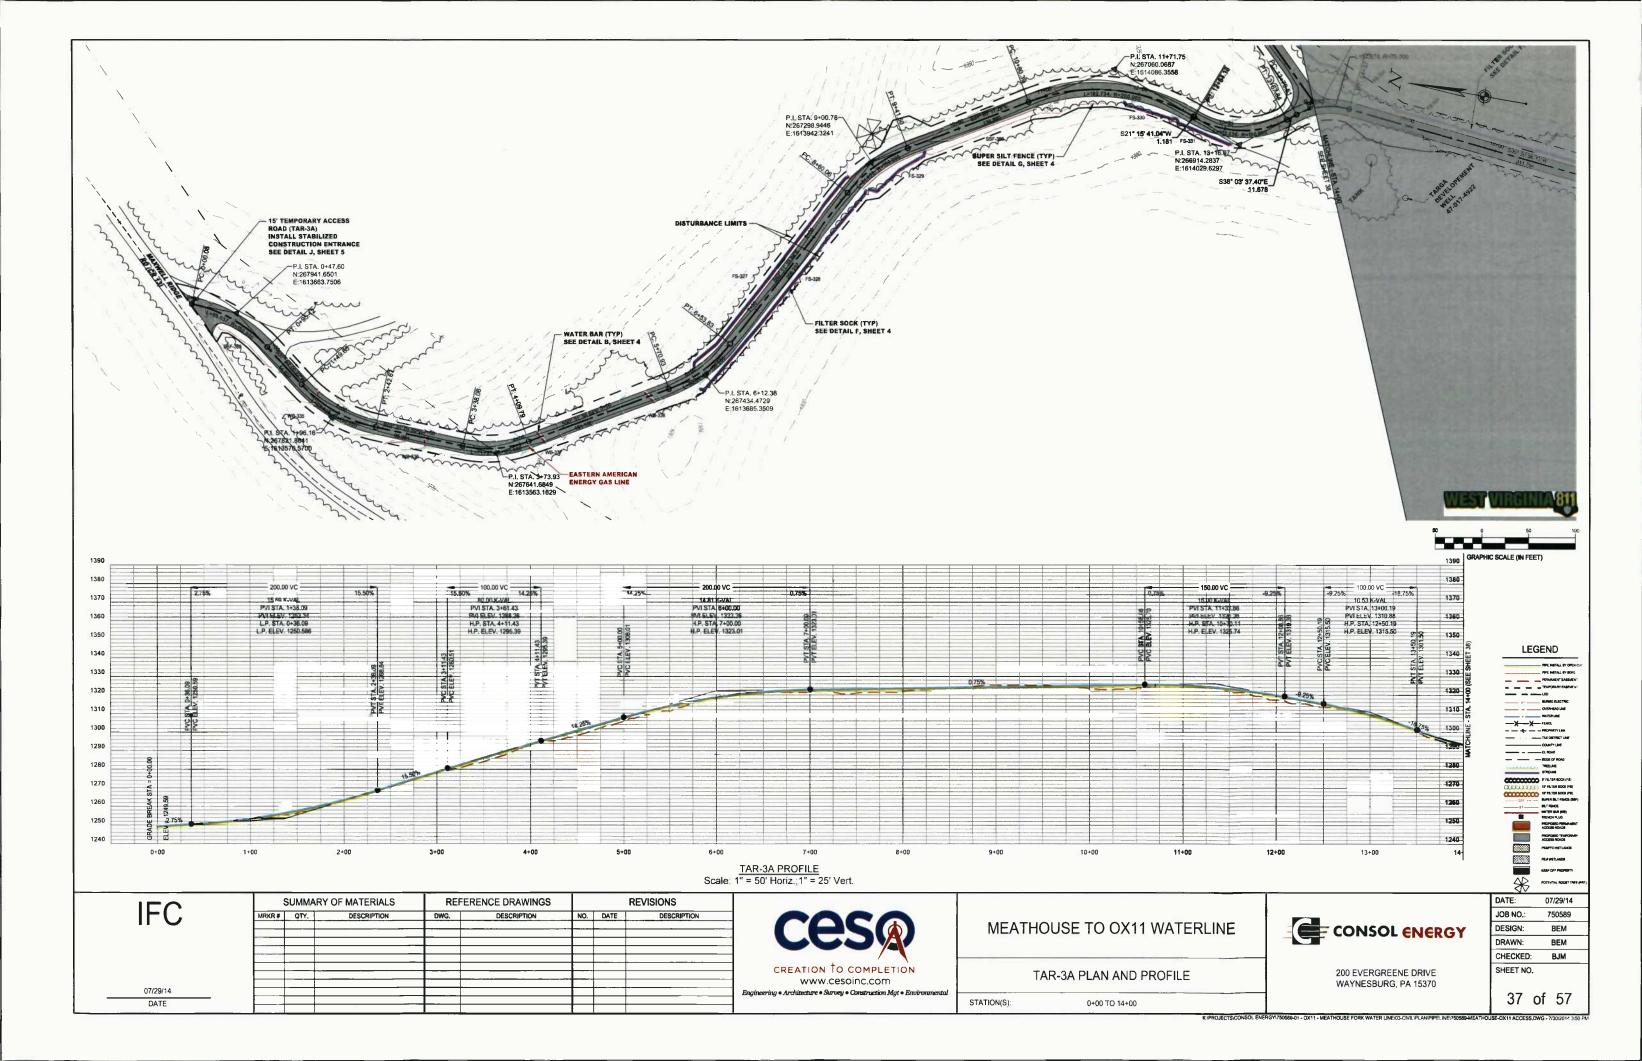

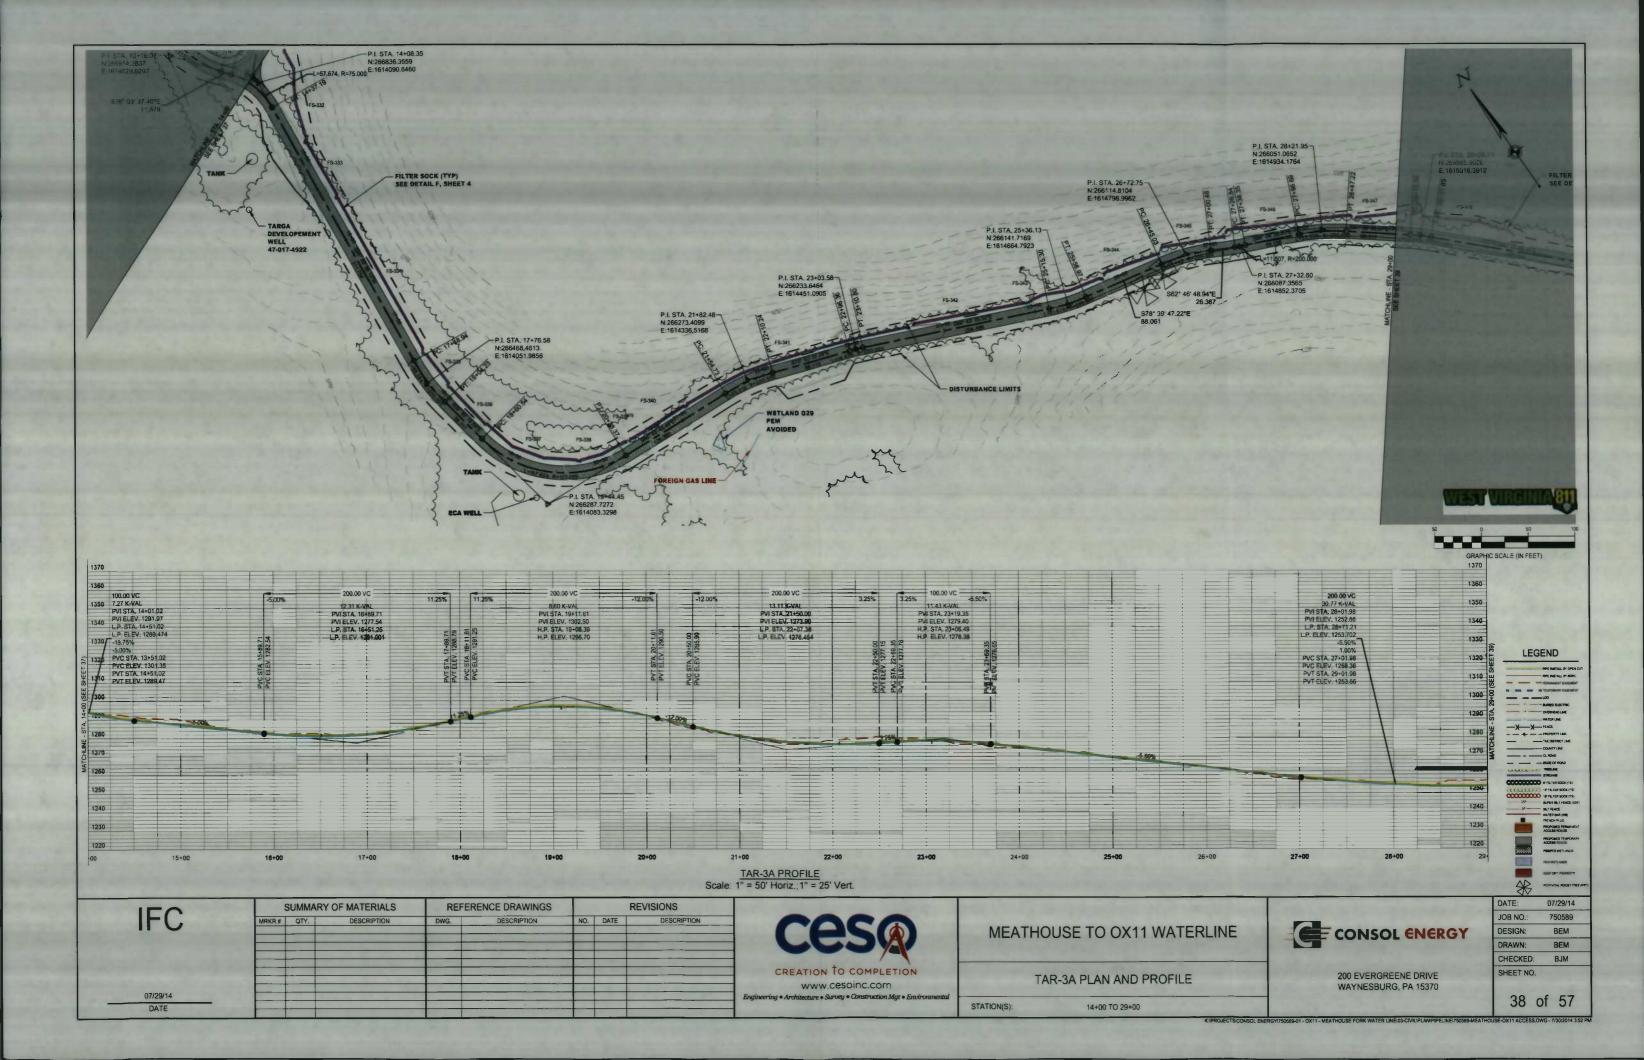


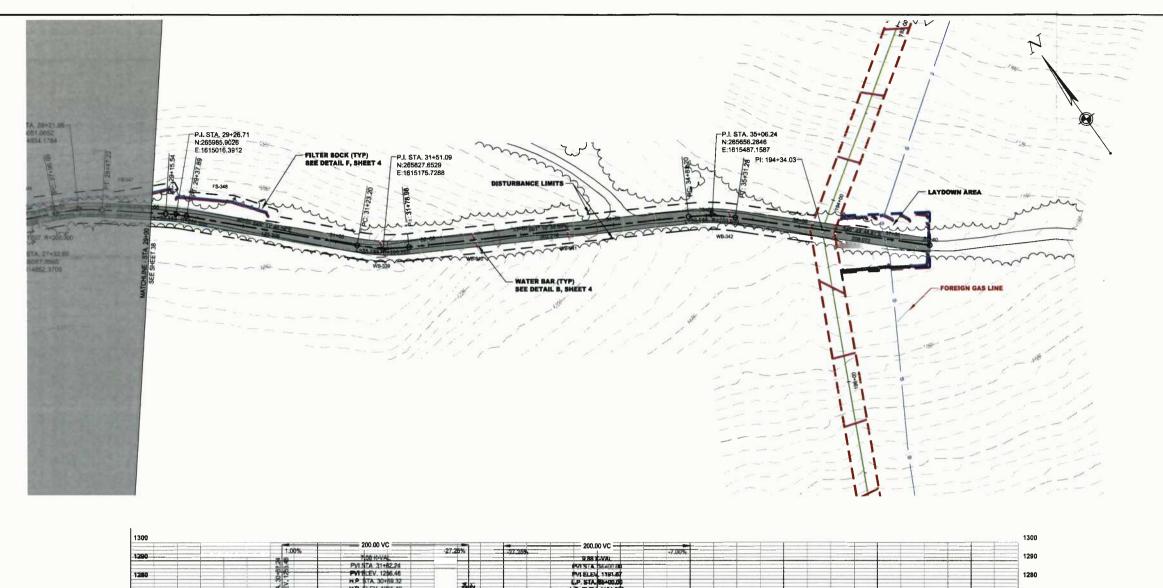



LEGEND

TO DEFINITION OF THE PROPERTY OF THE PROPERTY

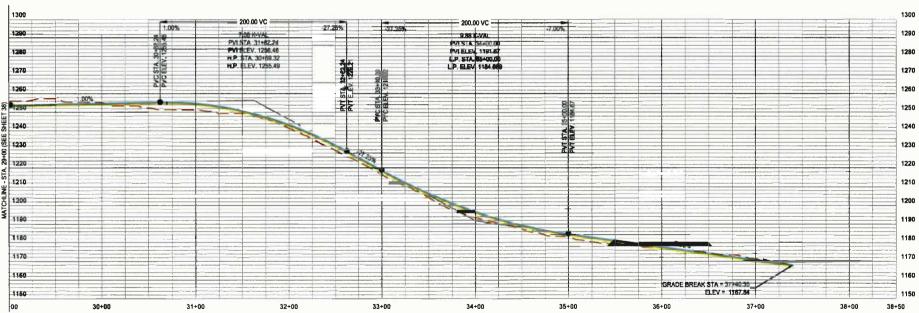

TAR-3A PROFILE
Scale: 1" = 50' Horiz.;1" = 25' Vert.

REVISIONS

CREATION TO COMPLETION www.cesoinc.com

MEATHOUSE TO OX11 WATERLINE

TAR-3A PLAN AND PROFILE

29+00 TO 37+40

C	CONSOL	ENER	GY
	COMSOL	CHEK	GT

200 EVERGREENE DRIVE WAYNESBURG, PA 15370

	*	REEP OFF PROPERTY POTENTIAL ROOST TREE (PRI)
	DATE:	07/29/14
	JOB NO.:	750589
,	DESIGN:	BEM
	DRAWN:	BEM
	CHECKED:	ВЈМ
	SHEET NO.	


39 of 57


07/29/14	


IFO	SU		SUMMARY OF MATERIALS		REFERENCE DRAWINGS		REVISIONS		
	MRKR#	QTY.	DESCRIPTION	DWG.	DESCRIPTION	NO.	DATE	DESCRIPTION	
_									
								· 	
07/29/14									
DATE						+			

REFERENCE DRAWINGS

SUMMARY OF MATERIALS

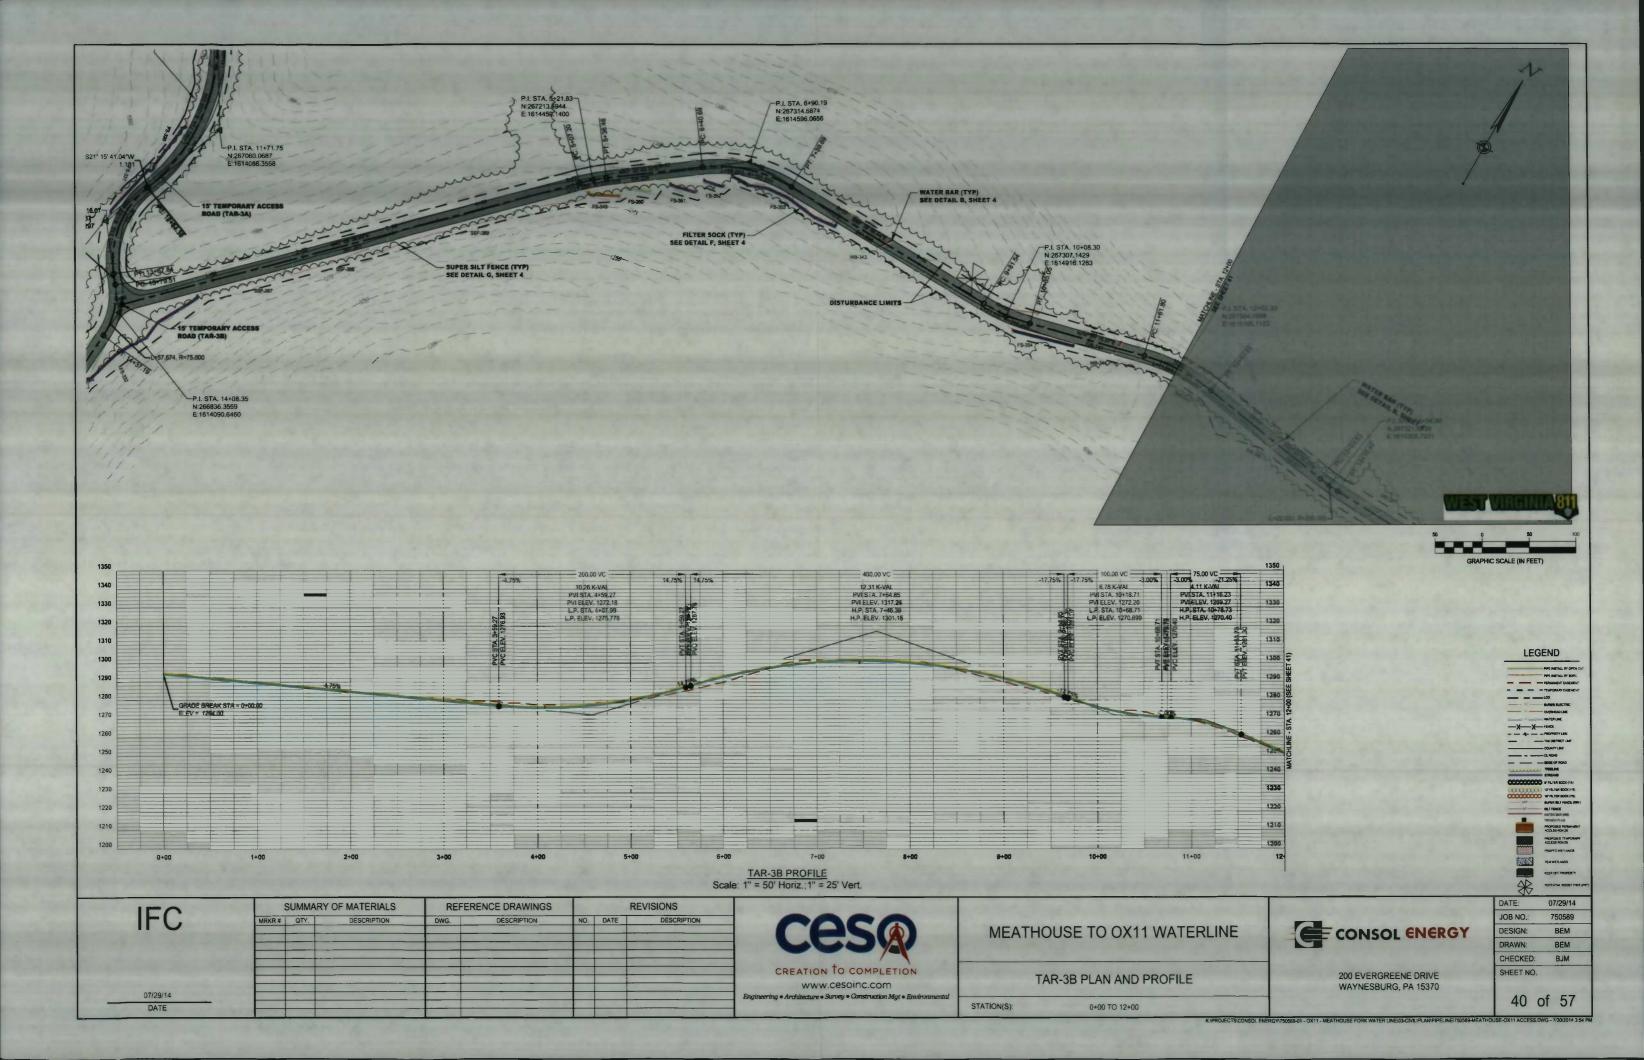

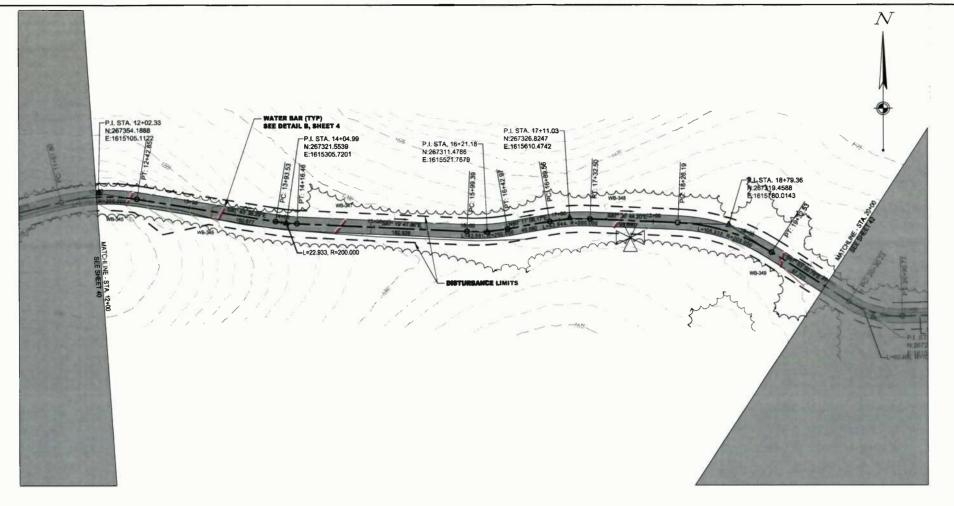

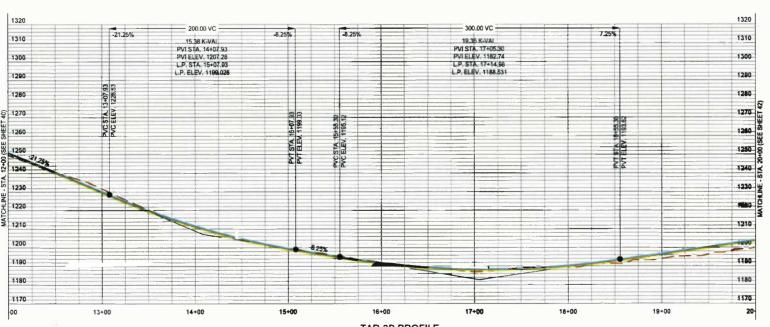

TAR-3B PROFILE
Scale: 1" = 50' Horiz.;1" = 25' Vert.

SUMMARY OF MATERIALS REFERENCE DRAWINGS REVISIONS **IFC** NO. DATE 07/29/14 DATE



MEATHOUSE TO OX11 WATERLINE

TAR-3B PLAN AND PROFILE

STATION(S): 12+00 TO 20+00

CONSOL ENERGY

200 EVERGREENE DRIVE WAYNESBURG, PA 15370

1000000000	
	KEEP OF FROPERTY
*	POTENTIAL ROOST TREE (PAT)
DATE:	07/29/14
JOB NO.:	750589
DESIGN:	BEM
DRAWN:	BEM
CHECKED:	ВЈМ
SHEET NO.	
41	of 57


GRAPHIC SCALE (IN FEET)


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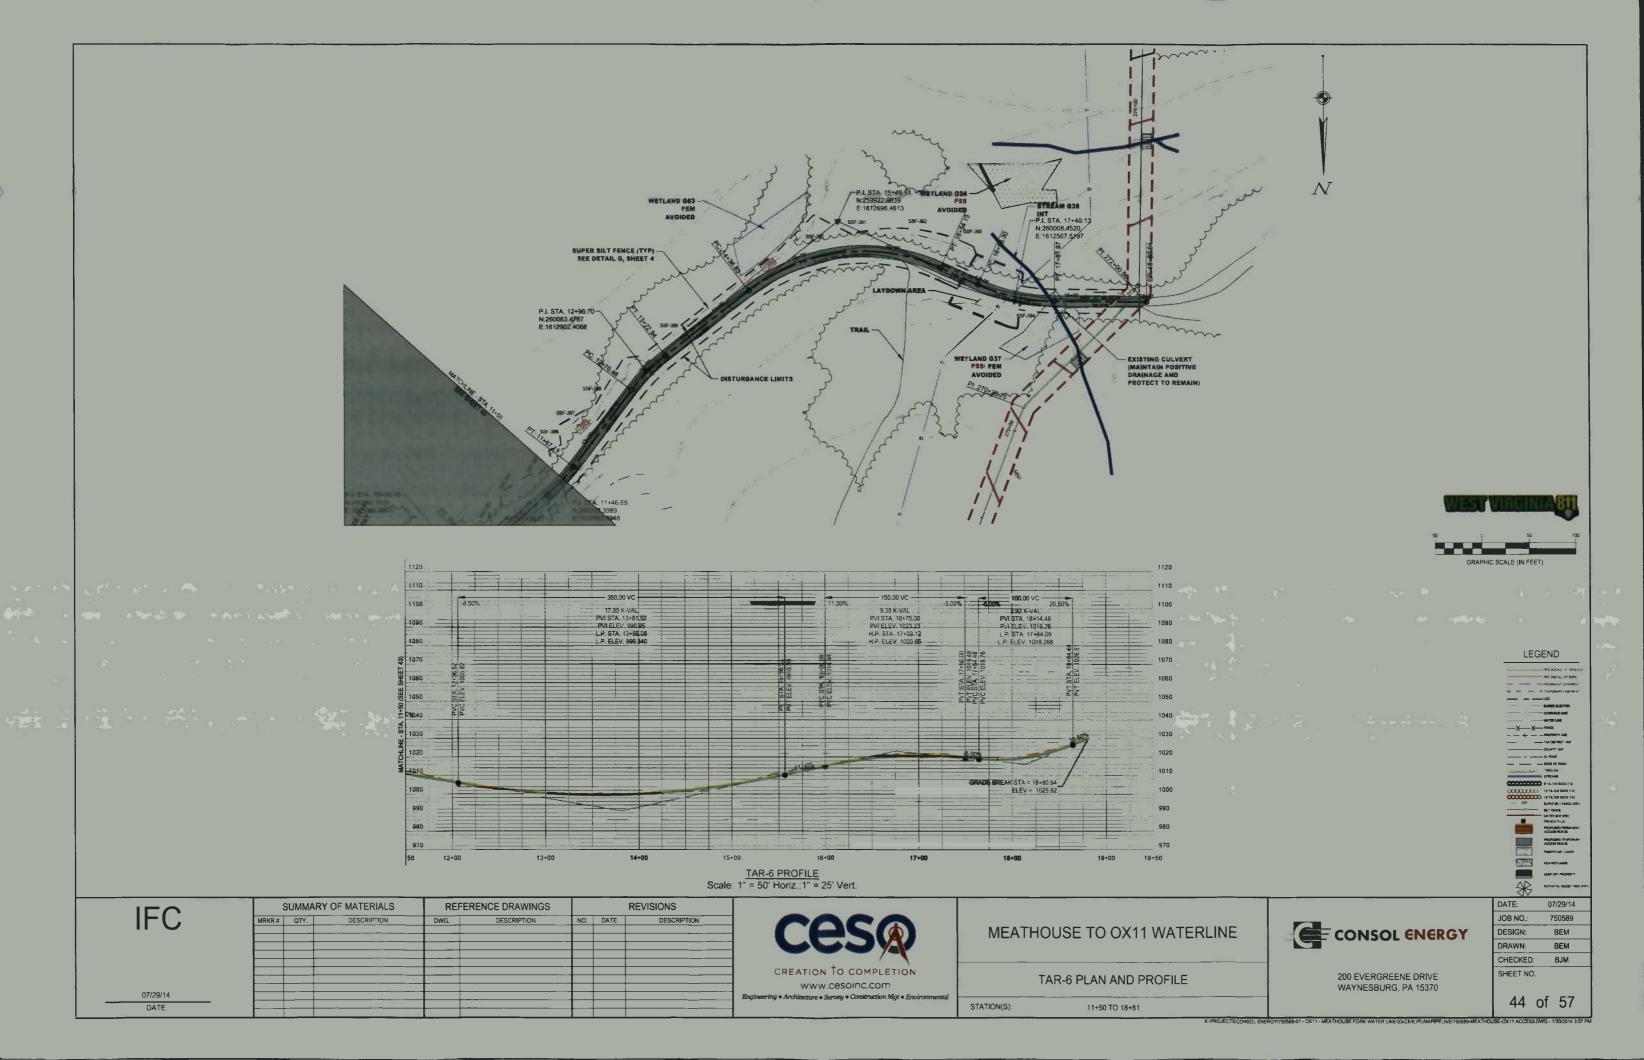
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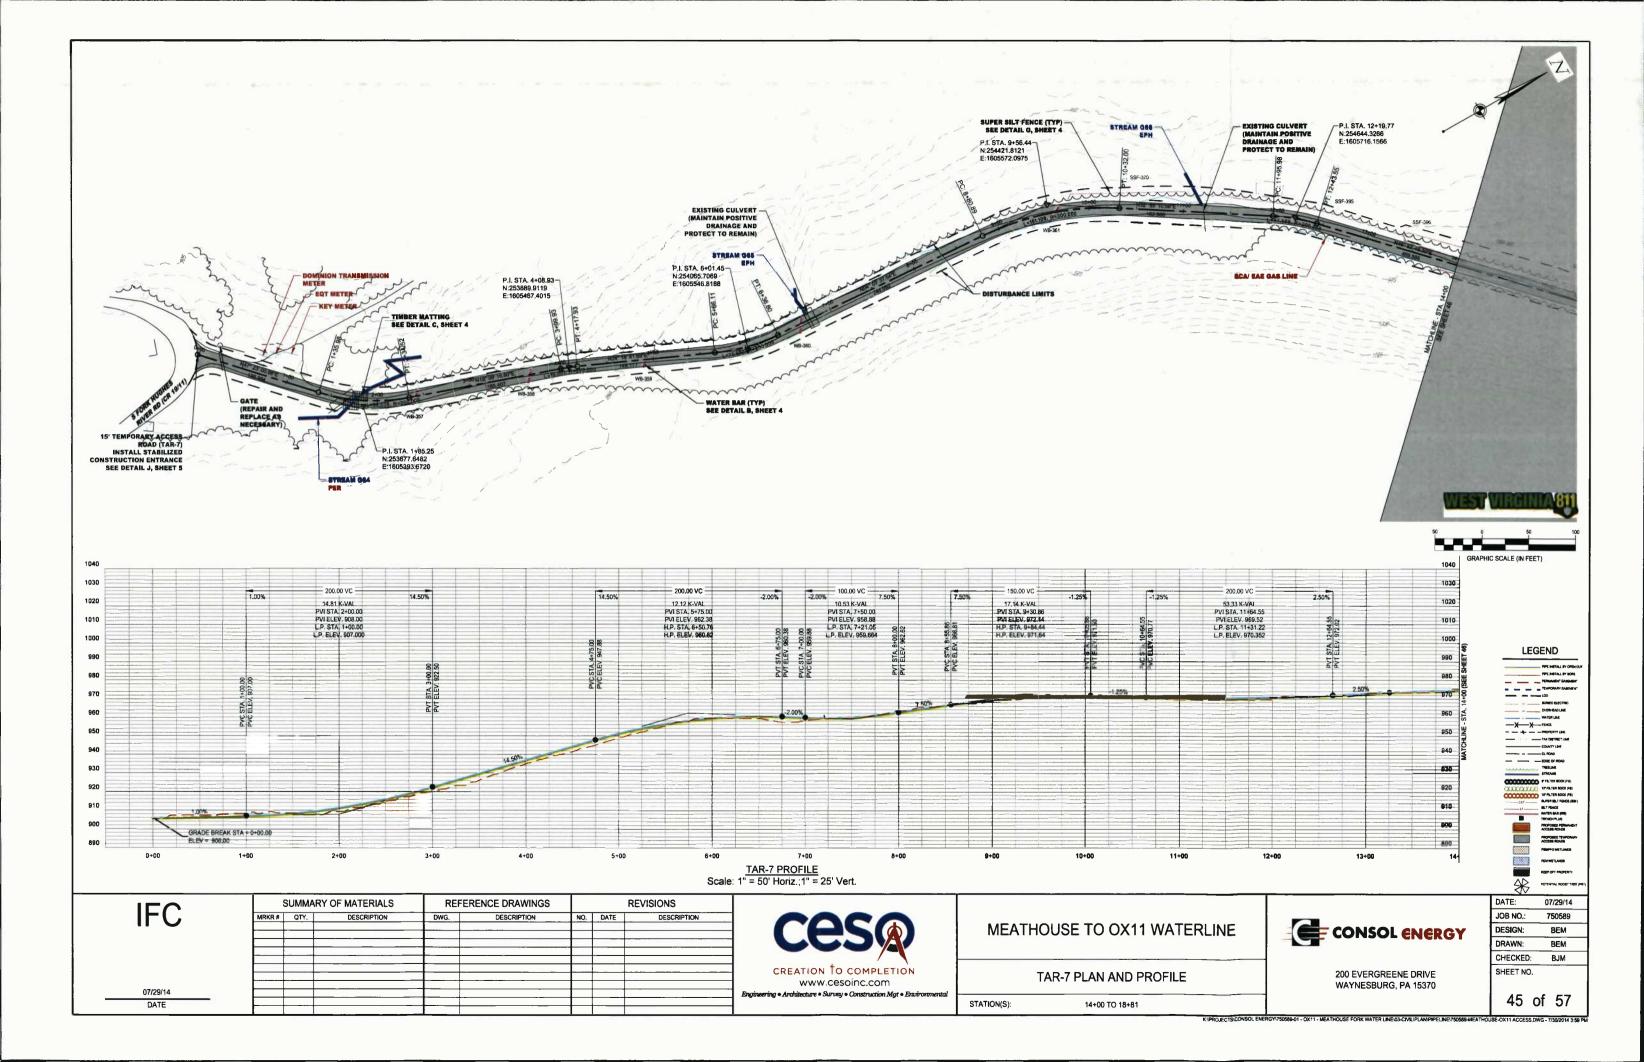
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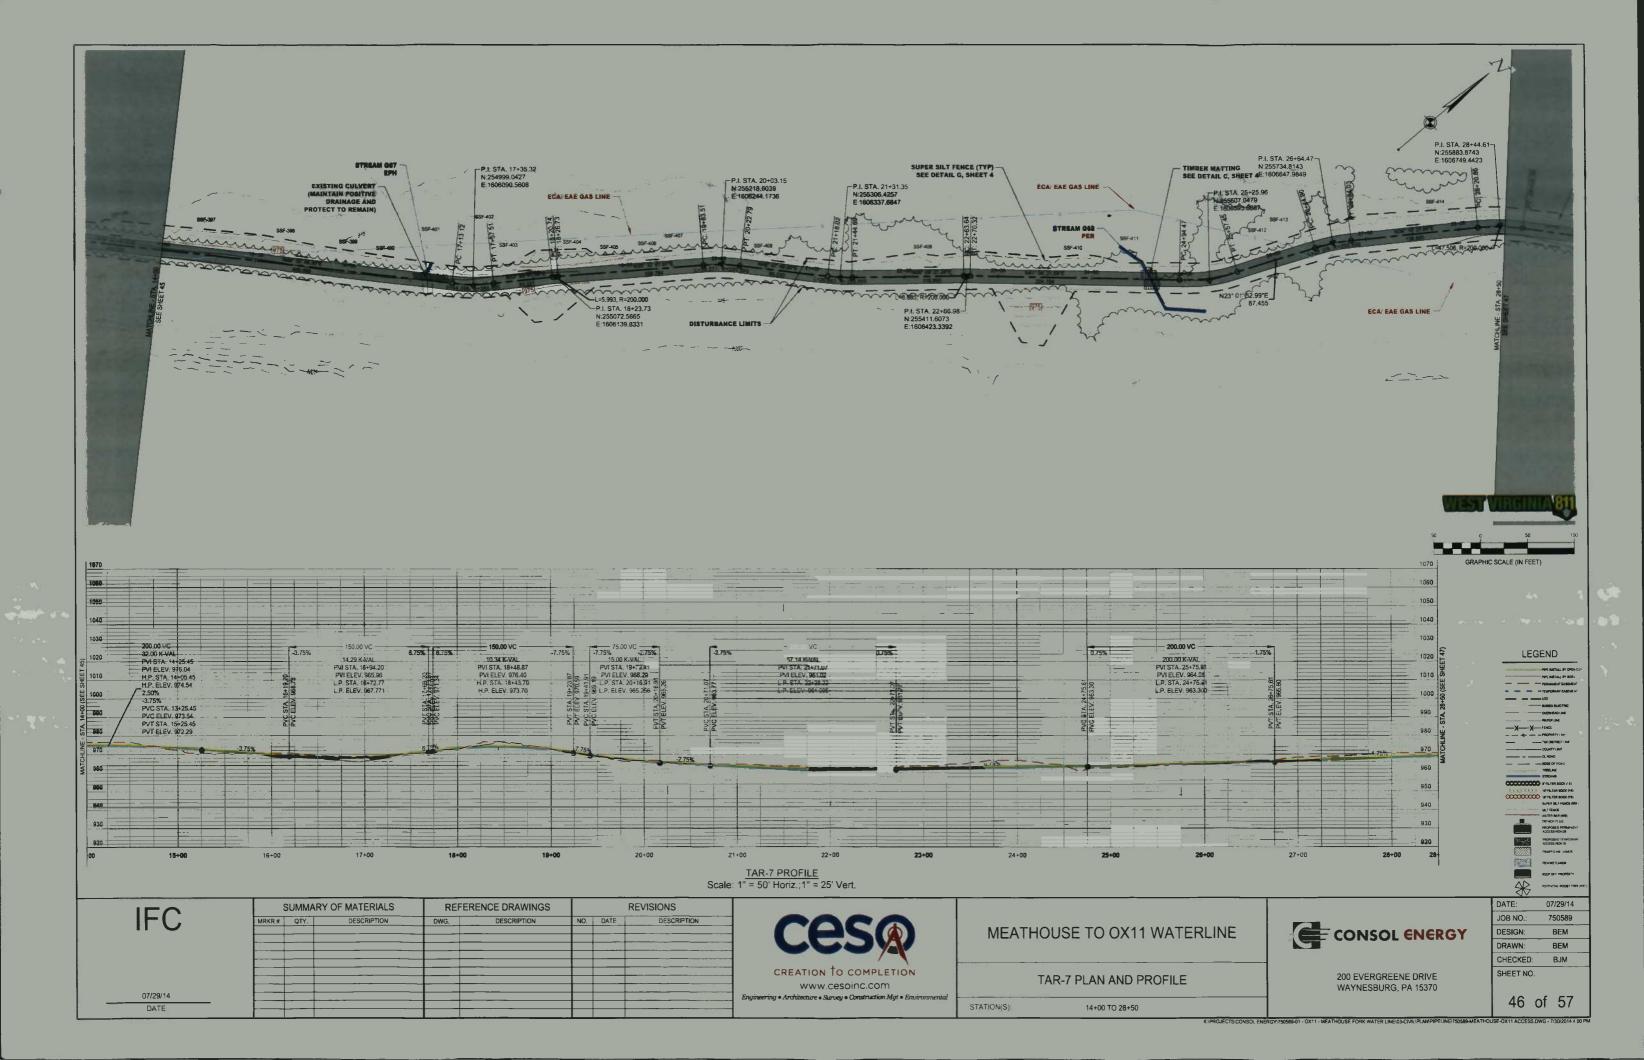
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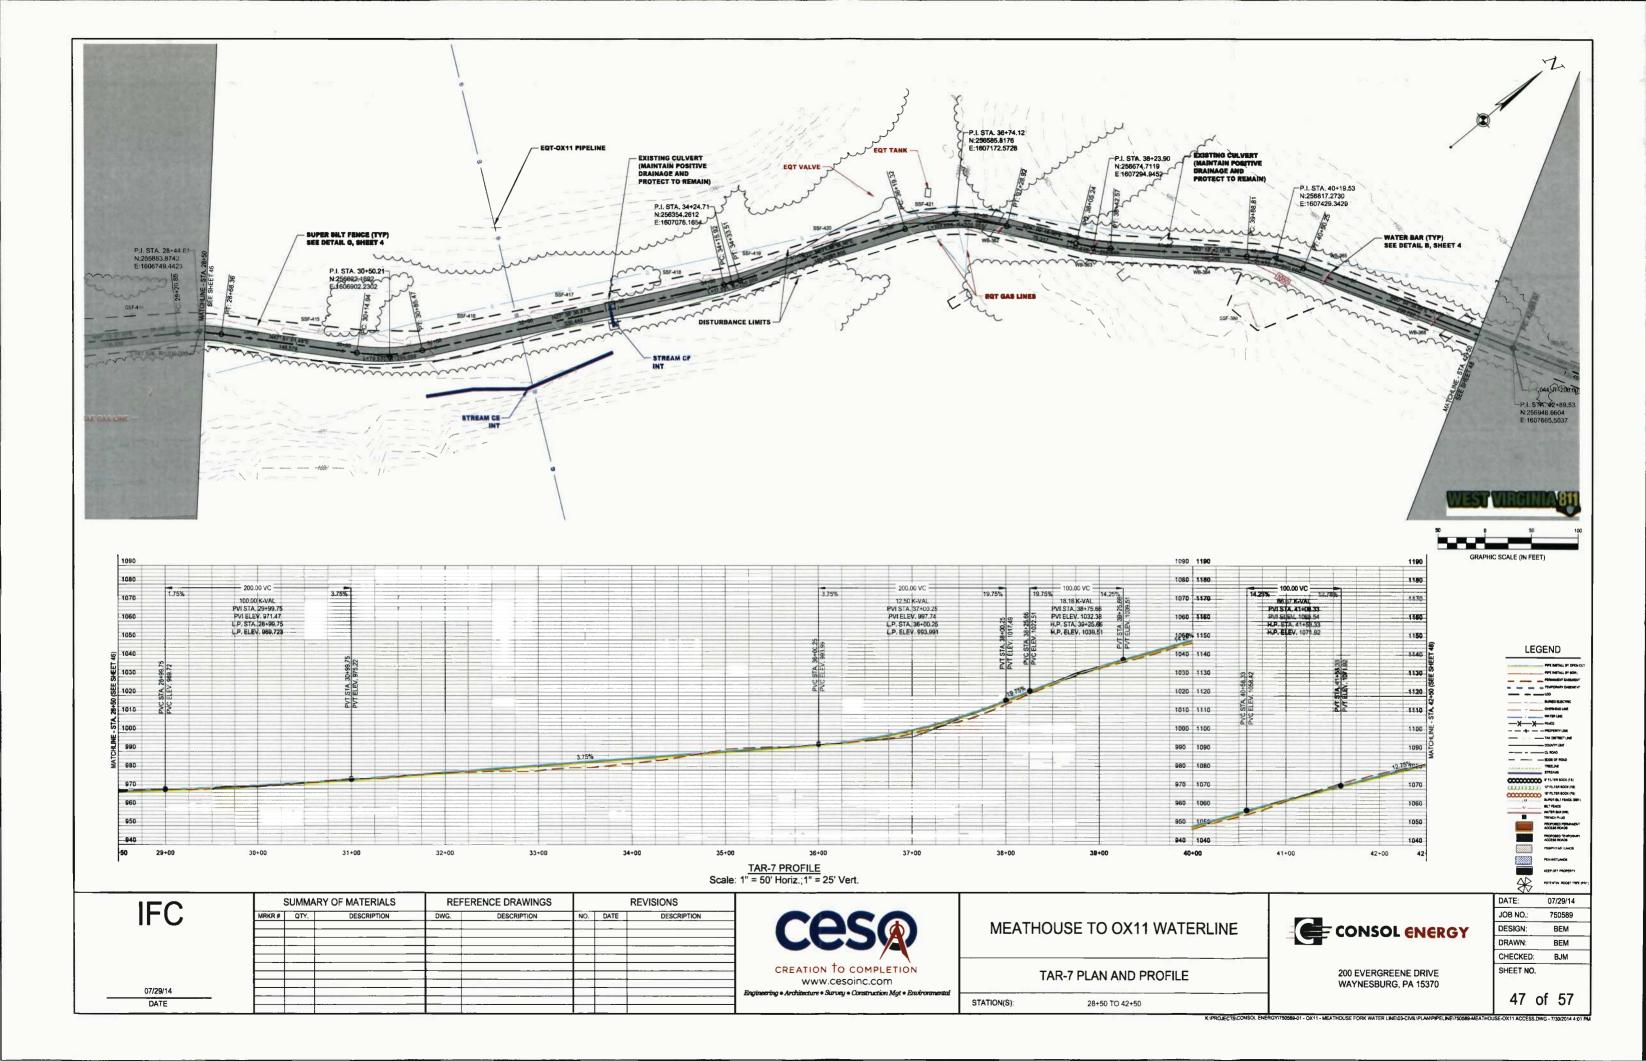










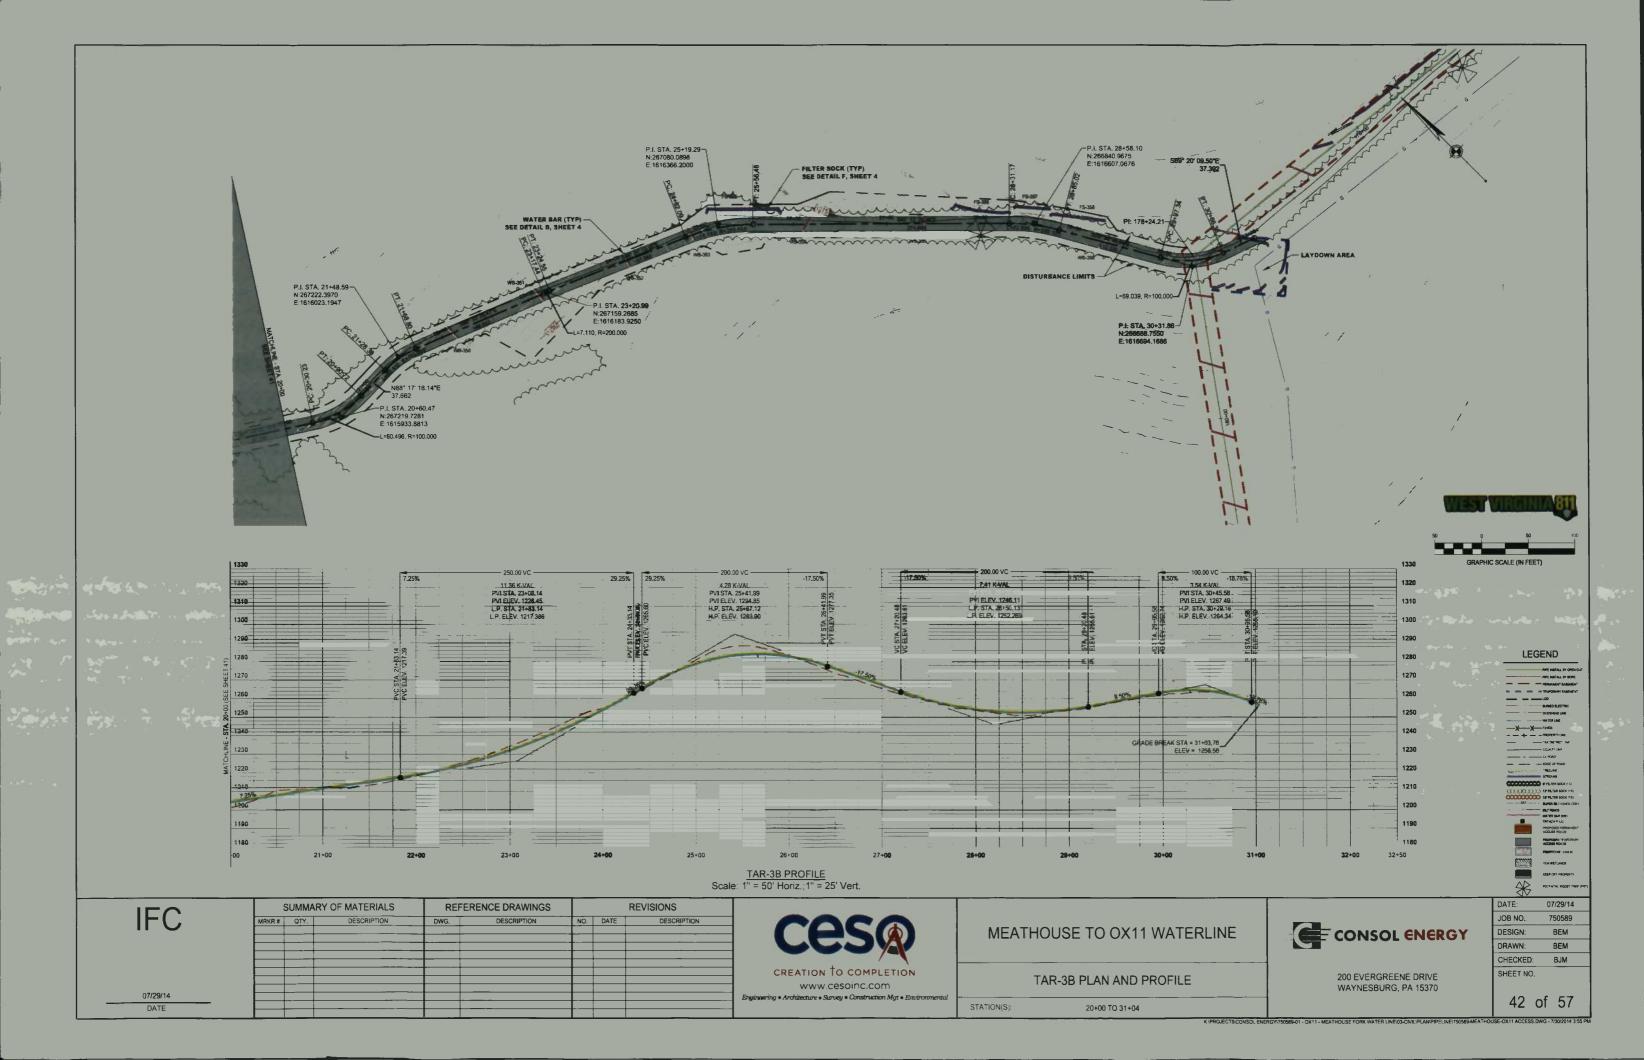

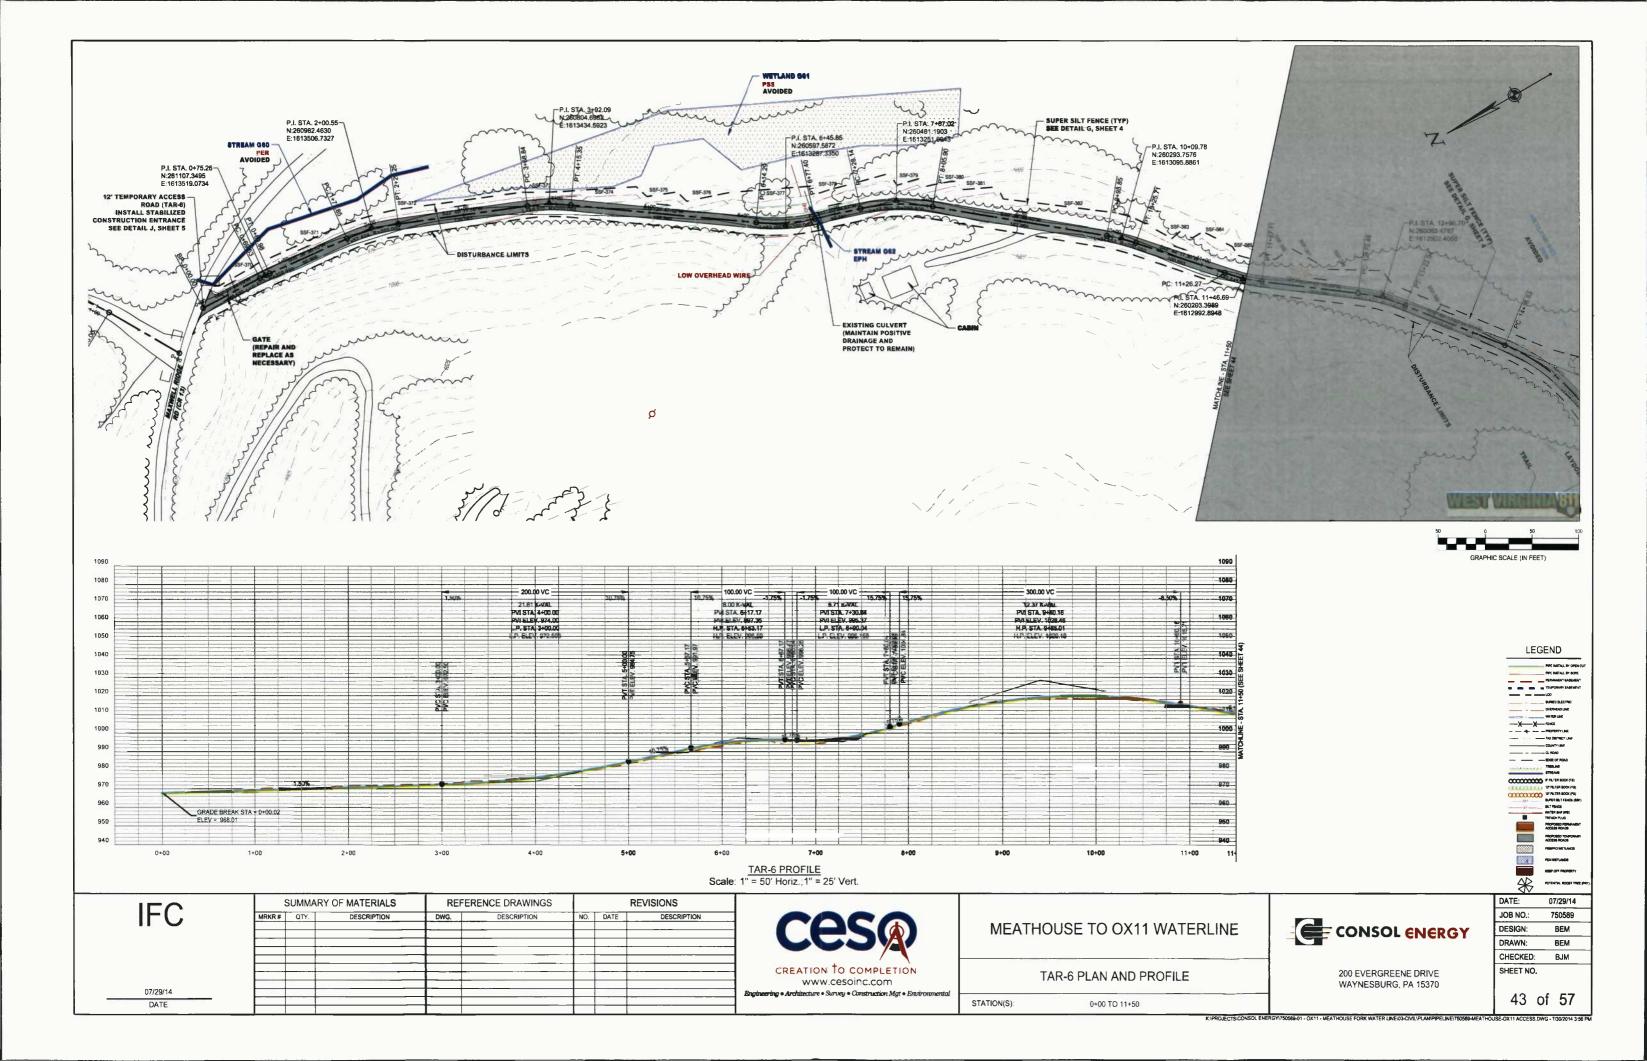

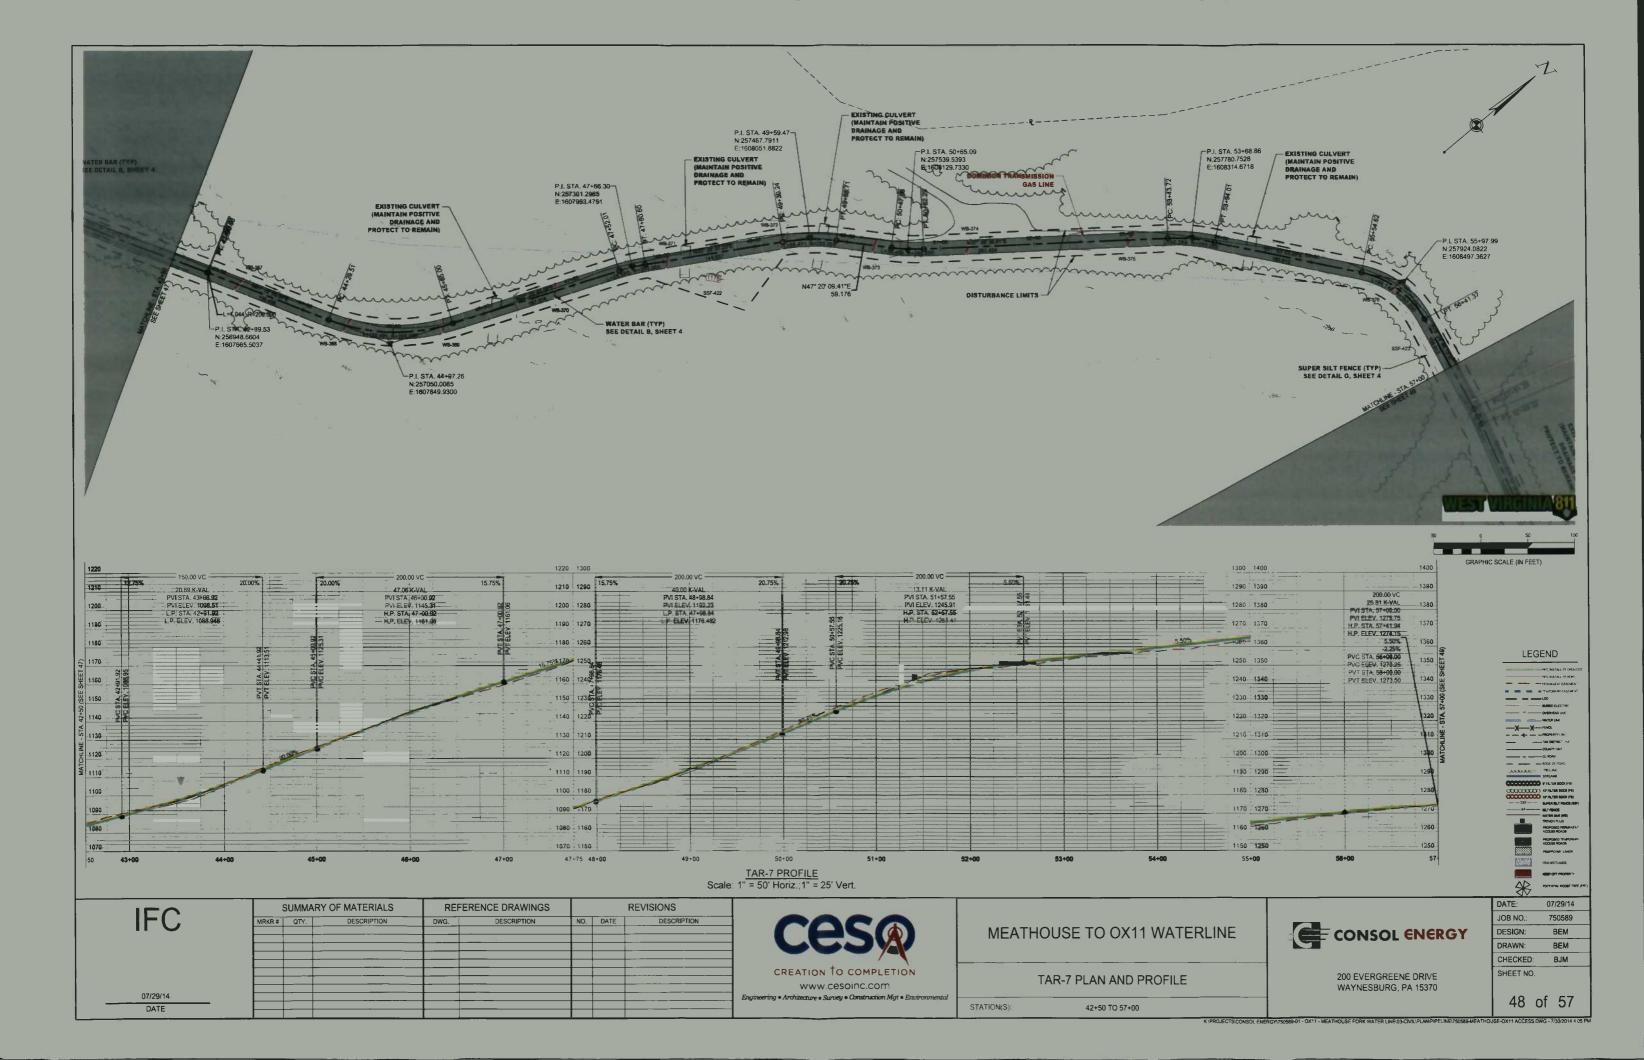

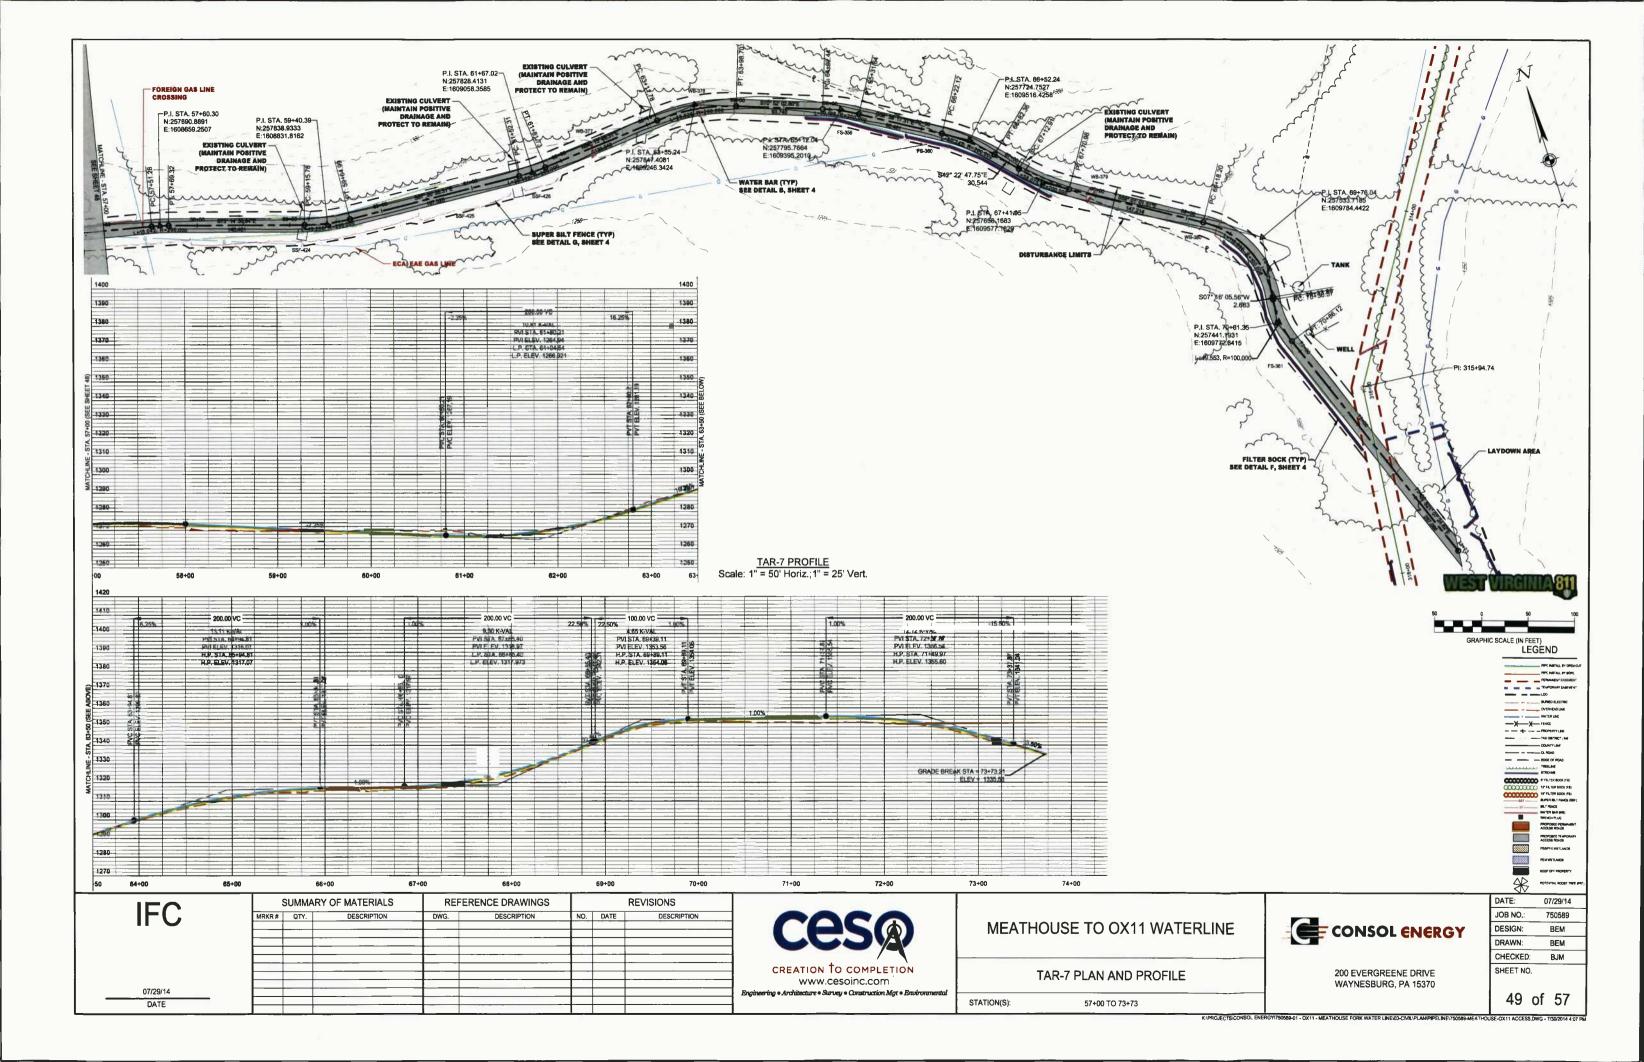

	MEATHOUSE-OX11 WATERLINE FILTER SOCK SIZING CHART*									
	SOCK#	SIZE (in.)	SLOPE (%)	ACTUAL SLOPE LENGTH (ft.)	MAX SLOPE LENGTH (fl.)	SOCK LENGTH (fl.)	APPROXIMATE LOCATION			
	FS-1	8	25	24	80	26	14+50			
	FS-2	8	34	23	60	49	14+50			
	FS-3	8	32	24	60	32	14+50			
	FS-4	8	38	26	69	36	14+50			
	FS-5	8	39	27	70	43	14+70			
	FS-6	8	40	28	70	15	14+70			
	FS-7	8	40	29	70	15	15+25			
	FS-8	8	0	19	600	19	15+25			
	FS-9	8	25	33	80	49	16+00			
	FS-10	8	39	43	60	59	16+50			
	FS-11	12	37	67	75	72	17+00			
	FS-12	12	20	123	125	14	38+50			
	FS-13	8	25	58	80	22	40+25			
	FS-14	18	29	80	90	16	40+50			
	FS-15	8	53	19	40	31	53+00			
	FS-16	В	22	71	80	52	58+00			
	FS-17	В	16	61	100	37	58+50			
	FS-18	8	6	30	200	54	59+25			
	FS-19	8	3	18	400	77	60+00			
	F\$-20	8	4	19	400	45	60+50			
	FS-21	8	14	23	140	56	62+00			
	FS-22	8	21	28	80	14	62+50			
	FS-23	12	31	69	75	14	66+30			
	FS-24	12	18	125	125	24	67+50			
	FS-25	12	17	115	125	20	67+75			
	FS-26	8	16	104	100	22	68+00			
	FS-27	8	14	π	140	30	68+25			
	FS-28	8	11	60	140	89	69+00			
	FS-29	8	12	46	140	43	69+50			
	FS-30	8	2	32	600	14	69+80			
	FS-31	8	6	29	200	135	71+00			
	FS-32	8	14	22	140	14	71+70			
	FS-33	8	15	23	140	63	72+00			
w	ATER BAR SPACING IS E	BASED ON TH	E WEST VIRGI	NIA EROSION AND SEDIMEN	NT CONTROL FIELD MANUAL	TABLE II-8: SPACING OF F	RIGHT OF WAY DIVERSIONS, SO			

MEATHOUSE-OX11 WATERLINE FILTER SOCK SIZING CHART*									
SOCK#	SIZE (in.)	SLOPE (%)	ACTUAL SLOPE LENGTH (ft.)	MAX SLOPE LENGTH (ft.)	SOCK LENGTH (ft.)	APPROXIMATE LOCATIO			
F\$-34	8	23	43	80	14	72+50			
F\$-35	8	22	46	80	13	72+75			
FS-36	8	20	62	100	23	73+25			
FS-37	8	22	68	80	22	73+40			
FS-38	8	23	71	80	20	73+75			
FS-39	8	28	60	60	26	74+00			
FS-40	12	32	62	75	28	74+25			
FS-41	12	33	62	75	27	74+50			
FS-42	8	35	59	60	34	74+75			
FS-43	8	24	41	80	163	78+00			
FS-44	8	19	50	100	12	79+20			
F\$-45	a	19	52	100	10	79+40			
FS-46	8	18	56	100	12	79+60			
FS-47	В	18	61	100	16	79+80			
FS-48	8	16	73	100	20	80+00			
FS-49	12	28	71	75	21	105+60			
FS-50	12	· 32	69	75	21	106+00			
FS-51	12	34	68	75	17	106+15			
FS-52	12	36	69	75	24	106+30			
F\$-53	12	39	69	75	35	106+60			
FS-54	12	40	68	75	42	107+00			
FS-55	12	41	67	50	37	107+50			
FS-56	18	43	65	60	34	107+75			
FS-57	18	44	60	60	25	108+00			
FS-58	18	42	81	60	34	108+70			
FS-59	18	42	58	60	34	109+25			
FS-60	8	3	387	400	33	109+25			
FS-61	8	3	388	400	80	112+75			
FS-62	8	3	389	400	22	112+75			
FS-63	8	3	390	400	24	112+75			
FS-64	8	12	47	140	13	113+00			
FS-65	8	14	72	140	24	113+20			
FS-66	8	15	82	140	14	113+50			

	MEATHOUSE-OX11 WATERLINE FILTER SOCK SIZING CHART*									
Ī	SOCK#	SIZE (in.)	SLOPE (%)	ACTUAL SLOPE LENGTH (ft.)	MAX SLOPE LENGTH (ft.)	SOCK LENGTH (fl.)	APPROXIMATE LOCATION			
Ī	FS-67	8	19	78	100	12	113+60			
	FS-68	8	21	82	80	14	113+80			
	FS-69	12	22	95	100	13	114+00			
ĺ	FS-70	12	22	100	100	12	114+10			
	FS-71	12	20	117	125	14	114+30			
	F\$-72	12	20	124	125	13	114+50			
	FS-73	18	. 21	130	110	10	114+60			
	FS-74	12	30	72	75	18	120+50			
	F\$-75	8	36	53	60	33	120+75			
	FS-76	12	42	47	50	16	121+00			
	FS-77	18	43	56	60	16	121+20			
	FS-78	8	5	259	400	39	132+00			
i	F\$-79	8	5	260	400	25	133+75			
	FS-80	8	5	261	400	17	133+75			
	FS-81	8	5	262	400	15	133+75			
	FS-82	В	5	263	400	31	133+75			
	FS-83	8	5	264	400	103	145+00			
	FS-84	18	9	300	300	44	146+00			
	FS-85	8	1	57	600	73	147+00			
	FS-86	В	3	76	400	90	148+00			
	FS-87	В	4	π	400	41	162+00			
	FS-88	8	19	100	100	27	171+50			
	FS-89	8	20	76	100	20	171+75			
	FS-90	8	20	67	100	20	172+00			
	FS-91	В	31	38	60	91	172+50			
	FS-92	В	25	38	80	18	173+00			
	FS-93	8	21	38	80	16	173+25			
	FS-94	8	18	35	100	17	173+50			
	FS-95	8	10	30	200	21	173+70			
	FS-96	8	9	19	200	17	173+90			
	FS-97	В	12	9	140	37	174+00			
	FS-98	В	9	15	200	163	175+00			
	FS-99	8	30	19	60	27	176+00			
	FS-100	8	31	14	60	23	176+50			
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FILTER SOCK DESIGN BASED ON THE TABLE FOUND IN THE FILTREXX LOW IMPACT DESIGN MANUAL, VERSION 8, SECTION 1; EROSION & SEDIMENT CONTROL, PAGE 324.

150	SUMMA	SUMMARY OF MATERIALS		REFERENCE DRAWINGS		REVISIONS		
IFC	MRKR# QTY.	DESCRIPTION	DWG.	DESCRIPTION	NO.	DATE	DESCRIPTION	
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					#			
07/29/14			 -		+-	 -		
DATE					=			



MEATHOUSE TO OX11 WATERLINE

EROSION AND SEDIMENT CONTROL TABLES



200 EVERGREENE DRIVE WAYNESBURG, PA 15370

DATE:	07/29/14
JOB NO.:	750589
DESIGN:	BEM
DRAWN:	BEM
CHECKED:	ВЈМ
SHEET NO.	

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MEATHOUSE-OX11 WATERLINE FILTER SOCK SIZING CHART*								
SOCK#	SIZE (in.)	SLOPE (%)	ACTUAL SLOPE LENGTH (ft.)	MAX SLOPE LENGTH (fl.)	SOCK LENGTH (ft.)	APPROXIMATE LOCATION		
FS-101	8	14	45	140	37	177+50		
FS-102	в	24	32	80	37	177+50		
FS-103	8	24	43	40	9	177+75		
FS-104	8	26	53	60	13	177+75		
FS-105	В	26	39	60	17	178+00		
FS-106	8	28	31	60	14	178+00		
FS-106A	8	17	32	100	12	178+50		
FS-107	В	10	29	200	14	178+50		
FS-108	8	10	30	201	58	188+50		
FS-109	8	10	31	202	32	194+20		
FS-110	8	10	32	203	8	194+20		
FS-111	8	10	33	204	16	194+20		
FS-112	8	10	34	205	15	194+20		
FS-113	8	10	35	206	16	194+20		
FS-114	8	10	36	207	24	194+40		
FS-115	8	10	37	208	31	194+75		
FS-116	8	10	38	209	26	194+75		
FS-117	8	10	39	210	52	194+75		
FS-118	8	10	40	211	35	201+75		
FS-119	8	10	41	212	88	202+00		
FS-120	12	29	62	75	20	219+30		
FS-121	12	27	62	75	34	219+50		
FS-122	8	25	59	80	26	220+00		
FS-122A	8	23	58	80	45	220+50		
FS-123	8	21	64	80	41	220+75		
FS-123A	8	21	52	80	119	221+00		
FS-124	8	17	48	100	34	222+00		
FS-125	8	18	44	100	28	222+50		
FS-126	В	15	40	140	45	223+00		
FS-127	В	14	33	140	22	223+25		
FS-128	8	14	34	140	44	223+50		
FS-129	8	19	32	100	19	223+75		
FS-130	8	24	42	80	20	224+00		

	MEATI	HOUSE-0	OX11 WATERLII	NE FILTER SOC	K SIZING CHAR	T*
SOCK#	SIZE (in.)	SLOPE (%)	ACTUAL SLOPE LENGTH (ft.)	MAX SLOPE LENGTH (fl.)	SOCK LENGTH (ft.)	APPROXIMATE LOCATION
FS-131	8	30	51	60	16	224+25
FS-132	12	34	61	60	14	224+40
FS-133	12	38	63	60	34	224+60
FS-134	В	35	57	60	15	224+80
FS-135	8	30	54	60	25	225+00
FS-136	8	26	53	60	45	225+50
FS-137	8	20	49	100	111	226+00
FS-138	8	24	49	80	28	227+00
FS-139	8	28	48	60	26	227+20
FS-140	8	31	46	60	44	227+50
FS-141	8	34	47	60	41	228+00
FS-142	8	30	53	60	33	228+25
FS-143	8	32	65	60	55	228+75
FS-144	18	30	77	90	18	229+00
FS-145	18	29	90	90	13	229+25
FS-146	18	31	90	80	21	229+50
FS-147	18	31	90	80	23	229+70
FS-148	18	31	90	80	20	230+00
FS-149	18	31	89	80	14	230+25
FS-150	18	24	104	110	18	231+25
FS-151	12	24	88	100	16	231+50
FS-152	8	23	74	80	36	232+00
FS-153	8	22	68	80	46	232+50
FS-154	8	22	67	80	15	232+70
FS-155	8	27	67	60	14	232+90
FS-156	В	28	59	60	21	233+00
FS-157	В	26	60	60	15	233+25
FS-158	8	25	55	80	15	233+50
FS-159	8	22	31	80	59	234+00
FS-160	8	6	11	200	29	234+50
FS-161	В	13	108	140	88	241+00
FS-162	12	21	118	100	47	242+50
FS-163	8	21	41	80	77	243+50
R BARS HAVE BEEN OVE	R-DESIGNED	AT THE DISCRI	ETION OF THE ENGINEER E	ASED ON EXISTING FIELD (CONDITIONS.	-

	MEATI	HOUSE-0	OX11 WATERLIN	NE FILTER SOC	K SIZING CHAR	Т*
SOCK#	SIZE (in.)	SLOPE (%)	ACTUAL SLOPE LENGTH (ft.)	MAX SLOPE LENGTH (fl.)	SOCK LENGTH (R.)	APPROXIMATE LOCATION
FS-164	8	28	30	60	51	249+00
FS-165	8	16	16	100	31	249+50
FS-166	18	29	81	90	55	258+00
FS-167	18	30	78	90	43	260+75
FS-168	18	32	77	80	17	261+00
FS-169	18	36	79	80	23	261+30
FS-170	18	35	79	80	22	261+60
FS-171	18	37	77	80	22	261+80
FS-172	18	36	81	80	23	262+00
FS-173	18	30	90	90	24	262+25
FS-174	18	25	104	110	57	262+50
FS-175	18	30	90	90	27	263+00
FS-176	18	30	90	90	41	263+50
FS-177	8	26	41	60	17	263+70
FS-178	8	29	49	60	13	263+85
FS-179	12	29	66	75	13	264+00
FS-180	18	29	84	90	12	264+25
FS-181	18	25	106	110	13	264+50
FS-182	18	21	135	110	19	265+70
FS-183	8	21	100	80	19	265+90
FS-184	8	48	60	40	17	278+00
FS-185	18	46	59	55	13	278+15
FS-186	12	39	63	75	13	278+25
FS-187	В	34	60	60	21	278+50
FS-188	8	31	52	60	16	278+65
FS-189	8	30	49	60	15	278+85
FS-190	8	27	42	60	17	279+00
FS-191	8	22	42	80	16	279+30
FS-192	8	23	43	80	19	279+60
FS-193	8	17	62	100	147	280+00
FS-194	12	25	86	100	34	281+25
F\$-195	В	7	67	200	99	298+00
FS-196	8	8	71	200	22	298+60
FS-197	8	22	39	80	36	300+50

"WATER BAR SPACING IS BASED ON THE WEST VIRGINIA EROSION AND SEDIMENT CONTROL FIELD MANUAL TABLE II-8: SPACING OF RIGHT OF WAY DIVERSIONS. SOME WATER BARS HAVE BEEN OVER-DESIGNED AT THE DISCRETION OF THE ENGINEER BASED ON EXISTING FIELD CONDITIONS

FILTER SOCK DESIGN BASED ON THE TABLE FOUND IN THE FILTREXX LOW IMPACT DESIGN MANUAL, VERSION 8, SECTION 1: EROSION & SEDIMENT CONTROL, PAGE 324.

IEC		SUMMARY OF MATERIALS		REFERENCE DRAWINGS		REVISIONS		
IFC	MRKR#	QTY.	DESCRIPTION	DWG.	DESCRIPTION	NO.	DATE	DESCRIPTION
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07/29/14								
DATE								



MEATHOUSE TO OX11 WATERLINE

EROSION AND SEDIMENT CONTROL TABLES

ENOSION AND SEDIMENT CONTROL TABLES



DRSOL ENERGY

DESIGN:
DRAWN:
CHECKED:
SHEET NO.

DESIGN:
DRAWN:
CHECKED:
SHEET NO.

200 ÉVERGREENE DRIVE WAYNESBURG, PA 15370

51 of 57

07/29/14

750589

ВЕМ

BEM

ВЈМ

DATE:

JOB NO.:

		MEATI	HOUSE-0	OX11 WATERLII	NE FILTER SOC	K SIZING CHAR	Τ*
	SOCK#	SIZE (in.)	SLOPE (%)	ACTUAL SLOPE LENGTH (ft.)	MAX SLOPE LENGTH (ft.)	SOCK LENGTH (fL)	APPROXIMATE LOCATION
	FS-196	8	18	34	100	31	301+00
	FS-199	8	17	30	100	. 39	301+50
	FS-200	В	12	22	140	133	302+00
	FS-201	8	3	18	400	29	303+50
	FS-202	8	19	36	100	π	306+00
	FS-203	8	21	61	80	24	306+25
	FS-204	8	22	73	80	64	306+50
	FS-205	8	19	54	100	29	307+00
	FS-206	8	15	37	140	20	307+40
	FS-207	8	9	30	200	15	307+60
	FS-208	8	1	15	600	45	308+00
	F\$-209	8	11	18	140	45	306+40
	FS-210	8	17	48	100	37	308+70
	F\$-211	8	11	67	140	18	309+00
	FS-212	8	11	64	140	. 19	309+30
	FS-213	8	12	72	140	13	309+50
	FS-214	8	8	161	200	15	316+75
	FS-215	8	9	94	200	30	317+00
	FS-216	8	6	88	200	39	317+25
	FS-217	8	10	85	200	20	317+60
	FS-218	8	9	89	200	80	318+00
	FS-219	8	1	14	600	119	318+00
	FS-220	8	5	21	400	29	319+00
	FS-221	В	7	94	200	121	319+00
	FS-222	8	11	86	140	101	323+00
	FS-223	8	12	53	140	106	328+00
	FS-224	8	17	42	100	46	329+00
	FS-225	8	11	26	140	50	329+50
	FS-226	8	32	29	60	30	330+00
	FS-227	8	13	416	140	28	324+40
	FS-228	8	22	51	80	97	324+40
	FS-229	8	18	62	100	46	324+40
	FS-230	8				17	324+50
N	ATER BAR SPACING IS 6	BASED ON TH	E WEST VIRGI	NIA EROSION AND SEDIMEN	IT CONTROL FIELD MANUA	L TABLE II-8: SPACING OF R	RIGHT OF WAY DIVERSIONS. S

	MEAT	HOUSE-	OX11 WATERLI	NE FILTER SOCI	K SIZING CHAR	T*
SOCK#	SIZE (in.)	SLOPE (%)	ACTUAL SLOPE LENGTH (ft.)	MAX SLOPE LENGTH (R.)	SOCK LENGTH (ft.)	APPROXIMATE LOCATION
FS-231	8	19	89	100	22	324+70
FS-232	8	21	94	80	17	324+90
FS-233	18	25	105	110	21	325+00
FS-234	12	32	75	75	45	329+50
FS-236	8	33	57	60	36	330+00
FS-236	8	37	51	60	18	330+25
FS-237	В	32	51	60	15	330+40
FS-238	8	33	48	60	10	330+60
FS-239	8	21	41	80	26	331+75
FS-240	8	17	42	100	24	332+00
FS-241	8	15	47	140	34	332+40
FS-242	8	16	49	100	41	332+75
FS-243	8	17	51	100	20	333+00
FS-244	8	23	58	80	17	333+25
FS-245	8	24	66 '	80	20	333+50
FS-248	8	27	73	56	14	333+60
FS-247	В	11	30	140	20	337+75
FS-248	8	10	29	200	49	338+00
FS-249	8	5	28	400	61	338+50
FS-250	8	12	61	140	111	340+00
FS-251	8	7	73	200	86	341+00
FS-252	8	7	81	200	18	341+25
FS-253	8	8	75	200	21	341+50
FS-254	8	9	79	200	17	341+75
F\$-255	8	10	82	200	19	342+00
FS-256	8	11	70	140	16	342+25
FS-257	а	8	65	200	26	342+50
FS-258	8	5	41	400	43	343+00
FS-259	12	51	43	50	30	363+60
FS-260	12	42	44	50	30	364+00
FS-261	8	35	43	60	29	364+25
FS-262	8	30	38	60	22	364+50
FS-263	8	31	38	60	23	364+75

	MEATI	HOUSE-	OX11 WATERLIN	NE FILTER SOC	K SIZING CHAR	Τ*
SOCK#	SIZE (in.)	SLOPE (%)	ACTUAL SLOPE LENGTH (fL)	MAX SLOPE LENGTH (ft.)	SOCK LENGTH (fl.)	APPROXIMATE LOCATION
FS-264	В	33	41	60	30	365+00
FS-265	8	36	40	60	74	365+50
FS-266	8	36	42	60	26	366+00
FS-267	8	36	42	60	85	367+00
FS-268	12	43	50	50	90	368+00
FS-269	18	41	61	60	20	371+00
FS-270	8	39	55	60	27	371+50
FS-271	В	37	48	60	19	371+ 6 5
FS-272	8	33	42	60	15	371+80
FS-273	8	28	21	60	12	372+00
FS-274	8	12	34	140	22	372+20
FS-275	12	29	75	75	15	380+90
FS-276	12	29	63	75	22	381+00
F\$-277	12	29	65	75	18	381+40
FS-278	12	29	65	75	20	381+50
FS-279	8	25	63	80	11	381+75
FS-280	8	19	62	100	11	381+90
FS-281	8	16	65	100	10	382+10
FS-282	В	11	40	200	78	404+00
FS-283	8	19	73	100	19	405+75
FS-284	8	19	80	100	24	406+00
FS-285	8	19	80	100	40	406+25
FS-286	8	20	92	100	72	407+00
FS-287	18	23	110	110	100	408+00
FS-288	18	20	140	140	18	408+80
FS-289	18	19	138	140	13	409+10
FS-290	8	4	30	400	68	429+00

FILTER SOCK DESIGN BASED ON THE TABLE FOUND IN THE FILTREXX LOW IMPACT DESIGN MANUAL, VERSION 8, SECTION 1: EROSION & SEDIMENT CONTROL, PAGE 324.

	s	SUMMARY OF MATERIALS			REFERENCE DRAWINGS		REVISIONS		
IFC	MRKR #	QTY.	DESCRIPTION	DWG.	DESCRIPTION	NO.	DATE	DESCRIPTION	
						\blacksquare			
				+		+			
						_			
07/29/14			-			-			
DATE									



MEATHOUSE TO OX11 WATERLINE

EROSION AND SEDIMENT CONTROL TABLES



JOB NO.: DESIGN:

DRAWN: CHECKED: BJM SHEET NO. 200 EVERGREENE DRIVE WAYNESBURG, PA 15370

52 of 57

07/29/14

BEM

BEM

DATE:

SOCK#	SIZE (in.)	SLOPE (%)	ACTUAL SLOPE LENGTH	MAX SLOPE LENGTH (ft.)	SOCK LENGTH (fl.)	APPROXIMATE LOCATION
FS-291	8	3	(ft.) 20	400	216	16+00
FS-292	8	2	21	401	315	16+50
	 	3	22	402	88	17+25
FS-293	8					
FS-294	8	3	23	403	271	18+50
FS-295	8	3	24	404	180	19+00
FS-296	12	27	65	75	70	21+50
FS-297	8	13	54	140	223	27+50
FS-298	8	1	33	600	96	29+00
FS-299	8	6	50	200	77	29+75
FS-300	8	5	48	400	86	30+50
FS-301	В	9	60	200	107	31+50
FS-302	8	4	37	400	180	33+00
FS-303	8	1	41	600	123	34+50
F\$-304	8	1	47	600	165	36+00
FS-305	8	2	33	600	63	37+00
FS-306	8	11	75	140	459	40+00
FS-307	8	12	70	140	108	42+50
FS-308	8	В	75	200	193	44+00
FS-309	8	6	72	200	87	45+50
FS-310	В	9	68	200	196	47+00
FS-311	8	15	55	140	28	56+75
FS-312	12	18	120	125	95	78+25
FS-313	В	15	59	140	82	79+25
FS-314	8	16	95	100	105	80+50
FS-315	18	23	105	110	93	93+50
FS-316	8	15	66	140	58	94+00
FS-317	8	10	40	200	34	94+50
	8	1	25	600	76	95+00
FS-318	+	<u> </u>				
FS-319	18	28	85	90	32	106+00
FS-320	В	22	54	80	29	106+50
FS-321	8	1	16	600	125	107+50
FS-322	8	8	14	200	119	107+50

	TAR-1 WATERLINE FILTER SOCK SIZING CHART*										
SOCK#	SIZE (in.)	SLOPE (%)	ACTUAL SLOPE LENGTH (ft.)	MAX SLOPE LENGTH (ft.)	SOCK LENGTH (ft.)	APPROXIMATE LOCATION					
FS-324	8	20	132	100	33	112+00					
FS-325	18	28	91	90	168	135+00					
FS-326	8	4	77	400	57	136+00					

		TAR-3A V	WATERLINE FIL	TER SOCK SIZII	NG CHART*	
SOCK#	SIZE (in.)	SLOPE (%)	ACTUAL SLOPE LENGTH		SOCK LENGTH (ft.)	APPROXIMATE LOCATION
FS-327	8	9	10	11	267	7+00
FS-328	в				283	7+00
FS-329	8	10	43	200	79	9+00
FS-330	8	8	40	200	60	12+00
FS-331	8	9	34	200	67	13+00
FS-332	8	16	88	100	155	14+00
FS-333	8	10	64	200	70	15+00
FS-334	8	7	61	200	194	16+50
FS-335	8	1	46	600	48	17+75
FS-336	8	5	45	400	57	18+25
FS-337	8	4	48	400	114	19+00
FS-338	8	3	41	400	57	20+00
FS-339	8	6	44	200	23	20+50
FS-340	8	3	42	400	52	21+00
FS-341	8	20	91	100	256	22+50
FS-342	8	14	43	140	128	24+25
FS-343	8	5	33	400	84	25+50
FS-344	8	4	35	400	66	26+25
FS-345	8	11	28	140	73	26+75
FS-346	8	15	26	140	140	28+00
FS-347	8	3	30	400	72	29+00
FS-348	8	4	24	400	107	29+75

		TAR-3B	WATERLINE FIL	TER SOCK SIZII	NG CHART*	
SOCK#	SIZE (in.)	SLOPE (%)	ACTUAL SLOPE LENGTH (ft.)	MAX SLOPE LENGTH (ft.)	SOCK LENGTH (fl.)	APPROXIMATE LOCATION
FS-349	18	25	109	110	38	5+25
FS-350	12	25	90	100	30	5+75
FS-351	8	22	70	100	32	6+25
FS-352	В	19	57	100	26	6+50
FS-353	8	11	41	140	129	7+50
FS-354	8	5	29	400	70	10+50
FS-355	В	5	56	400	87	25+50
FS-356	8	5	57	400	66	28+00
FS-357	8	5	58	400	41	28+50
FS-358	8	5	59	400	61	29+00

	TAR-7 WATERLINE FILTER SOCK SIZING CHART*										
SOCK#	SIZE (in.)	SLOPE (%)	ACTUAL SLOPE LENGTH (ft.)	MAX SLOPE LENGTH (ft.)	SOCK LENGTH (fl.)	APPROXIMATE LOCATION					
FS-359	8	29	43	60	109	65+25					
FS-360	8	1	27	600	172	66+50					
FS-361	8	5	104	400	275	71+00					

TWATER BAR SPACING IS BASED ON THE WEST VIRGINIA EROSION AND SEDIMENT CONTROL FIELD MANUAL TABLE II-8: SPACING OF RIGHT OF WAY DIVERSIONS. SOME WATER BARS HAVE BEEN OVER-DESIGNED AT THE DISCRETION OF THE ENGINEER BASED ON EXISTING FIELD CONDITIONS.

FILTER SOCK DESIGN BASED ON THE TABLE FOUND IN THE FILTREXX LOW IMPACT DESIGN MANUAL, VERSION 8, SECTION 1; EROSION & SEDIMENT CONTROL, PAGE

		SUMMARY OF MATERIALS		REFERENCE DRAWINGS		REVISIONS		
IFC	MRKR#	QTY.	DESCRIPTION	DWG.	DESCRIPTION	NO.	DATE	DESCRIPTION
07/29/14 DATE								



MEATHOUSE TO OX11 WATERLINE

EROSION AND SEDIMENT CONTROL TABLES

STATION(S):



200 EVERGREENE DRIVE WAYNESBURG, PA 15370

DATE:	07/29/14
JOB NO.:	750589
DESIGN:	BEM
DRAWN:	BEM
CHECKED:	ВЈМ
SHEET NO.	
53 (sf 57

MEATH		ATERLINE WAT CING*	TER BAR	MEATH	IOUSE-OX11 W SPA	ATERLINE WA	TER BAR
STATION BEGIN	STATION END	% SLOPE (AVERAGE)	WATER BAR SPACING (FT)	STATION BEGIN	STATION END	% SLOPE (AVERAGE)	WATER BAR SPACING (FT)
4+61	4+76	18	100	80+12	80+32	15	125
5+63	5+72	18	100	81+48	81 +6 0	15	125
6+67	8+68	18	100	82+74	82+80	15	125
7+64	7+89	28	75	83+99	84+16	20	100
8+39	8+42	28	75	85+03	85+14	20	100
9+12	9+1 4	29	75	86+06	86+18	11	125
9+85	9+89	29	75	87+49	87+74	11	125
10+55	10+63	29	75	88+82	89+04	15	125
11+33	11+36	50	75	89+53	89+86	15	125
12+07	12+10	50	75	90+39	90+45	31	75
12+83	12+84	40	75	91+16	91+20	42	75
13+49	13+61	40	75	91+92	91+94	42	75
14+24	14+32	40	75	92+67	92+77	42	75
15+44	15+48	7	75	93+45	93+50	54	75
19+28	19+64	33	75	94+98	95+29	15	125
22+69	22+87	25	75	95+85	95+97	45	75
28+04	28+57	10	175	96+59	96+65	45	75
39+21	39+35	16	100	97+31	97+39	45	75
40+51	40+80	13	175	96+02	98+14	38	75
53+08	53+35	17	100	98+73	98+90	38	75
53+72	53+95	17	100	99+38	99+64	26	75
54+75	54+92	17	100	100+07	100+39	26	75
55+51	55+62	30	75	100+91	101+07	24	75
56+21	56+34	30	75	101+54	101+84	24	75
60+90	61+07	18	100	102+15	102+55	27	75
62+82	62+87	26	75	102+94	103+29	27	75
63+82	62+87	26	75	103+70	103+98	27	75
64+55	64+65	26	75	104+41	104+69	31	75
65+30	65+42	26	75	105+16	105+38	31	75
65+75	65+82	26	75	109+47	109+54	32	75
75+06	75+39	25	75	110+22	110+28	32	75
75+83	76+28	25	75	110+94	110+95	32	75
76+68	77+06	25	75	111+67	111+75	38	75
		VIRGINIA EROSION AND SI OUND IN THE FILTREXX LO					ER BARS HAVE BEEN OVER
		-				Т	DEL
SUMMARY OF MATERIALS REFERENCE DRAWINGS REVISION DWG DESCRIPTION NO DATE OF THE PROPERTY OF TH							

MEATHOUSE-OX11 WATERLINE WATER BAR SPACING*							
STATION BEGIN	STATION END	% SLOPE (AVERAGE)	WATER BAR SPACING (FT)				
112+27	112+34	38	75				
115+68	116+79	34	75				
117+45	117+51	34	75				
118+07	118+14	16	100				
118+45	118+60	16	100				
119+48	119+54	20	100				
121+44	121+73	25	75				
123+80	124+06	19	100				
124+44	124+62	19	100				
124+91	124+94	33	75				
125+56	125+74	33	75				
130+13	130+29	26	75				
130+90	131+05	26	75				
132+25	132+46	20	100				
133+06	133+16	19	100				
133+77	133+94	19	100				
134+83	134+92	19	100				
135+83	136+05	19	100				
136+89	137+04	25	75				
137+66	137+81	25	75				
138+44	138+54	25	75				
139+16	139+36	40	75				
139+76	139+82	37	75				
140+49	140+58	37	75				
141+23	141+33	37	75				
141+99	142+10	37	75				
142+73	142+81	30	75				
143+48	143+57	30	75				
144+23	144+30	30	75				
144+73	144+86	30	75				
148+73	148+91	27	75				
149+52	149+67	27	75				
150+22	150+40	27	75				

SPACING* WATER BAR SPACING							
STATION BEGIN	STATION END	% SLOPE (AVERAGE)	WATER BAR SPACE				
157+62	157+74	26	75				
158+38	158+44	26	75				
159+12	159+18	38	75				
15 9+8 5	159+98	38	75				
160+61	160+71	38	75				
161+32	161+36	38	. 75				
162+14	162+36	26	75				
162+96	163+02	26	75				
163+67	163+81	26	75				
164+44	164+53	26	75				
165+14	165+30	28	75				
165+84	166+03	26	75				
166+61	188+76	33	75				
167+35	167+49	33	75				
168+04	168+25	40	75				
168+80	168+96	40	75				
169+55	169+72	40	75				
170+34	170+46	40	75				
171+03	171+24	40	75				
176+70	176+84	14	125				
177+71	177+92	14	125				
178+63	178+70	30	75				
179+37	179+48	30	75				
180+13	180+24	38	75				
180+90	181+02	23	75				
181+66	181+79	23	75				
182+40	182+55	35	75				
183+16	183+29	25	75				
183+90	184+09	25	75				
184+72	184+81	25	75				
185+51	185+59	38	75				
186+26	186+28	38	75				
187+01	187+06	38	75				
187+76	187+83	44	75				

MEATHOUSE-OX11 WATERLINE WATER BAR SPACING*						
STATION BEGIN	STATION END	% SLOPE (AVERAGE)	WATER BAR SPACING (FT)			
189+04	189+11	50	75			
189+79	189+84	50	75			
190+53	190+61	50	75			
191+23	191+36	42	75			
191+96	192+08	38	75			
192+74	192+79	38	75			
193+51	193+53	38	75			
194+86	195+05	29	75			
195+69	195+72	29	75			
196+42	196+46	42	75			
197+17	197+25	42	75			
197+93	198+02	42	75			
198+72	198+75	42	75			
199+44	199+57	42	75			
200+24	200+30	25	75			
200+94	201+15	25	75			
203+03	203+05	47	75			
203+72	203+81	47	75			
204+44	204+56	47	75			
207+31	207+40	50	75			
208+05	208+13	50	75			
208+76	208+95	32	75			
209+44	209+76	25	75			
218+17	218+24	42	75			
218+92	218+97	42	75			
234+57	234+69	22	75			
235+18	235+49	22	75			
235+90	236+17	22	75			
241+59	241+75	24	75			
243+80	243+86	24	75			
244+52	244+61	24	75			
245+23	245+36	24	75			
246+00	246+09	27	75			
246+74	246+86	27	75			
			DATE: 07			
			LIOPAIO. 70			

IFO	SUMMARY OF MATERIALS		REFE	1	REVISIONS			
IFC	MRKR#	QTY.	DESCRIPTION	DWG.	DESCRIPTION	NO.	DATE	DESCRIPTION
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MEATHOUSE TO OX11 WATERLINE

EROSION AND SEDIMENT CONTROL TABLES

STATION(S):

CONSOL ENERGY

200 EVERGREENE DRIVE

WAYNESBURG, PA 15370

JOB NO.: DESIGN: DRAWN: BEM CHECKED: ВЈМ SHEET NO.

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MEATH		VATERLINE WA	TER BAR	MEATH		ATERLINE WA	TER BAR	MEATH		ATERLINE WA	TER BAR
STATION BEGIN	STATION END	% SLOPE (AVERAGE)	WATER BAR SPACING (FT)	STATION BEGIN	STATION END	% SLOPE (AVERAGE)	WATER BAR SPACING (FT)	STATION BEGIN	STATION END	% SLOPE (AVERAGE)	WATER BAR SPACE
247+50	247+66	14	125	295+02	295+11	39	75	361+05	361+27	27	75
248+27	248+44	14	125	295+77	295+85	39	75	361+69	362+04	27	75
249+70	249+77	14	125	296+36	296+68	10	175	362+37	362+72	30	75
250+09	250+19	14	125	298+78	299+25	9	175	363+08	363+44	30	75
251+91	251+99	31	75	303+97	304+09	14	125	372+32	372+44	45	75
252+84	252+89	33	75	304+92	305+30	14	125	373+10	373+16	45	7
253+56	253+61	33	75	309+57	309+87	13	125	373+85	373+91	45	75
254+33	254+34	33	75	311+37	311+62	8	175	374+55	374+78	25	75
255+05	255+13	33	75	315+39	315+61	4	300	375+32	375+56	25	75
255+80	255+87	39	75	330+88	331+15	14	125	376+13	376+31	21	75
256+49	256+63	29	75	335+18	335+41	25	75	376+85	377+15	21	75
264+60	264+90	14	125	335+97	336+17	25	75	382+35	382+62	17	100
266+13	266+34	21	75	336+76	337+00	25	75	383+22	383+24	41	75
266+96	267+07	21	75	343+33	343+65	9	175	383+96	383+99	41	75
267+72	267+82	21	75	345+17	345+35	28	75	384+69	384+78	41	75
268+48	268+63	21	75	345+97	346+07	28	75	385+47	385+56	26	75
269+20	269+47	21	75	346+71	346+84	19	100	386+21	386+37	26	75
. 270+01	270+21	21	75	347+76	347+79	19	100	387+02	387+10	26	75
270+84	270+88	21	75	348+48	348+61	24	75	387+76	387+89	26	75
272+71	272+83	25	75	349+23	349+38	24	75	388+54	388+64	26	75
273+80	273+88	37	75	350+02	350+10	24	75	389+33	389+52	22	75
274+51	274+59	37	75	350+76	350+89	24	75	390+48	390+50	37	75
275+26	275+34	37	75	351+54	351+60	25	75	392+68	392+95	31	75
275+96	276+19	29	75	352+26	352+44	25	75	393+52	393+64	31	75
276+70	276+98	29	75	354+77	354+77	50	75	394+26	394+38	31	75
277+47	277+74	29	75	355+32	355+39	50	75	394+88	395+16	31	75
288+09	288+13	44	75	356+02	356+11	34	75	396+04	396+28	28	75
288+80	289+00	44	75	356+76	356+86	34	75	396+78	397+02	28	75
289+72	289+91	24	75	357+48	357+61	34	75	397+50	397+77	28	75
291+89	292+08	24	75	358+20	358+36	38	75	398+21	398+50	37	75
292+74	292+84	40	75	358+93	359+08	38	75	398+96	399+23	37	75
293+59	293+64	39	75	359+64	359+79	38	75	399+66	399+98	37	75
294+27	294+35	39	75	360+35	360+50	27	75	400+57	400+93	20	100
		T VIRGINIA EROSION AND S					ER BARS HAVE BEEN OVER	R-DESIGNED AT THE DISCR	ETION OF THE ENGINEE	R BASED ON EXISTING FIE	LD CONDITIONS.
	<u> </u>		UMMARY OF MATE		REFERENCE I		REVIS	IONS	T		

MEATHOUSE-OX11 WATERLINE WATER BAR SPACING*							
STATION BEGIN	STATION END	% SLOPE (AVERAGE)	WATER BAR SPACING				
361+05	361+27	27	75				
361+69	362+04	27	75				
362+37	362+72	30	75				
363+08	363+44	30	75				
372+32	372+44	45	75				
373+10	373+16	45	7				
373+85	373+91	45	75				
374+55	374+78	25	75				
375+32	375+56	25	75				
376+13	376+31	21	75				
376+85	377+15	21	75				
382+35	382+62	17	100				
383+22	383+24	41	75				
383+96	383+99	41	75				
384+69	384+78	41	75				
385+47	385+56	26	75				
386+21	386+37	26	75				
387+02	387+10	26	75				
387+76	387+89	26	75				
388+54	388+64	26	75				
389+33	389+52	22	75				
390+48	390+50	37	75				
392+68	392+95	31	75				
393+52	393+64	31	75				
394+26	394+38	31	75				
394+88	395+16	31	75				
396+04	396+28	28	75				
396+78	397+02	28	75				
397+50	397+77	28	75				
398+21	398+50	37	75				
398+96	399+23	37	75				
399+66	399+98	37	75				

	MEATH		ATERLINE WAT	ER BAR
	STATION BEGIN	STATION END	% SLOPE (AVERAGE)	WATER BAR SPACING (FT)
	401+53	401+85	20	100
	402+28	402+52	30	75
	403+08	403+19	15	125
	404+49	404+62	15	125
	409+23	409+38	21	75
	410+22	410+39	21	75
	411+00	411+06	30	75
	411+74	411+82	30	75
	412+51	412+52	54	75
	413+24	413+26	54	75
	413+86	413+89	38	75
	414+84	414+89	38	75
	415+60	415+84	38	75
	417+24	417+25	36	75
	417+61	417+65	36	75
	418+29	418+42	36	75
	419+00	419+14	36	75
	419+80	419+87	36	75
	420+48	420+60	33	75
	421+25	421+34	33	75
	421+98	422+01	33	75
	422+63	422+77	30	75
	423+28	423+59	30	75
	424+01	424+29	31	75
	424+76	425+01	31	75
	425+43	425+76	31	75
	426+17	426+56	31	75
	426+89	427+30	31	75
	427+68	427+94	31	75
	429+76	430+02	18	100
	430+86	430+97	18	100
1	431+54	431+88	18	100
1	432+53	432+71	37	75

MEATH	MEATHOUSE-OX11 WATERLINE WATER BAR SPACING*								
STATION BEGIN	STATION BEGIN STATION END % SLOPE (AVERAGE)								
434+06	434+28	37	75						
437+40	437+55	50	75						
438+10	438+35	20	100						
436+83	439+22	20	100						
446+14	446+20	30	75						
446+92	446+96	30	75						
447+64	447+73	30	75						

PAR-1 WATER BAR SPACING*								
STATION BEGIN	STATION END	% SLOPE (AVERAGE)	WATER BAR SPACING (FT)					
5+39	5+41	14	125					

STATION BEGIN	STATION END	% SLOPE (AVERAGE)	WATER BAR SPAC (FT)
0+88	0+95	5	300
3+85	3+93	14	125
5+16	5+19	14	125
8+34	8+40	12	125
9+62	9+66	20	100
10+65	10+69	15	125
11+89	11+94	15	125
13+15	13+21	15	125
20+15	20+24	7	175
59+40	59+45	20	100
60+41	60+46	20	100
61+41	61+48	20	100
62+44	62+50	14	125
63+69	63+76	14	125
109+58	109+66	14	125
110+85	110+91	20	100
123+56	123+65	9	175
125+35	125+40	18	100
126+33	126+39	18	100

		SUMMARY OF MATERIALS REFERE		RENCE DRAWINGS	REVISIONS			
IFC	MRKR#	QTY.	DESCRIPTION	DWG.	DESCRIPTION	NO.	DATE	DESCRIPTIO
•						+		
						+		

07/29/14

CREATION TO COMPLETION www.cesoinc.com

MEATHOUSE TO OX11 WATERLINE

EROSION AND SEDIMENT CONTROL TABLES

STATION(S):



200 EVERGREENE DRIVE WAYNESBURG, PA 15370

DATE:	07/29/14
JOB NO.:	750589
DESIGN:	ВЕМ
DRAWN:	BEM
CHECKED:	ВЈМ
SHEET NO.	
	JOB NO.: DESIGN: DRAWN: CHECKED:

55 of 57

	PAR-1 WATER BAR SPACING*				
STATION BEGIN	STATION END	% SLOPE (AVERAGE)	WATER BAR SPACING (FT)		
5+39	5+41	14	125		

TAR-1 WATER BAR SPACING*				
STATION BEGIN	STATION END	% SLOPE (AVERAGE)	WATER BAR SPACING (FT)	
0+88	0+95	5	300	
3+85	3+93	14	125	
5+16	5+19	14	125	
8+34	8+40	12	125	
9+62	9+66	20	100	
10+65	10+69	15	125	
11+89	11+94	15	125	
13+15	13+21	15	125	
20+15	20+24	7	175	
59+40	59+45	20	100	
60+41	60+46	20	100	
61+41	61+48	20	100	
82+44	62+50	14	125	
63+69	63+76	14	125	
109+58	109+66	14	125	
110+85	110+91	20	100	
123+58	123+65	9	175	
125+35	125+40	18	100	
126+33	126+39	18	100	
127+36	127+40	15	125	
128+60	128+65	15	125	
129+60	129+65	25	75	
130+35	130+39	25	75	
131+10	131+14	15	125	
132+35	132+40	10	175	
133+99	134+08	10	175	
136+58	136+65	19	100	
137+59	137+64	19	100	
-	T	T	T	

STATION BEGIN	STATION END	% SLOPE (AVERAGE)	WATER BAR SPACING (FT)		
1+67	1+74	14	125		
2+94	2+99	14	125		
4+22	4+27	13	125		
5+45	5+52	13	125		
31+48	31+54	20	100		
32+49	32+53	20	100		
33+48	33+51	20	100		
35+24	35+30	10	175		

STATION BEGIN	STATION END	% SLOPE (AVERAGE)	WATER BAR SPACI
8+54	8+63	5	300
11+29	11+35	19	100
12+32	12+38	19	100
13+32	13+38	19	100
14+58	14+69	10	175
17+58	17+69	2	300
19+43	19+49	6	175
22+09	22+14	18	100
23+10	23+14	18	100
24+14	24+14	24	75
24+86	24+91	24	75
26+10	26+18	16	100
27+36	27+40	16	100
29+31	29+38	8	175

STATION BEGIN	STATION END	% SLOPE (AVERAGE)	WATER BAR SPACING (FT)		
2+37	2+45	12	125		
3+63	3+69	12	125		
4+88	4+94	10	175		
6+60	6+ 89	3	300		
9+55	9+69	1	300		
37+21	37+28	17	100		
38+22	38+28	17	100		
39+48	39+52	14	125		
40+75	40+78	14	125		
41+99	42+05	12	125		
43+22	43+28	12	125		
44+48	44+53	19	100		
45+52	45+56	15	125		
46+76	46+82	15	125		
48+02	48+06	15	125		
49+27	49+32	22	75		
50+28	50+31	22	75		
51+27	51+32	7	175		
53+00	53+06	7	175		
55+91	55+98	2	300		
62+33	62+38	15	125		
63+58	63+62	15	125		
67+92	67+98	18	100		
69+15	69+21	18	100		

TAR-7 WATERLINE WATER BAR SPACING*

"WATER BAR SPACING IS BASED ON THE WEST VIRGINIA EROSION AND SEDIMENT CONTROL FIELD MANUAL TABLE II-8: SPACING OF RIGHT OF WAY DIVERSIONS, SOME WATER BARS HAVE BEEN OVER-DESIGNED AT THE DISCRETION OF THE ENGINEER BASED ON EXISTING FIELD CONDITIONS.
"FILTER SOCK DESIGN BASED ON THE TABLE FOUND IN THE FILTERXX LOW IMPACT DESIGN MANUAL, VERSION 8, SECTION 1: EROSION & SEDIMENT CONTROL, PAGE 324.

IFC

07/29/14

	SUMMARY	OF MATERIALS	REFE	RENCE DRAWINGS	1	R	EVISIONS
MRKR#	QTY.	DESCRIPTION	DWG.	DESCRIPTION	NO.	DATE	DESCRIPTION
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EROSION AND SEDIMENT CONTROL TABLES

MEATHOUSE TO OX11 WATERLINE

CONSOL ENERGY

DRAWN: CHECKED: SHEET NO. 200 EVERGREENE DRIVE

56 of 57

JOB NO.:

DESIGN:

07/29/14

750589

8EM

ВЕМ

ВЈМ

WAYNESBURG, PA 15370

EROSION AND SEDIMENT CONTROL BMP PRACTICES				
ВМР	UNITS	QUANTITY		
COMPOST FILTER SOCK	FT	15,890		
2° COMPOST FILTER SOCK	FT	1,173		
8" COMPOST FILTER SOCK	FT	1,215		
SUPER SILT FENCE	FT	22,529		
SILT FENCE	FT	568		
STABILIZED CONSTRUCTION ENTRANCE	EA	15		
TEMPORARY WATERBARS	EA	383		
TIMBER MATS (10 FT WIDTH, ASSUME 8 FT SECTION LENGTHS)	LF	344		
STREAM CROSSING - CRIBBING (SEE DETAIL SHEET #4)	EA	14		
TOB TO TOB (PIPELINE)	LF	56		
TOB TO TOB (ACCESS ROADS)	LF	6		

PAR-1 EARTHWO	RK SUB-SUMMAI	₹Y
DESCRIPTION	QUANTITY	UNITS
ACCES	SS DRIVE	
RAW CUT (EXIST. TO FINISHED GRADE)	366	CY
RAW FILL (EXIST. TO FINISHED GRADE)	532	CY
TOTAL DRIVE EARTHWORK	166 (IMPORT)	CY

TAR-1 EARTHW	ORK SUB-SUMMAF	₹Y
DESCRIPTION	QUANTITY	UNITS
ACC	ESS DRIVE	
RAW CUT (EXIST. TO FINISHED GRADE)	5394	CY
RAW FILL (EXIST. TO FINISHED GRADE)	5229	CY
TOTAL DRIVE EARTHWORK	114 (SPOIL)	CY

TAR-3A EARTHWORK SUB-SUMMARY				
DESCRIPTION QUANTITY UNITS				
ACCESS DRIVE				
RAW CUT (EXIST, TO FINISHED GRADE)	1012	CY		
RAW FILL (EXIST. TO FINISHED GRADE)	1080	CY		
TOTAL DRIVE EARTHWORK	68 (IMPORT)	CY		

TAR-3B EARTHW	ORK SUB-SUMMA	RY			
DESCRIPTION QUANTITY UNITS					
ACC	ESS DRIVE				
RAW CUT (EXIST. TO FINISHED GRADE) 957 CY					
RAW FILL (EXIST. TO FINISHED GRADE) 964 CY					
OTAL DRIVE EARTHWORK 6 (IMPORT) CY					

TAR-6 EARTHW	ORK SUB-SUMMAR	RY			
DESCRIPTION QUANTITY UNITS					
ACCI	ESS DRIVE				
RAW CUT (EXIST. TO FINISHED GRADE)	331	CY			
RAW FILL (EXIST. TO FINISHED GRADE)	274	CY			
TOTAL DRIVE EARTHWORK	57 (SPOIL)	CY			

TAR-7 EARTHW	ORK SUB-SUMMAR	RY			
DESCRIPTION QUANTITY UNITS					
ACCI	SS DRIVE				
RAW CUT (EXIST. TO FINISHED GRADE)	2463	CY			
RAW FILL (EXIST. TO FINISHED GRADE)	2350	CY			
TOTAL DRIVE EARTHWORK	113 (SPOIL)	CY			

	STREAM CR	OSSINGS - PI	PELINE	
STREAM ID	тов	тов	LENGTH (LF)	TIMBER MAT LENGTH (LF)
STREAM 6	94+25	94+27	2	24
STREAM G53	114+64	114+65	1	16
STREAM G52	139+40	139+47	7	16
STREAM G50	161+49	161+55	6	16
STREAM G48	188+25	188+28	3	16
STREAM G44	202+76	202+80	4	16
STREAM G41	252+22	252+25	3	24
STREAM G36	271+07	271+10	3	16
STREAM G32	273+58	273+62	4	16
STREAM G31	289+53	289+56	3	16
STREAM G30	291+65	291+67	2	16
STREAM CC	354+31	354+34	3	40
STREAM ZZ	390+85	390+95	10	32
STREAM ZA	417+01	417+06	5	16
		TOTAL:	56	280

STREAM CROSSINGS - ACCESS ROADS					
STREAM ID TOB TOB LENGTH (LF) TIMBER MATS					
STREAM G64 (TAR-7)	1+74	1+77	3	2X16'	
STREAM G68 (TAR-7)	24+61	24+64 3		2X16'	
		TOTAL:	6	64	

WETLAND CROSSINGS - PIPELINE					
WETLAND ID	EDGE	EDGE	LENGTH (LF)	TIMBER MAT LENGTH (LF)	
WETLAND E	94+18	94+35	17	24	
		TOTAL:	17	24	

	ROAD CRC	SSINGS - PIP	ELINE	
ROAD	EOP	EOP	LENGTH (LF)	PAVED / UNPAVED
CR 13/3	162+04	162+08	4	UNPAVED
MAXWELL RIDGE RD (CR 13)	249+89	249+96	7	UNPAVED
CAIN RUN RD (CR 40)	355+05	355+15	10	UNPAVED
S FORK HUGHES RIVER RD (CR 19/11)	389+82	389+94	12	UNPAVED
S FORK HUGHES RIVER RD (CR 19/11)	417+41	417+49	8	UNPAVED
		TOTAL:	41	

IFC

07/29/14

DATE

:	SUMMA	ARY OF MATERIALS	REFERENCE DRAWINGS		REVISIONS		REVISIONS
MRKR#	QTY,	DESCRIPTION	DWG.	DESCRIPTION	NO.	DATE	DESCRIPTION
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CESA

CREATION TO COMPLETION

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MEATHOUSE TO OX11 WATERLINE

EARTHWORK AND QUANTITIES

ATION(S):



200 EVERGREENE DRIVE WAYNESBURG, PA 15370

DATE:	07/29/14
JOB NO.:	750589
DESIGN:	BEM
DRAWN:	BEM
CHECKED:	ВЈМ
SHEET NO.	

57 of 57



Edwin Wriston < doddridgecountyfpm@gmail.com>

FW: Floodplain Permit Application Status- Meathouse Fork-OX11 (Email 1 of 2)

1 message

Natalie Hooton hooton@cesoinc.com
To: Edwin Wriston doddridgecountyfpm@gmail.com

Fri, Dec 19, 2014 at 1:47 PM

Good afternoon Mr. Wriston. With the holidays quickly approaching, I wanted to confirm that you had received the e-mails regarding the Meathouse Fork-OX11 project. We previously applied for the Doddridge County floodplain permit on July 31, 2014 and recently received all the necessary permits. The permits were originally e-mailed to you on December 11, 2014.

Could you please let us know if you require any additional information in order to provide a floodplain permit? Thank you for your assistance.

Hope you have a Merry Christmas!

Natalie

Natalie Hooton



CESO, Inc.

800 Bursca Dr. Suite 804

Bridgeville, PA 15017

P: (412) 221-2236 x 2009 | F: (412) 221-2267

Email: hooton@cesoinc.com | Website: www.cesoinc.com

From: Natalie Hooton

Sent: Thursday, December 11, 2014 3:42 PM

To: 'Edwin Wriston'

Subject: FW: Floodplain Permit Application Status- Meathouse Fork-OX11 (Email 1 of 2)

Mr. Wriston- Please see the attached approved permits for Meathouse Fork-OX11. These are all of the permits requested for this project. Because this project is within the Limits of Disturbance of the EQTOX11 and Sherwood South projects, a separate USFWS approval was not needed; therefore, I have attached a copy of the USFWS approval for EQTOX11 and Sherwood South.

The DOH permits were too large to all fit in this email (and could not be optimized to a smaller size). The remaining permit will be sent in a separate e-mail directly following this one.

Please let me know if you need any further information or clarification. Additionally, we anticipate USACE for the EQTOX11 and Sherwood South lines before the end of the year.

Thank you!

Natalie

Natalie Hooton



CESO, Inc.

Gmail - FW: Floodplain Permit Application Status- Meathouse Fork-OX11 (Email 1 of 2) Page 3 of 9

800 Bursca Dr. Suite 804

Bridgeville, PA 15017

P: (412) 221-2236 x 2009 | F: (412) 221-2267

Email: hooton@cesoinc.com | Website: www.cesoinc.com

From: Natalie Hooton

Sent: Thursday, December 11, 2014 11:43 AM

To: 'Edwin Wriston'

Subject: RE: Floodplain Permit Application Status- Red-Orange Waterline

Good morning Mr. Wriston. I wanted to update you on the status of our three outstanding projects. We just received approval for EQT-OX11 and Sherwood South from the USFWS. We have submitted this approval to the USACE and are waiting for their approval. Additionally, the clients have decided to construct the Meathouse Fork-OX11 line within the Limits of Disturbance of the EQT-OX11 and Sherwood South projects which eliminates the need for separate USFWS approval for that project. We appreciate your patience and will get you the approvals as soon as possible.

Thank you for your understanding.

Natalie Hooton



CESO, Inc.

800 Bursca Dr. Suite 804

Bridgeville, PA 15017

P: (412) 221-2236 x 2009 | F: (412) 221-2267

Email: hooton@cesoinc.com | Website: www.cesoinc.com

From: Natalie Hooton

Sent: Thursday, November 13, 2014 9:54 AM

To: 'Edwin Wriston'

Subject: RE: Floodplain Permit Application Status- Red-Orange Waterline

Mr. Wriston- We are still waiting on approval from at least two agencies for EQT-OX11 and Meathouse Fork. I'll send everything to you as soon as I get them.

Thanks again,

Natalie Hooton



CESO, Inc.

800 Bursca Dr. Suite 804

Bridgeville, PA 15017

P: (412) 221-2236 x 2009 | F: (412) 221-2267

Email: hooton@cesoinc.com | Website: www.cesoinc.com

From: Edwin Wriston [mailto:doddridgecountyfpm@gmail.com]

Sent: Thursday, November 13, 2014 9:48 AM

To: Natalie Hooton

Subject: Re: Floodplain Permit Application Status- Red-Orange Waterline

Natalie,

Perfect! You will have the approved permit within the hour!

Any word on the EQT to OX 11 and/or the Meathouse Fork to OX11 Waterline project permits? Those two projects are still pending as well...

On Thu, Nov 13, 2014 at 9:37 AM, Natalie Hooton hooton@cesoinc.com wrote:

Mr. Wriston- We have provided you with copies of all the required permits for this particular project. It is my understanding that the floodplain permit for Doddridge County is the only outstanding permit for the Red-Orange waterline project.

Thank you,

Natalie Hooton



CESO, Inc.

800 Bursca Dr. Suite 804

Bridgeville, PA 15017 P: (412) 221-2236 x 2009 | F: (412) 221-2267 Email: hooton@cesoinc.com | Website: www.cesoinc.com **From:** Edwin Wriston [mailto:doddridgecountyfpm@gmail.com] Sent: Thursday, November 13, 2014 9:28 AM To: Natalie Hooton Subject: Re: Floodplain Permit Application Status- Red-Orange Waterline Natalie, Are these all the additional needed permits? Any still outstanding other than the floodplain permit? V/R, On Thu, Nov 13, 2014 at 8:40 AM, Natalie Hooton hooton@cesoinc.com wrote: Good morning Mr. Wriston. Per your request, I am attaching letters from the WV DEP, WVDNR (Wildlife Resources Section), WVDNR (Office of Land and Streams), USACE, and the USFWS regarding the Red-Orange line. Originally, a floodplain permit application with associated floodplain fees for this waterline was submitted to your office on July 29, 2014. Please let me know if you will require any additional documentation or if this will satisfy the requirements for you to issue a permit for the Red-Orange waterline. Thank you for your time and assistance. Natalie Hooton



CESO, Inc.

800 Bursca Dr. Suite 804

Bridgeville, PA 15017

P: (412) 221-2236 x 2009 | F: (412) 221-2267

Email: hooton@cesoinc.com | Website: www.cesoinc.com

Edwin L. "Bo" Wriston, Floodplain Manager

Doddridge County Commission

118 East Court Street

West Union, WV 26456

Work Phone: 1-304-873-2631

Mobile Phone: 1-304-629-3735

Fax: 1-304-873-1840

doddridgecountyfpm@gmail.com

www.doddridgecounty.wv.gov

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Edwin L. "Bo" Wriston, Floodplain Manager

Doddridge County Commission

118 East Court Street

West Union, WV 26456

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8 attachments

77K 2014-07-14 WVDNR RTE Response.pdf

2014-09-09 Meathouse-OX11 - WVDEP Permit #WVR310356 - Approved.pdf

MeathouseForkOX11_RightofEntry_LS-14-VI_09-1138.pdf

MeathouseForkOX11_RightofEntry_LS-14-VI_09-1139.pdf 153K

MeathouseForkOX11_RightofEntry_P-14-VI_09-1137.pdf 792K

USFWS_Approval_EQTtoOX11andSherwoodSouthPipelines .pdf 699K

2014-11-21 Meathouse to OX11 Utility approvals (DOH).pdf 6420K

2014-11-21 Oxford 11 to Meathouse Approach Approvals (2DOH).pdf 12275K



Attachment D- Project Location-Adjacent and/or Affected Landowners

TAX ID: 09-06-0003-0001-0001-0000

NAME OF SURFACE OWNER/OWNERS: George Adrian et al.

ADDRESS OF PROPERTY: Off of Route 18, New Milton, WV 26411

ADDRESS OF SURFACE OWNER/OWNERS: Route 1 Box 95A, New Milton, WV 26411

TAX ID: 09-06-0007-0001-0000-0000

NAME OF SURFACE OWNER/OWNERS: I.L. Ike Morris

ADDRESS OF PROPERTY: 3 Route 40 Over, New Milton, WV 26411

ADDRESS OF SURFACE OWNER/OWNERS: P.O. Box 397, Glenville, WV 26351

TAX ID: 09-07-0006-0001-0000-0000

NAME OF SURFACE OWNER/OWNERS: Justin Henderson

ADDRESS OF PROPERTY: Route 13, West Union, WV 26456

ADDRESS OF SURFACE OWNER/OWNERS: P.O. Box 476, West Union, WV 26456

TAX ID: 09-06-0003-0002-0000-6001

NAME OF SURFACE OWNER/OWNERS: I.L. Ike Morris

ADDRESS OF PROPERTY: Route 23, West Union, WV 26456

ADDRESS OF SURFACE OWNER/OWNERS: P.O. Box 397, Glenville, WV 26351

TAX ID: 09-08-0023-0002-0000-0000

NAME OF SURFACE OWNER/OWNERS: Mary H. Holland

ADDRESS OF PROPERTY: Route 4, West Union, WV 26456

ADDRESS OF SURFACE OWNER/OWNERS: P.O. Box 425, West Union, WV 26456

TAX ID: 09-06-0004-0009-0000-6001

NAME OF SURFACE OWNER/OWNERS: Haessly Hardwood Lumber Co.

ADDRESS OF PROPERTY: Route 18 Blandville, New Milton, WV, 26411

ADDRESS OF SURFACE OWNER/OWNERS: Route 1Box 185, Marietta, OH 45750



Attachment D- Project Location-Adjacent and/or Affected Landowners

TAX ID: 09-06-0003-0007-0001-0000

NAME OF SURFACE OWNER/OWNERS: Denise Donahoo

ADDRESS OF PROPERTY: Route 18/Blandville, New Milton, WV 26411

ADDRESS OF SURFACE OWNER/OWNERS: RR 1 Box 25DD, New Milton, WV 26411

TAX ID: 09-06-0003-0007-0002-3001

NAME OF SURFACE OWNER/OWNERS: Timothy & Rebecca Clyne

ADDRESS OF PROPERTY: Off Route 18/Blandville, New Milton, WV 26411

ADDRESS OF SURFACE OWNER/OWNERS: HC 68 Box 14, West Union, WV 26456

TAX ID: 09-06-0003-0006-0001-0000

NAME OF SURFACE OWNER/OWNERS: Timothy & Rebecca Clyne

ADDRESS OF PROPERTY: Off Route 18/Blandville, New Milton, WV 26411

ADDRESS OF SURFACE OWNER/OWNERS: HC 68 Box 14, West Union, WV 26456

TAX ID: 09-06-0003-0011-0000-0000

NAME OF SURFACE OWNER/OWNERS: Lewis Frederick Maxwell

ADDRESS OF PROPERTY: Lick Run Route 40, New Milton, WV 26411

ADDRESS OF SURFACE OWNER/OWNERS: Route 1 Box 26B, New Milton, WV 26411

TAX ID: 09-06-0003-0012-0000-0000

NAME OF SURFACE OWNER/OWNERS: Robert Gayle Maxwell

ADDRESS OF PROPERTY: Off Route 13/Right Hand Fork Run, New Milton, WV 26411

ADDRESS OF SURFACE OWNER/OWNERS: Route 1 Box 28 A, New Milton, WV 26411

TAX ID: 09-06-0003-0012-0001-0000

NAME OF SURFACE OWNER/OWNERS: Robert Gayle Maxwell

ADDRESS OF PROPERTY: Off Route 13/Right Hand Fork Road, New Milton, WV 26411

ADDRESS OF SURFACE OWNER/OWNERS: Route 1 Box 28 A, New Milton, WV 26411

TAX ID: 09-06-0003-0001-0000-6001

NAME OF SURFACE OWNER/OWNERS: Sue Ann Spiker

ADDRESS OF PROPERTY: Off Route 18/Meathouse Fork, West Union, WV

ADDRESS OF SURFACE OWNER/OWNERS: 166 Linden Lane, Jane Lew, WV 26378



TAX ID: 09-06-0003-0007-0001-0000

NAME OF SURFACE OWNER/OWNERS: Denise Donahoo

ADDRESS OF PROPERTY: Route 18/Blandville, New Milton, WV 26411

ADDRESS OF SURFACE OWNER/OWNERS: RR 1 Box 25DD, New Milton, WV 26411

DISTRICT: New Milton

LAND BOOK DESCRIPTION:

DEED BOOK REFERENCE: Book 260/Page 643

TAX MAP REFERENCE: Map 3/ Parcel 7

EXISTING BUILDINGS/USES OF PROPERTY: Residential structure on the northern portion of parcel; remaining land is forested or open fields; Lick Run flows through the property

NAME OF AT LEAST ONE ADULT RESIDING IN EACH RESIDENCE LOCATED UPON THE SUBJECT

PROPERTY: Unknown

ADDRESS OF AT LEAST ONE ADULT RESIDING IN EACH RESIDENCE LOCATED UPON THE SUBJECT

PROPERTY: Unknown

TAX ID: 09-06-0003-0007-0002-3001

NAME OF SURFACE OWNER/OWNERS: Timothy & Rebecca Clyne

ADDRESS OF PROPERTY: Off Route 18/Blandville, New Milton, WV 26411

ADDRESS OF SURFACE OWNER/OWNERS: HC 68 Box 14, West Union, WV 26456

DISTRICT: New Milton

LAND BOOK DESCRIPTION:

DEED BOOK REFERENCE: Book 266/ Page 220

TAX MAP REFERENCE: MAP 3/ Parcel 7

EXISTING BUILDINGS/USES OF PROPERTY: No apparent structures, possible access roads, forested

NAME OF AT LEAST ONE ADULT RESIDING IN EACH RESIDENCE LOCATED UPON THE SUBJECT

PROPERTY: Unknown

ADDRESS OF AT LEAST ONE ADULT RESIDING IN EACH RESIDENCE LOCATED UPON THE SUBJECT

PROPERTY: Unknown



TAX ID: 09-06-0003-0006-0001-0000

NAME OF SURFACE OWNER/OWNERS: Timothy & Rebecca Clyne

ADDRESS OF PROPERTY: Off Route 18/Blandville, New Milton, WV 26411

ADDRESS OF SURFACE OWNER/OWNERS: HC 68 Box 14, West Union, WV 26456

DISTRICT: New Milton

LAND BOOK DESCRIPTION:

DEED BOOK REFERENCE: Book 260/ Page 630

TAX MAP REFERENCE: MAP 3/ Parcel 6

EXISTING BUILDINGS/USES OF PROPERTY: Possible residential structure in northwest corner of

the parcel; remaining land open fields or forested

NAME OF AT LEAST ONE ADULT RESIDING IN EACH RESIDENCE LOCATED UPON THE SUBJECT

PROPERTY: Unknown

ADDRESS OF AT LEAST ONE ADULT RESIDING IN EACH RESIDENCE LOCATED UPON THE SUBJECT

PROPERTY: Unknown

TAX ID: 09-06-0003-0011-0000-0000

NAME OF SURFACE OWNER/OWNERS: Lewis Frederick Maxwell

ADDRESS OF PROPERTY: Lick Run Route 40, New Milton, WV 26411

ADDRESS OF SURFACE OWNER/OWNERS: Route 1 Box 26B, New Milton, WV 26411

DISTRICT: New Milton

LAND BOOK DESCRIPTION:

DEED BOOK REFERENCE: BOOK 255/ Page 86

TAX MAP REFERENCE: MAP 3/ Parcel 11

EXISTING BUILDINGS/USES OF PROPERTY: No apparent structures; land is forested

NAME OF AT LEAST ONE ADULT RESIDING IN EACH RESIDENCE LOCATED UPON THE SUBJECT

PROPERTY: There are currently no residential structures on the property.

ADDRESS OF AT LEAST ONE ADULT RESIDING IN EACH RESIDENCE LOCATED UPON THE SUBJECT

PROPERTY: There are currently no residential structures on the property.



TAX ID: 09-06-0003-0012-0000-0000

NAME OF SURFACE OWNER/OWNERS: Robert Gayle Maxwell

ADDRESS OF PROPERTY: Off Route 13/Right Hand Fork Run, New Milton, WV 26411

ADDRESS OF SURFACE OWNER/OWNERS: Route 1 Box 28 A, New Milton, WV 26411

DISTRICT: New Milton

LAND BOOK DESCRIPTION:

DEED BOOK REFERENCE: Book 220/ Page 79

TAX MAP REFERENCE: MAP 3/ Parcel 12

EXISTING BUILDINGS/USES OF PROPERTY: Apparent residential structure on the southern portion

of the parcel; Right Hand Fork flows through property; mostly forested

NAME OF AT LEAST ONE ADULT RESIDING IN EACH RESIDENCE LOCATED UPON THE SUBJECT

PROPERTY: Unknown

ADDRESS OF AT LEAST ONE ADULT RESIDING IN EACH RESIDENCE LOCATED UPON THE SUBJECT

PROPERTY: Unknown

TAX ID: 09-06-0003-0012-0001-0000

NAME OF SURFACE OWNER/OWNERS: Robert Gayle Maxwell

ADDRESS OF PROPERTY: Off Route 13/Right Hand Fork Road, New Milton, WV 26411

ADDRESS OF SURFACE OWNER/OWNERS: Route 1 Box 28 A, New Milton, WV 26411

DISTRICT: New Milton

LAND BOOK DESCRIPTION:

DEED BOOK REFERENCE: Book 214/ Page 233

TAX MAP REFERENCE: MAP 3/ Parcel 12

EXISTING BUILDINGS/USES OF PROPERTY: No apparent structures; forested; Right Hand Fork

flows through the property

NAME OF AT LEAST ONE ADULT RESIDING IN EACH RESIDENCE LOCATED UPON THE SUBJECT

PROPERTY: Unknown

ADDRESS OF AT LEAST ONE ADULT RESIDING IN EACH RESIDENCE LOCATED UPON THE SUBJECT

PROPERTY: Unknown



TAX ID: 09-06-0003-0001-0000-6001

NAME OF SURFACE OWNER/OWNERS: Sue Ann Spiker

ADDRESS OF PROPERTY: Off Route 18/Meathouse Fork, West Union, WV

ADDRESS OF SURFACE OWNER/OWNERS: 166 Linden Lane, Jane Lew, WV 26378

DISTRICT: New Milton

LAND BOOK DESCRIPTION:

DEED BOOK REFERENCE: Book 214/ Page 675

TAX MAP REFERENCE: MAP 3/ Parcel 1

EXISTING BUILDINGS/USES OF PROPERTY: Possible oil wells present; small structure in the

northeast corner of the parcel; forested; Georgescamp Run flows through property

NAME OF AT LEAST ONE ADULT RESIDING IN EACH RESIDENCE LOCATED UPON THE SUBJECT

PROPERTY: Unknown

ADDRESS OF AT LEAST ONE ADULT RESIDING IN EACH RESIDENCE LOCATED UPON THE SUBJECT

PROPERTY: Unknown

TAX ID: 09-06-0003-0001-0001-0000

NAME OF SURFACE OWNER/OWNERS: George Adrian et al.

ADDRESS OF PROPERTY: Off of Route 18, New Milton, WV 26411

ADDRESS OF SURFACE OWNER/OWNERS: Route 1 Box 95A, New Milton, WV 26411

DISTRICT: New Milton

LAND BOOK DESCRIPTION:

DEED BOOK REFERENCE: BOOK 260/ Page 641

TAX MAP REFERENCE: MAP 3/ Parcel 1

EXISTING BUILDINGS/USES OF PROPERTY: No apparent structures; possible oil wells present;

forested

NAME OF AT LEAST ONE ADULT RESIDING IN EACH RESIDENCE LOCATED UPON THE SUBJECT

PROPERTY: There are currently no residential structures on the property.

ADDRESS OF AT LEAST ONE ADULT RESIDING IN EACH RESIDENCE LOCATED UPON THE SUBJECT

PROPERTY: There are currently no residential structures on the property.



TAX ID: 09-06-0007-0001-0000-0000

NAME OF SURFACE OWNER/OWNERS: I.L. Ike Morris

ADDRESS OF PROPERTY: 3 Route 40 Over, New Milton, WV 26411

ADDRESS OF SURFACE OWNER/OWNERS: P.O. Box 397, Glenville, WV 26351

DISTRICT: New Milton

LAND BOOK DESCRIPTION:

DEED BOOK REFERENCE: Book 230/ Page 307

TAX MAP REFERENCE: MAP 7/ Parcel 1

EXISTING BUILDINGS/USES OF PROPERTY: No apparent structures on property; access roads and

possible oil wells present; forested

NAME OF AT LEAST ONE ADULT RESIDING IN EACH RESIDENCE LOCATED UPON THE SUBJECT

PROPERTY: Unknown

ADDRESS OF AT LEAST ONE ADULT RESIDING IN EACH RESIDENCE LOCATED UPON THE SUBJECT

PROPERTY: Unknown

TAX ID: 09-07-0006-0001-0000-0000

NAME OF SURFACE OWNER/OWNERS: Justin Henderson

ADDRESS OF PROPERTY: Route 13, West Union, WV 26456

ADDRESS OF SURFACE OWNER/OWNERS: P.O. Box 476, West Union, WV 26456

DISTRICT: New Milton

LAND BOOK DESCRIPTION:

DEED BOOK REFERENCE: BOOK WB29/ Page 224

TAX MAP REFERENCE: MAP 6/ Parcel 1

EXISTING BUILDINGS/USES OF PROPERTY: No apparent structures; possible oil wells present;

Bluestone Creek flows through property

NAME OF AT LEAST ONE ADULT RESIDING IN EACH RESIDENCE LOCATED UPON THE SUBJECT

PROPERTY: There are currently no residential structures on the property.

ADDRESS OF AT LEAST ONE ADULT RESIDING IN EACH RESIDENCE LOCATED UPON THE SUBJECT

PROPERTY: There are currently no residential structures on the property.



TAX ID: 09-06-003-0002-0000-6001

NAME OF SURFACE OWNER/OWNERS: I.L. Ike Morris

ADDRESS OF PROPERTY: Route 23, West Union, WV 26456

ADDRESS OF SURFACE OWNER/OWNERS: P.O. Box 397, Glenville, WV 26351

DISTRICT: Southwest

LAND BOOK DESCRIPTION:

DEED BOOK REFERENCE: Book 230/ Page 307

TAX MAP REFERENCE: MAP 10/ Parcel 2

EXISTING BUILDINGS/USES OF PROPERTY: There are currently several horizontal 6A wells with access roads located on the property. One residential (rented) structure is present on the property. The remaining portions of the parcel are forested and undeveloped.

NAME OF AT LEAST ONE ADULT RESIDING IN EACH RESIDENCE LOCATED UPON THE SUBJECT PROPERTY: Unknown

ADDRESS OF AT LEAST ONE ADULT RESIDING IN EACH RESIDENCE LOCATED UPON THE SUBJECT PROPERTY: Unknown



Edwin Wriston <doddridgecountyfpm@gmail.com>

Floodplain Fee Calculations for Projects submitted by CESO

1 message

Natalie Hooton hooton@cesoinc.com

Fri, Aug 1, 2014 at 1:30 PM

To: "doddridgecountyFPM@gmail.com" <doddridgecountyFPM@gmail.com>

Mr. Wriston- Below are the calculations that were made to determine the fees required for the Doddridge County Floodplain permits. Please let me know if additional information is required. Thank you for your assistance. Natalie

EQT-OX11

- Pipeline & Waterline Construction 370 LF * \$250 = \$92,500
- Timber Matting = \$500
- Access Road Apron 2 EA * \$1,000 = \$2,000
- Total Floodplain Construction Cost = \$95,000
- Check Amount Required = \$500

Meathouse Fork-OX11

- Waterline Construction 435 LF *150 = \$65,250
- Timber Matting = \$500
- Temp Pad Intake = \$20,000
- Total Floodplain Construction Cost = \$85,750
- Check Amount Required = \$500

Red to Orange Waterline

- Pipeline & Waterline Construction 1,693 LF * \$150 = \$254,000
- Timber Matting = \$500
- Total Floodplain Construction Cost = \$254,500
- Check Amount Required = \$1,000 + (\$5 * (154,500/1,000) = \$1,772.50

Orange to Blue Waterline

- Waterline Construction 4,415 LF *150 = \$662,250
- Timber Matting = \$1,750
- Access Roads 5 * \$2,500 = \$12,500
- Total Floodplain Construction Cost = \$676,500
- Check Amount Required = \$1,000 + (\$5 * (576,500/1,000) = \$3,882.50

Natalie Hooton



CESO, Inc.

800 Bursca Dr. Suite 804

Bridgeville, PA 15017

P: (412) 221-2236 x 2009 | F: (412) 221-2267

Email: hooton@cesoinc.com | Website: www.cesoinc.com

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STATE OF WEST VIRGINIA, COUNTY OF DODDRIDGE, TO WIT

I, Virginia Nicholson, Editor of THE HERALD RECORD, a weekly newspaper
published regularly, in Doddridge County,
West Virginia, Do Hereby Certify That the Accompanying Legal Notice
Floodplain Permit
\$ 14-253
OX 11 Waterbine Meathouse Fork was published in said paper for 2
successive weeks beginning with the issue
of August 5th 2014 and
ending with the issue of
August 12th 2014 and
that said notice contains 1.8.9
WORD SPACE at
amounts to the sum of \$211.7.4
FOR FIRST PUBLICATION, SECOND PUBLICATION IS 75% OF THE FIRST PUBLICATION
\$
s 3905 TOTAL
Diginia Nicholson
SWORN TO AND SUBSCRIBED
BEFORE ME THIS THE DAY
OF Muguel 2014
NOTARY PUBLIC
OFFICIAL SEAL OFFICIAL SEAL Notary Public, State Of West Virginia LAURA J ADAMS 212 Edmond Street West Union, WV 26456 My Commission Expires June 14, 2023