

# Floodplain Development Permit

## Doddridge County, WV Floodplain Management

This permit gives approval for the development/ project listed that impacts the FEMA-designated floodplain and/or floodway of Doddridge County, WV, pursuant to the rules and regulations established by all applicable Federal, State and local laws and ordinances, including the Doddridge County Floodplain Ordinance. This permit must be posted at the site of work as to be clearly visible and must remain posted during entirety of development.

**Permit: #20-583**

**Date Approved: November 9, 2020**      **Expires: November 9, 2021**

**Issued to: Doddridge County Board of Education**      **POC: Jeff Harvey**

**Company Address: 68 Bulldog Drive West Union, WV 26456**

**Project Address: 69 Cline Stansberry Road West Union, WV 26456**

**Firm: 54017C0120C**

**Lat/Long: 39.289528N, -80.770311W**

**Purpose of Development: Construction of Early Childhood Academy**

**Issued by: George C. Eidel, CFM, OEM Director/Doddridge County FPM (or designee)**

**Date: November 9, 2020**

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For additional information regarding this permit, please contact  
Doddridge County Floodplain Manager at 304.873.2631, or via email at  
doddridgecountyfpm@gmail.com  
118 East Court Street; West Union, WV 26456

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**SENDER: COMPLETE THIS SECTION**

- Complete items 1, 2, and 3.
- Print your name and address on the reverse so that we can return the card to you.
- Attach this card to the back of the mailpiece, or on the front if space permits.

1. Article Addressed to:

**Druid County Board of Education  
68 Bulldog Drive  
West Union, WV 26456**



9590 9402 5586 9274 5541 63

2. Article Number (Transfer from service label)

PS Form 3811, July 2015 PSN 7530-02-000-9053

**COMPLETE THIS SECTION ON DELIVERY**

A. Signature

X Covid 19

- Agent
- Addressee

B. Received by (Printed Name)

John RCI

C. Date of Delivery

10/14

D. Is delivery address different from item 1?  Yes  
If YES, enter delivery address below:  No

3. Service Type

- Adult Signature
- Adult Signature Restricted Delivery
- Certified Mail®
- Certified Mail Restricted Delivery
- Collect on Delivery
- Collect on Delivery Restricted Delivery
- Insured Mail
- Insured Mail Restricted Delivery (over \$500)
- Priority Mail Express®
- Registered Mail™
- Registered Mail Restricted Delivery
- Return Receipt for Merchandise
- Signature Confirmation™
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Domestic Return Receipt

**SENDER: COMPLETE THIS SECTION**

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- Print your name and address on the reverse so that we can return the card to you.
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1. Article Addressed to:

**Earl R. Daugherty  
P.O. Box 341  
West Union, WV 26456**



9590 9402 5586 9274 5541 56

2. Article Number (Transfer from service label)

PS Form 3811, July 2015 PSN 7530-02-000-9053

**COMPLETE THIS SECTION ON DELIVERY**

A. Signature

X Tim Miller

- Agent
- Addressee

B. Received by (Printed Name)

10-14-20

C. Date of Delivery

D. Is delivery address different from item 1?  Yes  
If YES, enter delivery address below:  No

3. Service Type

- Adult Signature
- Adult Signature Restricted Delivery
- Certified Mail®
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- Collect on Delivery
- Collect on Delivery Restricted Delivery
- Insured Mail
- Insured Mail Restricted Delivery (over \$500)
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## FLOODPLAIN PERMIT #20-583

DCBOE, 69 C Stansberry Rd, Early Childhood Academy, 39.289528, -80.770311

TASK	COMPLETE (DATE)	NOTES
CHECK RECEIVED	N/A	Fee Waived
US ARMY CORP. ENGINEERS (USACE)		
US FISH & WILDLIFE SERVICES (USFWS)		
WV DEPT. NATURAL RESOURCES (WVDNR)		
WV DEPT. ENVIROMENTAL PROTECTION (WVDEP)	10/13/20	
STATE HISTORIC & PRESERVATION OFFICE (SHPO)		
OFFICE of LAND & STREAM (OLS)		
WVDOH		
Elevation Certificate		
DATE OF COMMISSION READING	10/20/2020	
DATE AVAILABLE TO BE GRANTED	11/9/2020	
PERMIT GRANTED		
COMPLETE		

7019 1640 0001 3402 7160

7019 1640 0001 3402 7184

7019 1640 0001 3402 7153

7019 1640 0001 3402 7177

**SENDER: COMPLETE THIS SECTION**

- Complete items 1, 2, and 3.
- Print your name and address on the reverse so that we can return the card to you.
- Attach this card to the back of the mailpiece, or on the front if space permits.

1. Article Addressed to:

**Town of West Union  
178 Court Street  
West Union, WV 26456**



9590 9402 5586 9274 5541 87

2. Article Number (Transfer from service label)

PS Form 3811, July 2015 PSN 7530-02-000-9053

**COMPLETE THIS SECTION ON DELIVERY**

A. Signature  Agent  
*Robin A. Valentine*  Addressee  
B. Received by (Printed Name) C. Date of Delivery  
*Robin A. Valentine* *10-14-2020*  
D. Is delivery address different from item 1?  Yes  
If YES, enter delivery address below:  No

3. Service Type
- Adult Signature
  - Adult Signature Restricted Delivery
  - Certified Mail®
  - Certified Mail Restricted Delivery
  - Collect on Delivery
  - Collect on Delivery Restricted Delivery
  - Insured Mail
  - Insured Mail Restricted Delivery (over \$500)
  - Priority Mail Express®
  - Registered Mail™
  - Registered Mail Restricted Delivery
  - Return Receipt for Merchandise
  - Signature Confirmation™
  - Signature Confirmation Restricted Delivery

Domestic Return Receipt

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- Complete items 1, 2, and 3.
- Print your name and address on the reverse so that we can return the card to you.
- Attach this card to the back of the mailpiece, or on the front if space permits.

1. Article Addressed to:

**James L. McAfee  
13 Deer Lane  
West Union, WV 26456**



9590 9402 5586 9274 5541 70

2. Article Number (Transfer from service label)

PS Form 3811, July 2015 PSN 7530-02-000-9053

**COMPLETE THIS SECTION ON DELIVERY**

A. Signature  Agent  
*James L McAfee*  Addressee  
B. Received by (Printed Name) C. Date of Delivery  
*James L McAfee* *10-15-20*  
D. Is delivery address different from item 1?  Yes  
If YES, enter delivery address below:  No

3. Service Type
- Adult Signature
  - Adult Signature Restricted Delivery
  - Certified Mail®
  - Certified Mail Restricted Delivery
  - Collect on Delivery
  - Collect on Delivery Restricted Delivery
  - Insured Mail
  - Insured Mail Restricted Delivery (over \$500)
  - Priority Mail Express®
  - Registered Mail™
  - Registered Mail Restricted Delivery
  - Return Receipt for Merchandise
  - Signature Confirmation™
  - Signature Confirmation Restricted Delivery

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## Doddridge County Floodplain Permits

(Week of October 12, 2020)

Please take notice that on the (8<sup>th</sup>) of (October), 2020, (Doddridge County Board of Education) filed an application for a Floodplain Permit (#20-583) to develop land located at or about (69 C Stansberry Rd); **Coordinates: 39.289528, -80.770311**. The Application is on file with the Floodplain Manager of the County and may be inspected or copied during regular business hours in accordance to WV Code Chapter 29B Freedom of Information, Article 1 Public Records and county policy and procedures. Any interested persons who desire to comment shall present the same in writing by (November 9, 2020) (20 calendar days after the announcement at the regularly scheduled Doddridge County Commission Meeting) delivered to the Floodplain Manager of the County at 105 Court Street, Suite #3, West Union, WV 26456. **This project is for the Early Childhood Academy project**



GEORGE C. EIDEL, CFM

Doddridge County Floodplain Manager


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\$ 3.45  
Extra Services & Fees (check box, add fee as appropriate)  
 Return Receipt (hardcopy) \$ 2.75  
 Return Receipt (electronic) \$  
 Certified Mail Restricted Delivery \$  
 Adult Signature Required \$  
 Adult Signature Restricted Delivery \$



Postage  
\$ .50  
Total Postage and Fees  
\$ 6.70

Sent To  
Town of West Union  
Street and Apt. No., or PO Box No.  
178 Court St.  
City, State, ZIP+4®  
West Union, WV 26456 20-583  
PS Form 3800, April 2015 PSN 7530-02-000-9047 See Reverse for Instructions


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Extra Services & Fees (check box, add fee as appropriate)  
 Return Receipt (hardcopy) \$ 2.75  
 Return Receipt (electronic) \$  
 Certified Mail Restricted Delivery \$  
 Adult Signature Required \$  
 Adult Signature Restricted Delivery \$

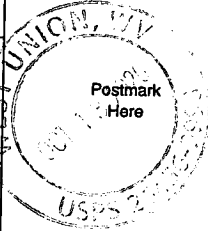

Postage  
\$ .50  
Total Postage and Fees  
\$ 6.70

Sent To  
James L. McAfee  
Street and Apt. No., or PO Box No.  
13 Deer Ln.  
City, State, ZIP+4®  
West Union, WV 26456 20-583  
PS Form 3800, April 2015 PSN 7530-02-000-9047 See Reverse for Instructions


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Extra Services & Fees (check box, add fee as appropriate)  
 Return Receipt (hardcopy) \$ 2.75  
 Return Receipt (electronic) \$  
 Certified Mail Restricted Delivery \$  
 Adult Signature Required \$  
 Adult Signature Restricted Delivery \$

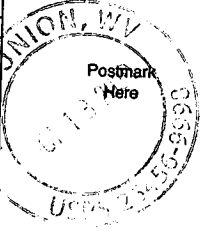

Postage  
\$ .50  
Total Postage and Fees  
\$ 6.70

Sent To  
Doddridge Co. Bd. of Ed.  
Street and Apt. No., or PO Box No.  
68 Bulldog Dr.  
City, State, ZIP+4®  
West Union, WV 26456 20-583  
PS Form 3800, April 2015 PSN 7530-02-000-9047 See Reverse for Instructions


7019 1640 0001 3402 7177
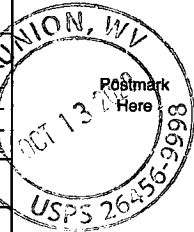
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OFFICIAL USE

Certified Mail Fee  
\$ 3.45  
Extra Services & Fees (check box, add fee as appropriate)  
 Return Receipt (hardcopy) \$ 2.75  
 Return Receipt (electronic) \$  
 Certified Mail Restricted Delivery \$  
 Adult Signature Required \$  
 Adult Signature Restricted Delivery \$



Postage  
\$ .50  
Total Postage and Fees  
\$ 6.70

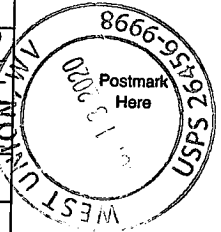Sent To  
Earl R. Daugherty  
Street and Apt. No., or PO Box No.  
P.O. Box 341  
City, State, ZIP+4®  
West Union, WV 26456 20-583  
PS Form 3800, April 2015 PSN 7530-02-000-9047 See Reverse for Instructions

October 12, 2020

Mr. George Eidel  
Doddridge County Office of Emergency Management  
101 Church Street Suite 102  
West Union, WV 26456


**RE: *Doddridge Co. Schools Early Childhood Academy  
Floodplain Permit***

Mr. Eidel;

In additional to the recently submitted H &H report, please find attached an approved WVDEP NPDES permit for the proposed project. The proposed project will be performed in several stages. The goal is to start working on the grading immediately to have the site ready for the building construction late winter and /or early spring. The proposed bridge would also start in late winter/early spring. The existing bridge will not be demoed until the proposed bridge is complete and all internal site roads are finished. Due to the location of the proposed bridge and the utilization of the existing bridge for access, there will be no need for the contractor to be in the stream. Therefore, a WVDNR and Corps of Engineers permit will not be necessary for the bridge construction. However, depending on the means and method of the demolition, additional permits may be necessary to remove existing pier. Also, with part of the existing bridge resting in a portion of the Rt. 18 right of way, a MM109 will be submitted. The DOH will require additional time to review the structural components of the bridge. Therefore, we are requesting if the floodplain permit could be issued now so that the site grading could begin and the DOH permit be provided to you prior to any bridge construction.

Please let me us know if you have any questions or comments.

Sincerely,  
THE THRASHER GROUP, INC.

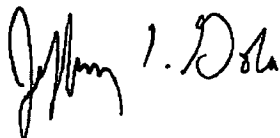

JEFF GOLLA, P.E.  
Project Manager

r:\060\060-10159.00-doddridge early childhood academy-doddridge county board of education-\documents\design\hec ras\flood-plain-letter.docx



Permit#	<u>20-583</u>
Project Name:	<u>Early Childhood Academy</u>
Permittees Name:	<u>DCBOE</u>

OCT 3 20 7:42AM


# Doddridge County, WV

## Floodplain Development Permit Application

This document is to be used for projects that impact/potentially impact the FEMA---designated floodplain and/or floodway of Doddridge County, WV pursuant to the rules and regulations established by all applicable Federal, State and local laws and ordinances, including the Doddridge County Floodplain Ordinance.

### SECTION 1: GENERAL PROVISIONS (APPLICANT TO READ AND SIGN)

1. No work may start until a permit is issued.
2. The permit may be revoked if any false statements are made herein.
3. If revoked, all work must cease until permit is re-issued.
4. The permit will expire if no work is commenced within six months of issuance.
5. Applicant is hereby informed that other permits may be required to fulfill local, state, and federal requirements.
6. Applicant hereby gives consent to the Floodplain Administrator/Manager or his/her representative to make inspections to verify compliance.
7. I THE APPLICANT CERTIFY THAT ALL STATEMENTS HEREIN AND IN ATTACHMENTS TO THIS APPLICATION ARE, TO THE BEST OF MY KNOWLEDGE, TRUE AND ACCURATE.

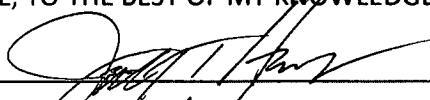APPLICANT'S SIGNATURE 

DATE 10/1/20



Doddridge County Commercial/Industrial  
Floodplain Development Permit Application

**Applicant Information:**

*Please provide all pertinent data.*

<b>Applicant Information</b>		
<b>Responsible Company Name:</b>	Doddridge Co. Board of Education	
<b>Corporate Mailing Address:</b>	68 Bulldog Drive	
<b>City:</b> West Union	<b>State:</b> WV	<b>Zip:</b> 26456
<b>Corporate Point of Contact (POC):</b>	Jeff Harvey	
<b>Corporate POC Title:</b>	Student Support Services	
<b>Corporate POC Primary Phone:</b>	317-716-3555	
<b>Corporate POC Primary Email:</b>	jtharvey@k12.wv.us	
<b>Corporate FEIN:</b>	<b>Corporate DUNS:</b>	
<b>Corporate Website:</b>		
<b>Local Mailing Address:</b>	Same as above	
<b>City:</b>	<b>State:</b>	<b>Zip:</b>
<b>Local Project Manager (PM):</b>		
<b>Local PM Primary Phone:</b>		
<b>Local PM Secondary Phone:</b>		
<b>Local PM Primary Email:</b>		
<b>Person Filing Application:</b>	Jeff Harvey	
<b>Applicant Title:</b>	Student Support Services	
<b>Applicant Primary Phone:</b>	317-716-3555	
<b>Applicant Secondary Phone:</b>	304+873-2300	
<b>Applicant Primary Email:</b>	jtharvey@k12.wv.us	

**Doddridge County Commercial/Industrial  
Floodplain Development Permit Application**

**Project Narrative:**

*Describe in detail the proposed development including project name/title, type of development, estimated start and completion timeline, and its potential impact on the floodplain. Use additional copies of this page as needed.*

<b>Project Narrative:</b>
The project is consists of constructing a Early Childhood Academy facility for the
the Doddridge County BOE. The facility will house both pre-k and kindergarden students
The proposed is for new facility is at the old high school football field. The structure
will have finish floor elevation of 1186.5' which is roughly the elevation of the old
baseball field and approximately 6.5' above the 100 year base flood flood. Over half
the facility will rest on an area that will require 21,000 CY of excavation, the remaining
facility (structure, parking lot, & access road) will be positioned on the engineered fill.
We are also proposing a new bridge farther up rt. 18 that will span the entire Middle
Island Creek with no piers and will allow place the proposed road crossing well above
the 100 base flood. Once the new bridge is constructed, the existing bridge will be
demoed allowing a larger waterway opening. The embankment constructed on the corner
of the exiting football field only causes a small increase of only 0.06' increase in the
100 year base flood. The grading phase of the project is estimated to start in mid
October with the entire facility being finished by the summer of 2022.

Doddridge County Commercial/Industrial  
Floodplain Development Permit Application

**Proposed Development:**

*Please check all elements of the proposed project that apply.*

**DESCRIPTION OF WORK (CHECK ALL APPLICABLE BOXES)**

**A. STRUCTURAL DEVELOPMENT**

<u>ACTIVITY</u>	<u>STRUCTURAL TYPE</u>
<input checked="" type="checkbox"/> New Structure	<input type="checkbox"/> Residential (1 – 4 Family)
<input type="checkbox"/> Addition	<input type="checkbox"/> Residential (more than 4 Family)
<input type="checkbox"/> Alteration	<input checked="" type="checkbox"/> Non-residential (floodproofing)
<input type="checkbox"/> Relocation	<input type="checkbox"/> Combined Use (res. & com.)
<input type="checkbox"/> Demolition	<input type="checkbox"/> Replacement
<input type="checkbox"/> Manufactured/Mobil Home	

**B. OTHER DEVELOPMENT ACTIVITIES:**

- |   |                                 |                                   |                                     |
|---|---------------------------------|-----------------------------------|-------------------------------------|
| <input type="checkbox"/> Fill   | <input type="checkbox"/> Mining | <input type="checkbox"/> Drilling | <input type="checkbox"/> Pipelining |
| <input checked="" type="checkbox"/> Grading   |                                 |                                   |                                     |
| <input type="checkbox"/> Excavation (except for STRUCTURAL DEVELOPMENT checked above)         |                                 |                                   |                                     |
| <input type="checkbox"/> Watercourse Alteration (including dredging and channel modification) |                                 |                                   |                                     |
| <input type="checkbox"/> Drainage Improvements (including culvert work)                       |                                 |                                   |                                     |
| <input checked="" type="checkbox"/> Road, Street, or Bridge Construction                      |                                 |                                   |                                     |
| <input type="checkbox"/> Subdivision (including new expansion)                                |                                 |                                   |                                     |
| <input type="checkbox"/> Individual Water or Sewer System                                     |                                 |                                   |                                     |
| <input type="checkbox"/> Other (please specify)   |                                 |                                   |                                     |

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Doddridge County Commercial/Industrial  
Floodplain Development Permit Application

**Development Site/Property Information:**

*Please provide physical description of the site/property, along with pertinent ownership (surface and mineral rights) data as applicable. Attach appropriate maps from the WV Flood Tool showing location of proposed development. Use additional copies of this page if development spans multiple property boundaries. Designate each property by number (i.e. Property 1 of 1, Property 2 of 7, etc.)*

**Property Designation:** \_\_\_ of \_\_\_

<b>Site/Property Information:</b>		
<b>Legal Description:</b> M I CREEK ATHLETIC FIELD; 10.26 AC		
<b>Physical Address/911 Address:</b> 69 C Stansberry Field Rd.		
<b>Decimal Latitude/Longitude:</b> 39^17'21.75" , 80^46'11.37"		
<b>DMS Latitude/Longitude:</b> 39.289375, -80.769722		
<b>District:</b> 8 West Union Dist	<b>Map:</b> 0011	<b>Parcel:</b> 0077
<b>Land Book Description:</b> 612 - School		
<b>Deed Book Reference:</b> 94/229		
<b>Tax Map Reference:</b> 0011		
<b>Existing Buildings/Use of Property:</b> Athletic fields, concessions structure, locker rooms, bleachers, etc.		

<b>Floodplain Location Data: (to be completed by Floodplain Manager or designee)</b>			
<b>Community:</b>	<b>Number:</b>	<b>Panel:</b>	<b>Suffix:</b>
<b>Location (Lat/Long):</b>		<b>Approximate Elevation:</b>	
		<b>Estimated BFE:</b>	
<b>Is the development in the floodway?</b> <input type="checkbox"/> Yes <input type="checkbox"/> No		<b>Is the development in the floodplain?</b> <input type="checkbox"/> Yes <input type="checkbox"/> No <b>Zone:</b> _____	
<b>Notes:</b>			

Doddridge County Commercial/Industrial  
Floodplain Development Permit Application

**Property Owner Data:**

*Please provide data on current site/property landowner(s), both surface and mineral rights (as applicable). Use additional copies of this page as needed. Designate each page in relation to each property listed above.*

<b>Property Designation:</b> ____ of ____
---

<b>Property Owner Data:</b>		
<b>Name of Primary Owner (PO):</b> Doddridge County Board of Education		
<b>PO Address:</b> 68 Bulldog Drive		
<b>City:</b> West Union	<b>State:</b> WV	<b>Zip:</b> 26456
<b>PO Primary Phone:</b> 304-873-2300		
<b>PO Secondary Phone:</b> 317-716-3555		
<b>PO Primary Email:</b> jtharvey@k12.wv.us		

<b>Surface Rights Owner Data:</b>		
<b>Name of Primary Owner (PO):</b> Doddridge County Board of Education		
<b>PO Address:</b> 68 Bulldog Drive		
<b>City:</b> West Union	<b>State:</b> WV	<b>Zip:</b> 26456
<b>PO Primary Phone:</b> 304-873-2300		
<b>PO Secondary Phone:</b> 317-716-3555		
<b>PO Primary Email:</b> jtharvey@k12.wv.us		

<b>Mineral Rights Owner Data: (As Applicable)</b>		
<b>Name of Primary Owner (PO):</b>		
<b>PO Address:</b>		
<b>City:</b>	<b>State:</b>	<b>Zip:</b>
<b>PO Primary Phone:</b>		
<b>PO Secondary Phone:</b>		
<b>PO Primary Email:</b>		

Doddridge County Commercial/Industrial  
Floodplain Development Permit Application

**Contractor Data:**

*Please provide all pertinent data for contractors and sub---contractors that may be participating in this project. Use additional copies of this page as needed. Designate each page in relation to each property listed above.*

**Property Designation:** \_\_\_ of \_\_\_

<b>Contractor/Sub-Contractor (C/SC) Information:</b>		
C/SC Company Name: bidding project - contractor unknown at this time		
C/SC WV License Number:		
C/SC FEIN:	C/SC DUNS:	
Local C/SC Point of Contact (POC):		
Local C/SC POC Title:		
C/SC Mailing Address:		
City:	State:	Zip-Code:
Local C/SC Office Phone:		
Local C/SC POC Phone:		
Local C/SC POC E-Mail:		

<b>Engineer Firm Information:</b>		
Engineer Firm Name: The Thrasher Group, Inc		
Engineer WV License Number: 015621		
Engineer Firm FEIN: 55-0633596	Engineer Firm DUNS:	
Engineer Firm Primary Point of Contact (POC): Jeff Gola		
Engineer Firm Primary POC Title: Project Manager		
Engineer Firm Mailing Address: 600 White Oaks Blvd.		
City: Bridgeport	State: WV	Zip-Code: 26330
Engineer Firm Office Phone: 304-624-4108		
Engineer Firm Primary POC Phone: 304-326-6109		
Engineer Firm Primary POC E-Mail: jgola@thethrashergroup.com		

### Adjacent and/or Affected Landowners Data

Please provide data for all adjacent and/or affected surface owners (both up and down stream) whose property may be impacted by proposed development as demonstrated by a floodplain study or survey. Use additional copies of this page as needed.

<b>Adjacent Property Owner Data: Upstream</b>		
Name of Primary Owner (PO): Earl R. Daugherty		
Physical Address: Off Rt. 50		
City: West Union	State: WV	Zip: 26456
PO Primary Phone:		
PO Secondary Phone:		
PO Primary Email:		

<b>Adjacent Property Owner Data: Upstream</b>		
Name of Primary Owner (PO): Town of West Union		
Physical Address: 178 Court Street		
City: West Union	State: WV	Zip: 26456
PO Primary Phone: 304-873-4200		
PO Secondary Phone:		
PO Primary Email:		

<b>Adjacent Property Owner Data: Downstream</b>		
Name of Primary Owner (PO): Town of West Union		
Physical Address: 178 Court Street		
City: West Union	State: WV	Zip: 26456
PO Primary Phone: 304-873-4200		
PO Secondary Phone:		
PO Primary Email:		

<b>Adjacent Property Owner Data: Downstream</b>		
Name of Primary Owner (PO): James L. McAfee		
Physical Address: 13 Deer Lane		
City: West Union	State: WV	Zip: 26456
PO Primary Phone: 304-873-2192		
PO Secondary Phone:		
PO Primary Email:		

## Site Plan

**A Site Plan is an accurate and detailed map of the proposed development for this project.** It shows the size, shape, location and special features of the project property, and the size and location of any development planned to the property, especially as that development will impact the floodplain and/or floodway. Site plans show what currently exists on the project property, and any changes or improvements you are proposing to make. **A certified and licensed engineering firm should complete site plans.**

### **A SITE PLAN MUST CONTAIN THE FOLLOWING INFORMATION:**

1. Legal description of the parcel, north arrow and scale
2. All property lines and their dimensions
3. Names of adjacent roads, location of driveways
4. Location of sloughs, tributaries, streams, rivers, wetlands, ponds, and lakes, with setbacks indicated, and including FEMA floodplain data based on most updated FIRM.
5. Location, size, shape of all buildings, existing and proposed, with elevation of lowest floor indicated.
6. Location and dimensions of existing or proposed on-site sewage systems.
7. Location of all propane tanks, fuel tanks or other liquid storage tanks whether above ground or below ground level.
8. Location and dimensions of any proposed pipeline placement(s) into floodplain/floodway.
9. Location and dimensions of any roadway development into floodplain/floodway. *(Includes initial development access roads)*
10. Location and dimensions of any bridge and/or culvert development into floodplain/floodway.
11. Location and dimensions of any storage yard or facility into the floodplain/floodway.
12. Location of any existing utilities and/or proposed utility placement and/or displacement.
13. Location, dimensions and depth of any existing or proposed fill on site.
14. A survey showing the **existing ground elevations** of at least location on the building site. **ELEVATION NOTE:** All vertical datum will reference either NGVD 29 or NAVD 88. Assumed datum will not be acceptable unless the property is located in an area where vertical datum has not been published. For those areas where vertical datum has not been established, a site plan with contours, elevations using assumed datum, high water marks and existing water levels of sloughs, rivers, lakes or streams and proposed lowest floor elevation.



## Applicant

Please read print name, sign and date below:

- I certify that I am authorized to submit this application for the primary project developer.
- I certify that the information included in this application is to the best of my knowledge true and complete.
- I certify that all required Federal, State, and local permits required by law and/or ordinance for the above described development of this project have will be properly attained, are current and valid, and must be presented prior to a Doddridge County Floodplain Permit being issued.
- I understand that if in the course of the development project additional permits become required that were not needed during the initial proposal, the primary developer must notify the Doddridge County Floodplain Manager within 48 hours of such need, and that a "Stop Work" order may be issued for all project work directly impacting the floodplain or floodway, until such time the required additional permits are acquired.
- I understand that once the floodplain permit is submitted, the application will be entered into official public record at the next regularly scheduled Doddridge County Commission meeting after the date of submittal.
- I understand that from the date of submittal of the fully completed permit application, the Doddridge County Floodplain Manager has ninety (90) days to make a determination to either grant or deny said permit application. During this approval period, the Doddridge County Floodplain Manager may, at his or her discretion, conduct a review and/or additional study of provided documentation by means of an independent engineering firm. All costs associated with said review and/or study must be reimbursed to the County before issuance of approved permit.
- I understand that during the approval period, the Doddridge County Floodplain Manager of designee may at his or her discretion conduct site visits and document conditions of proposed development pursuant to the permit application.
- I understand that once the Floodplain Permit is granted, the permit will be entered into official public record. Appeals to the permit may be made no later than twenty (20) days after said issuance. If a valid appeal is submitted, as determined by the Doddridge County Floodplain Manager, a "Stop Work" order will be issued for all project development directly involving the floodplain or floodway. A public hearing by the Doddridge County Appeals Board will be scheduled no less than ten (10) days after the next regularly scheduled Doddridge County Commission meeting.
- I understand that all decisions of the Doddridge County Appeals Board shall be final.
- **I understand issuance of a Floodplain Permit authorizes me to proceed with construction as proposed.**
- In signing this application, the primary developer hereby grants the Doddridge County Floodplain Manager or designee the right to enter onto the above---described location to inspect the development work proposed, in progress, and/or completed.
- I understand that if I do not follow exactly the site---plan submitted and approved by this permit that a "Stop Work" order may be issued by the Doddridge County Floodplain Manager and that I must stop all construction immediately until discrepancies of actual work vs. proposed work is resolved.

Applicant Signature: \_\_\_\_\_

Date: \_\_\_\_\_

Applicant Printed Name: \_\_\_\_\_

**STREAM CROSSING &  
FLOODPLAIN ANALYSIS**

**DODDRIDGE COUNTY BOARD OF EDUCATION  
EARLY CHILDHOOD ACADEMY**


**MIDDLE ISLAND CREEK  
DODDRIDGE COUNTY, WEST VIRGINIA**

**PREPARED FOR:**

DODDRIDGE COUNTY BOARD OF EDUCATION

**PREPARED BY:**

THE THRASHER GROUP, INC.  
600 White Oaks Blvd  
Bridgeport, WV 26330

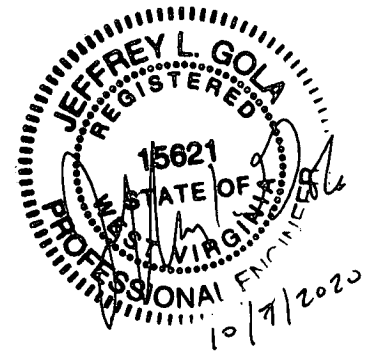

**OCTOBER 2020**

**DODDRIDGE COUNTY BOARD OF EDUCATION  
DODDRIDGE COUNTY, WV**

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2	HEC-RAS CROSS SECTIONS
3	SITE PLAN

**DODDRIDGE COUNTY BOARD OF EDUCATION  
DODDRIDGE COUNTY, WEST VIRGINIA**

**1.0 PROJECT DESCRIPTION**

The Thrasher Group has been contracted by the Doddridge County Board of Education (DCBOE) to perform a hydrologic and hydraulic (H&H) study for the development of a new Pre-K, also known as the "Project". The Project is located on property owned by the Doddridge County Board of Education located off State Route 18 within a 0.25 mile of US Route 50. (Lat.39°17'21.75", Long.80°46'11.37") The Project site will be constructed in the location of the old football and baseball field of Doddridge County High School. The project will consist of the construction of a new two-lane single span bridge that will cross Middle Island Creek and serve as the main entrance/exit of the school. The existing bridge downstream that is now used to serve the property will be demoed. The site will be graded raising the Pre-K out of the 100-year storm by excavating cut material from the northern hillside on the property and hauling it to the Pre-K building pad. The finish floor of the new structure will sit at 786.5, approximately 6.5 feet above the 100-year base flood plain.

**2.0 HYDROLOGY ANALYSIS**

A hydrology study was not performed since FEMA's Flood Insurance Study provided flows for Middle Island Creek. According to the study, Middle Island Creek 0.1 miles downstream of confluence of Piggin Run peak 1-percent discharge was used for this study.

**3.0 HYDRAULIC ANALYSIS**

The hydraulic analysis was performed using HEC-RAS 5.0.7 and the hydrologic information provided by FEMA's Doddridge County Flood Insurance Study (F.I.S.) 2011. A known water surface elevation of 779' was used for the program's boundary condition since the stream is in a FEMA designated zone "AE". The Stream and floodplain roughness coefficients used in the analysis were also described in the F.I.S as listed below.

Channel	0.04	clean, winding, some pools and shoals
Floodplain	0.07	medium to dense brush (left overbank)
	0.03	short grass (right overbank)
	0.035	high grass (right overbank)

The surrounding area of the Project was surveyed by The Thrasher Group in April 2020. Cross sections were created along the centerline of the stream and inserted into HEC-RAS. Field measurements of the existing bridge were inputted into the program to accurately depict existing conditions. Subsequently, a hydraulic model was produced to analyze the effect of the Project.

#### **4.0 CONCLUSION**

The results of the hydraulic model indicate that the proposed project produces no adverse effects on the stream and is within the standards of FEMA. By installing the new single span bridge at a higher elevation up stream of the existing bridge and demoing the existing bridge, the 1-year storm in that area would decrease by 0.04' between the new proposed fill and the existing dam. However, the position of the proposed fill for the new structure and parking lot will cause a slight increase the base flood of elevation of 0.06', well below the 1 ft increase allowed by FEMA in the floodplain. Therefore, the proposed project produces no adverse effects on the stream and is within the standards of FEMA.

**APPENDIX 1**  
**HEC-RAS SUMMARY TABLES**



HEC-RAS River: Middle Island Cr Reach: MIDDLE ISLAND CR Profile: PF 1 (Continued)

Reach	River Sta	Profile	Plan	Q Total (cfs)	Min Ch El (ft)	W.S. Elev (ft)	Crit W.S. (ft)	E.G. Elev (ft)	E.G. Slope (ft/ft)	Vel Chnl (ft/s)	Flow Area (sq ft)	Top Width (ft)	Froude # Chl
MIDDLE ISLAND CR	1033.84	PF 1	EX	13080.00	760.00	779.00	770.39	779.97	0.001226	8.04	1798.14	147.64	0.34
MIDDLE ISLAND CR	1033.84	PF 1	PRO	13080.00	760.00	779.00	770.39	779.97	0.001226	8.04	1798.14	147.64	0.34




**APPENDIX 2**  
**HEC-RAS CROSS-SECTIONS**

**APPENDIX 3**

**SITE PLANS**



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CONTRACT No.	
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 BRIDGEPORT WV 26330  
 www.thrashereng.com  
 PHONE (304) 624-4108 FAX (304) 624-7831
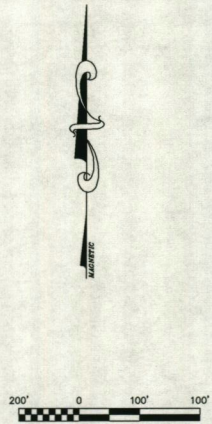
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CONTRACT No.	
PROJECT No.	

**DODDRIDGE COUNTY BOARD OF EDUCATION**  
**DODDRIDGE COUNTY, WEST VIRGINIA**  
**HEC-RAS MODEL X-SECTIONS**

SHEET No.	<b>1</b>
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CONTRACT No.	
PROJECT No.	60-10159

EARLY CHILDHOOD ACADEMY SITE GRADING  
 BOARD OF EDUCATION  
 DODDRIDGE COUNTY, WEST VIRGINIA  
 GRADING PLAN

SHEET No.  
**3**

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NO.	BY	DATE	DESCRIPTION																		

# WV Flood Map



This map is not the official regulatory FIRM or DFIRM. Its purpose is to assist with determining potential flood risk for the selected location.

H I G H  R I S K		1-Percent-Annual-Chance Flood Hazard Area <b>With Base Flood Elevation (BFE)</b>	☉ Flood Info Location <span style="float: right;"><i>Map created on 10/8/2020</i></span> <b>User Notes</b>
		Regulatory <b>Floodway</b> in AE Zone	
		1-Percent-Annual-Chance Flood Hazard Area <b>Without BFE</b> (may have Advisory Flood Heights)	<b>Flood Hazard Area</b> Location is <b>NOT WITHIN</b> any identified flood hazard area. Unmapped flood hazard areas may be present. <b>Flood Zone</b> Out of Flood Zone
		1-Percent-Annual-Chance <b>High Risk Advisory</b>	<b>Stream</b> <b>Watershed (HUC8)</b> Little Musringum-Middle Island (5030201)
Download the Full Legend for all flood tool symbols <a href="https://www.mapwv.gov/flood/map/docs/wv_flood_tool_legend.pdf">https://www.mapwv.gov/flood/map/docs/wv_flood_tool_legend.pdf</a>			<b>Flood Height</b> <b>Water Depth</b> About 10.0 ft (Source: HAZUS) <b>Elevation</b> 777.7 ft (Source: SAMS 2003) (NAVD88)
<b>Disclaimer:</b> The online map is for use in administering the National Flood Insurance Program. It does not necessarily identify all areas subject to flooding, particularly from local drainage sources of small size. Refer to the official Flood Insurance Study (FIS) for detailed flood elevation data in flood profiles and data tables. WV Flood Tool ( <a href="https://www.mapwv.gov/flood">https://www.mapwv.gov/flood</a> ) is supported by FEMA, WV NFIP Office, and WV GIS Technical Center.			<b>Community &amp; ID</b> Doddridge County (ID: 540024) <b>FEMA Map &amp; Date</b> 54017C0120C; Effective Date: 10/4/2011 <b>Location (lat, long)</b> (39.289528, -80.770311) (WGS84) <b>Parcel ID</b> 09-08-0011-0077-0000 <b>E-911 Address</b> multiple addresses

**STREAM CROSSING &  
FLOODPLAIN ANALYSIS**

**DODDRIDGE COUNTY BOARD OF EDUCATION  
EARLY CHILDHOOD ACADEMY**


**MIDDLE ISLAND CREEK  
DODDRIDGE COUNTY, WEST VIRGINIA**

**PREPARED FOR:**

DODDRIDGE COUNTY BOARD OF EDUCATION

**PREPARED BY:**

THE THRASHER GROUP, INC.  
600 White Oaks Blvd  
Bridgeport, WV 26330

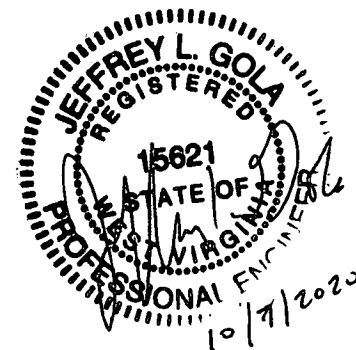

**OCTOBER 2020**

**DODDRIDGE COUNTY BOARD OF EDUCATION  
DODDRIDGE COUNTY, WV**

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1	HEC-RAS SUMMARY TABLE
2	HEC-RAS CROSS SECTIONS
3	SITE PLAN



**DODDRIDGE COUNTY BOARD OF EDUCATION  
DODDRIDGE COUNTY, WEST VIRGINIA**

**1.0 PROJECT DESCRIPTION**

The Thrasher Group has been contracted by the Doddridge County Board of Education (DCBOE) to perform a hydrologic and hydraulic (H&H) study for the development of a new Pre-K, also known as the "Project". The Project is located on property owned by the Doddridge County Board of Education located off State Route 18 within a 0.25 mile of US Route 50. (Lat.39°17'21.75", Long.80°46'11.37") The Project site will be constructed in the location of the old football and baseball field of Doddridge County High School. The project will consist of the construction of a new two-lane single span bridge that will cross Middle Island Creek and serve as the main entrance/exit of the school. The existing bridge downstream that is now used to serve the property will be demoed. The site will be graded raising the Pre-K out of the 100-year storm by excavating cut material from the northern hillside on the property and hauling it to the Pre-K building pad. The finish floor of the new structure will sit at 786.5, approximately 6.5 feet above the 100-year base flood plain.

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A hydrology study was not performed since FEMA's Flood Insurance Study provided flows for Middle Island Creek. According to the study, Middle Island Creek 0.1 miles downstream of confluence of Piggin Run peak 1-percent discharge was used for this study.

**3.0 HYDRAULIC ANALYSIS**

The hydraulic analysis was performed using HEC-RAS 5.0.7 and the hydrologic information provided by FEMA's Doddridge County Flood Insurance Study (F.I.S.) 2011. A known water surface elevation of 779' was used for the program's boundary condition since the stream is in a FEMA designated zone "AE". The Stream and floodplain roughness coefficients used in the analysis were also described in the F.I.S as listed below.

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Floodplain	0.07	medium to dense brush (left overbank)
	0.03	short grass (right overbank)
	0.035	high grass (right overbank)

The surrounding area of the Project was surveyed by The Thrasher Group in April 2020. Cross sections were created along the centerline of the stream and inserted into HEC-RAS. Field measurements of the existing bridge were inputted into the program to accurately depict existing conditions. Subsequently, a hydraulic model was produced to analyze the effect of the Project.

#### **4.0 CONCLUSION**

The results of the hydraulic model indicate that the proposed project produces no adverse effects on the stream and is within the standards of FEMA. By installing the new single span bridge at a higher elevation up stream of the existing bridge and demoing the existing bridge, the 1-year storm in that area would decrease by 0.04' between the new proposed fill and the existing dam. However, the position of the proposed fill for the new structure and parking lot will cause a slight increase the base flood of elevation of 0.06', well below the 1 ft increase allowed by FEMA in the floodplain. Therefore, the proposed project produces no adverse effects on the stream and is within the standards of FEMA.

**APPENDIX 1**  
**HEC-RAS SUMMARY TABLES**



HEC-RAS River: Middle Island Cr Reach: MIDDLE ISLAND CR Profile: PF 1 (Continued)

Reach	River Sta	Profile	Plan	Q Total (cfs)	Min Ch El (ft)	W.S. Elev (ft)	Crit W.S. (ft)	E.G. Elev (ft)	E.G. Slope (ft/ft)	Vel Chnl (ft/s)	Flow Area (sq ft)	Top Width (ft)	Froude # Chl
MIDDLE ISLAND CR	1033.84	PF 1	EX	13080.00	760.00	779.00	770.39	779.97	0.001226	8.04	1798.14	147.64	0.34
MIDDLE ISLAND CR	1033.84	PF 1	PRO	13080.00	760.00	779.00	770.39	779.97	0.001226	8.04	1798.14	147.64	0.34

**APPENDIX 2**  
**HEC-RAS CROSS-SECTIONS**

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PROJECT No.

**DODDRIDGE COUNTY BOARD OF EDUCATION**  
**DODDRIDGE COUNTY, WEST VIRGINIA**  
**HEC-RAS MODEL X-SECTIONS**

SHEET No.  
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**APPENDIX 3**

**SITE PLANS**



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PHASE No.	
CONTRACT No.	
PROJECT No.	60-10159

**DODDRIDGE EARLY CHILDHOOD ACADEMY  
 BOARD OF EDUCATION  
 DODDRIDGE COUNTY, WEST VIRGINIA  
 SITE LAYOUT**

SHEET No. **X**

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PHASE No.
CONTRACT No.
PROJECT No.
<b>60-10159</b>

**EARLY CHILDHOOD ACADEMY SITE GRADING  
 DODDRIDGE COUNTY, WEST VIRGINIA  
 GRADING PLAN**

### 3.1 Hydrologic Analyses

Hydrologic analyses were carried out to establish the peak discharge-frequency relationships for each flooding source studied in detail affecting the county.

Discharge-frequency curves were developed on a regional basis that applies to West Virginia (References 3 and 4). For the streams studied by detailed methods, 1-percent-annual-chance flood elevations were determined through discharge-frequency relations and the Manning equation. Within the Town of West Union, flood elevations were determined through streamflow-station data relationships and the Manning's equation.

Peak discharge-drainage area relationships for each stream studied by detailed methods are presented in Table 2, "Summary of Discharges".

**Table 2 – Summary of Discharges**

<u>FLOODING SOURCE AND LOCATION</u>	<u>DRAINAGE AREA (SQ. MILES)</u>	<u>PEAK DISCHARGE (CFS) 1-PERCENT-ANNUAL- CHANCE</u>
<b>MIDDLE ISLAND CREEK</b>		
Upstream of Doddridge-Tyler County boundary	134.78	15,200
<u>(Approximately 0.1 mile downstream of confluence of Piggan Run)</u>	<u>(120.06)</u>	<u>(13,080)</u>
<b>BUCKEYE CREEK</b>		
At confluence with Middle Island Creek	38.62	7,350
Downstream of confluence of Long Run	22.62	5,150
Upstream of confluence of Greenbrier Creek	9.41	3,050
Downstream of confluence of Traugh Fork	1.52	1,310
<b>MEATHOUSE FORK</b>		
At confluence with Middle Island Creek	66.84	9,600
Downstream of confluence of Toms Fork	50.47	8,200
Downstream of confluence of Brushy Fork	29.87	6,050
Downstream of confluence of Laurel Run and Big Isaac Creek	3.76	2,230
<b>MCELROY CREEK</b>		
Upstream of confluence of Flint Run	61.95	9,250
Upstream of confluence of Rigging Run	51.23	8,300
Downstream of confluence of Talkington Fork	39.18	7,100
Downstream of confluence of Robinson Fork and Big Battle Run	20.75	4,900

using the USACE HEC-2 step-backwater computer program, and the results were published in a special flood hazard information report (References 5 and 6). Flood profiles were drawn showing computed water-surface elevations for floods of the selected recurrence intervals.

Channel roughness factors (Manning's "n") used in the hydraulic computations were assigned on the basis of field surveys of the stream and floodplain areas. For Middle Island Creek, channel "n" values range from 0.040 to 0.045 and overbank "n" values range from 0.050 to 0.070. For Buckeye Creek and Meathouse Fork, channel "n" values range from 0.055 to 0.080.

The hydraulic analyses for this study were based on unobstructed flow. The flood elevations shown on the profiles are thus considered valid only if hydraulic structures remain unobstructed, operate properly, and do not fail.

Qualifying benchmarks within a given jurisdiction that are catalogued by the National Geodetic Survey (NGS) and entered into the National Spatial Reference System (NSRS) as First or Second Order Vertical and have a vertical stability classification of A, B or C are shown and labeled on the FIRM with their 6-character NSRS Permanent Identifier.


Benchmarks catalogued by the NGS and entered into the NSRS vary widely in vertical stability classification. NSRS vertical stability classifications are as follows:

- Stability A: Monuments of the most reliable nature, expected to hold position/elevation (e.g. mounted in bedrock)
- Stability B: Monuments which generally hold their position/elevation (e.g. concrete bridge abutment)
- Stability C: Monuments which may be affected by surface ground movements (e.g. concrete monument below frost line)
- Stability D: Mark of questionable or unknown vertical stability (e.g. concrete monument above frost line, or steel witness post)

In addition to NSRS benchmarks, the FIRM may also show vertical control monuments established by a local jurisdiction; these monuments will be shown on the FIRM with the appropriate designations. Local monuments will only be placed on the FIRM if the community has requested that they be included, and if the monuments meet the aforementioned NSRS inclusion criteria.

To obtain current elevation, description, and/or location information for benchmarks shown on the FIRM for this jurisdiction, please contact the Information Services Branch of the NGS at (301) 713-3242, or visit their Web site at [www.ngs.noaa.gov](http://www.ngs.noaa.gov).

It is important to note that temporary vertical monuments are often established during the preparation of a flood hazard analysis for the purpose of establishing local vertical control. Although these monuments are not shown on the FIRM, they may be found in the Technical Support Data Notebook associated with the FIS report and FIRM for this community. Interested individuals may contact FEMA to access these data.

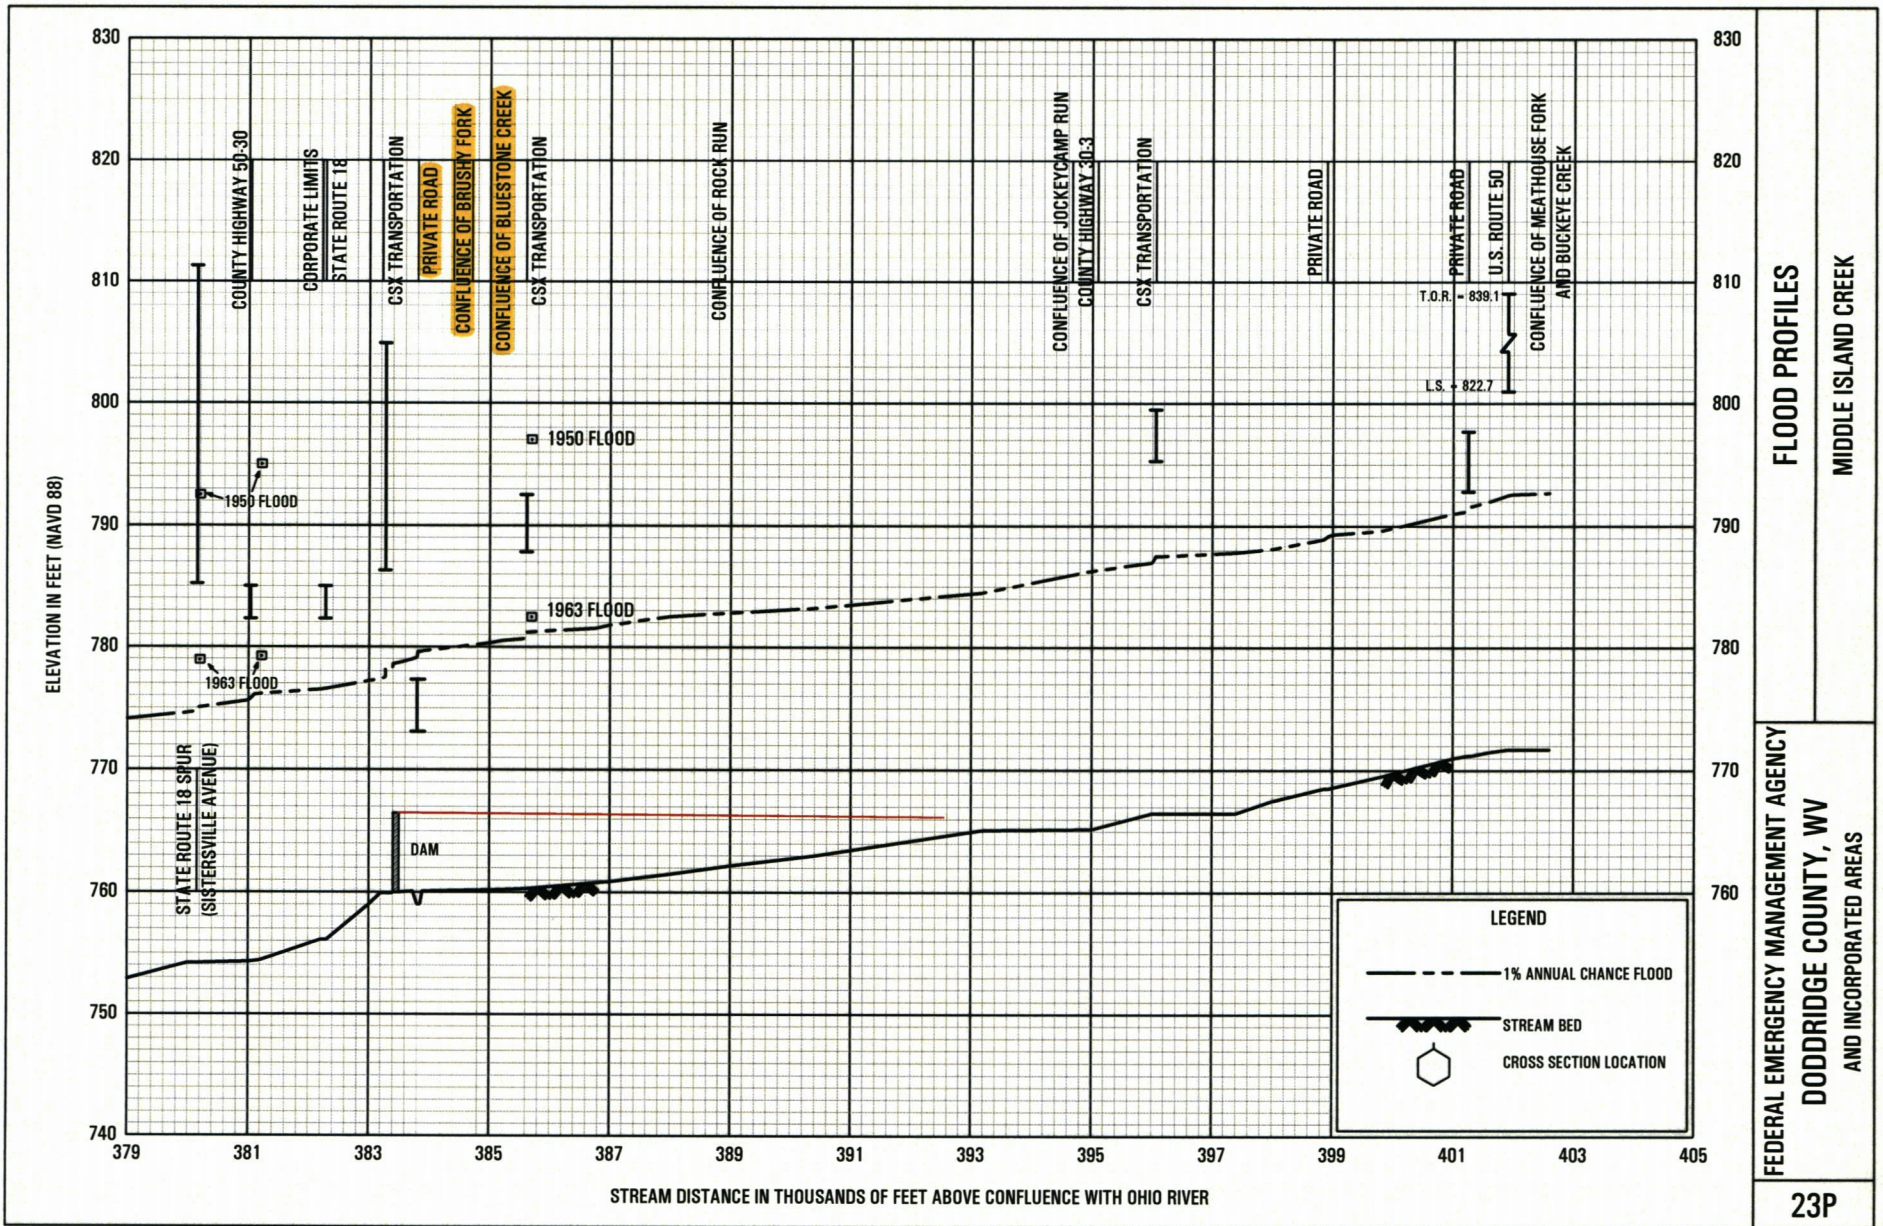

**FLOOD PROFILES**  
MIDDLE ISLAND CREEK

FEDERAL EMERGENCY MANAGEMENT AGENCY  
DODDRIDGE COUNTY, WV  
AND INCORPORATED AREAS



George Eidel &lt;doddridgecountyfpm@gmail.com&gt;

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**Doddridge Co. Early Childhood Academy**

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Jeffrey Gola <jgola@thethrasher.com>  
To: George Eidel <doddridgecountyfpm@gmail.com>

Tue, Oct 13, 2020 at 8:50 AM

Thanks George,

I forgot to attach the NPDES permit. It would it be an issue if constructed a sediment trap and rock stone entrance. Neither would be filling in the floodplain, just digging out to catch any sediment?

thanks

**JEFFREY GOLA, PE**

Project Manager | The Thrasher Group, Inc.

**office:** 304-326-6109 | 800-273-6541**mobile:** 304-677-9830

600 White Oaks Blvd | Bridgeport, WV 26330

**www.thethrasher.com**

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**From:** George Eidel <doddridgecountyfpm@gmail.com>  
**Sent:** Monday, October 12, 2020 4:45 PM  
**To:** Jeffrey Gola <jgola@thethrasher.com>  
**Subject:** Re: Doddridge Co. Early Childhood Academy

**CAUTION: External E-mail**

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 **Approval for WVR111011.pdf**  
38K



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west virginia department of environmental protection

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Division of Waster and Water Management  
601 57th Street SE  
Charleston West Virginia 25304-2345  
Phone: 304-926-0495  
Fax: 304-926-0496

Austin Caperton, Cabinet Secretary  
dep.wv.gov

October 8, 2020

DODDRIDGE COUNTY BOARD OF EDUCATION  
JEFF HARVEY  
68 BULLDOG DRIVE  
WEST UNION, WV 26456

Re: General Permit Registration No. WVR111011  
Early Childhood Academy  
Acres Permitted (10)

Dear Permittee:

You are now authorized to operate under General Permit No. WV0115924 to discharge stormwater associated with construction activities. This registration form should be kept with your copy of the General Permit. You should carefully read the contents of the permit and become familiar with all requirements needed to remain in compliance.

Although you should be aware of all the terms and conditions of this permit, we wish to advise you of the following important requirements:

1. In accordance with the General Permit, you have developed a complete storm water pollution prevention plan. This plan is to be retained on site and be available for review by the Director or the Director's authorized representative as of the date of your coverage by the General Permit, which is the date of this letter.

2. The erosion control measures approved by this Agency for this project shall be maintained in proper condition to individually and collectively perform the functions for which they were designed. In order to ensure the efficiency and proper maintenance of these measures, the permittee shall make sufficiently frequent, periodic inspections to detect any impairment of the designed stability, capacity or environmental requirements of the approved measures. The permittee shall take immediate steps to correct any such impairment found to exist.

3. If this Storm Water Pollution Prevention Plan (SWPPP) proves to be ineffective in controlling erosion and the sediment in storm water discharges associated with industrial/construction activities, or site conditions change, the Permittee shall amend the

Promoting a healthy environment.

SWPPP and install appropriate sediment and/or control devices in accordance with this permit and the application instructions

4. Final stabilization means disturbed areas shall be covered by the appropriate permanent protection. Final stabilization includes pavement; compacted gravel; permeable pavement/pavers; buildings; stable waterways (riprap, concrete, grass or pipe); a healthy, vigorous stand of perennial grass that uniformly covers at least 70 percent of the ground; stable outlet channels with velocity dissipation which directs site runoff to a natural watercourse; and any other approved structure or material.

Your project has not been public noticed therefore this permit registration is valid from 10/8/2020 till 10/8/2021.

You will be invoiced for your annual permit fees one month prior to the anniversary date of your original approval date. Failure to submit the annual fee within 90 days of the due date will render your permit void upon the date you are mailed a certified written notice to that effect.

Issuance of this registration does not authorize any injury to persons or property or invasion of other private rights, or any infringement of federal, state or local law or rules.

The validity of this General Permit Registration is contingent upon payment of the applicable annual permit fee, as required by Chapter 22, Article 11, Section 10 of the Code of West Virginia.

Your efforts toward preventing the degradation of our natural resources are greatly appreciated. If you have any questions relative to this approval, please do not hesitate to contact **Dale Biller** at (304) 926-0499 Ext. **43766** or by email at [robert.d.biller@wv.gov](mailto:robert.d.biller@wv.gov).

Katheryn D. Emery  
Acting Director  
WV DEP-Division of Water & Waste Mgt.  
601 57th St SE  
Charleston, WV 25304-2345  
Phone: (304) 926-0495  
Fax: (304) 926-0463





George Eidel &lt;doddridgecountyfpm@gmail.com&gt;

---

**Floodplain Permit for New Bridge**

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Jeffrey Gola <jgola@thethrashergroup.com>  
To: George Eidel <doddridgecountyfpm@gmail.com>

Fri, Oct 30, 2020 at 9:24 AM

Thanks George,

I just waiting on the WVDOH D4 to give me the MM109 permit. I talked to them yesterday and should be coming soon. Attached is the WVDEP permit. For the construction of the new bridge and site grading, neither a Corps or WVDNR permit will be needed.

Thanks again for your assistance.

**JEFFREY GOLA, PE**

Project Manager | The Thrasher Group, Inc.

**office:** 304-326-6109 | 800-273-6541**mobile:** 304-677-9830

600 White Oaks Blvd | Bridgeport, WV 26330

**www.thethrashergroup.com**

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**From:** George Eidel <doddridgecountyfpm@gmail.com>  
**Sent:** Friday, October 30, 2020 9:15 AM  
**To:** Jeffrey Gola <jgola@thethrashergroup.com>  
**Subject:** Floodplain Permit for New Bridge

**CAUTION: External E-mail**

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 **Approval for WVR111011.pdf**  
38K



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west virginia department of environmental protection

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Division of Waster and Water Management  
601 57th Street SE  
Charleston West Virginia 25304-2345  
Phone: 304-926-0495  
Fax: 304-926-0496

Austin Caperton, Cabinet Secretary  
dep.wv.gov

October 8, 2020

DODDRIDGE COUNTY BOARD OF EDUCATION  
JEFF HARVEY  
68 BULLDOG DRIVE  
WEST UNION, WV 26456

Re: General Permit Registration No. WVR111011  
Early Childhood Academy  
Acres Permitted (10)

Dear Permittee:

You are now authorized to operate under General Permit No. WV0115924 to discharge stormwater associated with construction activities. This registration form should be kept with your copy of the General Permit. You should carefully read the contents of the permit and become familiar with all requirements needed to remain in compliance.

Although you should be aware of all the terms and conditions of this permit, we wish to advise you of the following important requirements:

1. In accordance with the General Permit, you have developed a complete storm water pollution prevention plan. This plan is to be retained on site and be available for review by the Director or the Director's authorized representative as of the date of your coverage by the General Permit, which is the date of this letter.

2. The erosion control measures approved by this Agency for this project shall be maintained in proper condition to individually and collectively perform the functions for which they were designed. In order to ensure the efficiency and proper maintenance of these measures, the permittee shall make sufficiently frequent, periodic inspections to detect any impairment of the designed stability, capacity or environmental requirements of the approved measures. The permittee shall take immediate steps to correct any such impairment found to exist.

3. If this Storm Water Pollution Prevention Plan (SWPPP) proves to be ineffective in controlling erosion and the sediment in storm water discharges associated with industrial/construction activities, or site conditions change, the Permittee shall amend the

Promoting a healthy environment.

SWPPP and install appropriate sediment and/or control devices in accordance with this permit and the application instructions

4. Final stabilization means disturbed areas shall be covered by the appropriate permanent protection. Final stabilization includes pavement; compacted gravel; permeable pavement/pavers; buildings; stable waterways (riprap, concrete, grass or pipe); a healthy, vigorous stand of perennial grass that uniformly covers at least 70 percent of the ground; stable outlet channels with velocity dissipation which directs site runoff to a natural watercourse; and any other approved structure or material.

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You will be invoiced for your annual permit fees one month prior to the anniversary date of your original approval date. Failure to submit the annual fee within 90 days of the due date will render your permit void upon the date you are mailed a certified written notice to that effect.

Issuance of this registration does not authorize any injury to persons or property or invasion of other private rights, or any infringement of federal, state or local law or rules.

The validity of this General Permit Registration is contingent upon payment of the applicable annual permit fee, as required by Chapter 22, Article 11, Section 10 of the Code of West Virginia.

Your efforts toward preventing the degradation of our natural resources are greatly appreciated. If you have any questions relative to this approval, please do not hesitate to contact **Dale Biller** at (304) 926-0499 Ext. **43766** or by email at [robert.d.biller@wv.gov](mailto:robert.d.biller@wv.gov).

Katheryn D. Emery  
Acting Director  
WV DEP-Division of Water & Waste Mgt.  
601 57th St SE  
Charleston, WV 25304-2345  
Phone: (304) 926-0495  
Fax: (304) 926-0463

**West Virginia Department of Transportation  
Division of Highways  
Right-of-way Encroachment Permit Application**

Form MM-109  
Rev. 12-9-2019

PERMIT NO. 04-2020-0849

PERMIT TO ENTER UPON, UNDER, OVER OR ACROSS THE STATE ROADS OF THE STATE OF WEST VIRGINIA.

THIS PERMIT, Made this 17 day of November 20 20, between the WEST VIRGINIA DEPARTMENT OF TRANSPORTATION, DIVISION OF HIGHWAYS, a statutory corporation hereinafter called DIVISION and Doddridge County Board of Education

Address: 68 Bulldog Drive, West Union, WV Phone No: 304-873-2300  
hereinafter called APPLICANT.

**WITNESSETH**

In consideration of the hereinafter set out covenants and in accordance with W. Va. Code §17-2E-1 *et seq.*, §17-4-8, §17-16-6, §17-16-9, §31H-1-1 *et seq.*, federal law, and the rules, policies, guidelines, manuals, and federal regulations promulgated thereunder, APPLICANT does hereby apply to enter

Route Type & No. WV 18 DOH Project No. - (if applicable);  
at 0.25mi north of the jct. of US 50 (-80.7716, 39.2892) Mile Post 19.00  
in Doddridge County, for the purposes hereinafter set forth and in accordance with the plans and specifications which are attached hereto and made a part hereof: \_\_\_\_\_

Construction and n aintenance of an access to a nev school location. Board of Education shall construct, ov n and n aintain the bridge at this location. Ren ove vegetation and n aintain visibility at the nev access.

APPLICANT further agrees to accept the conditions hereinafter set forth:

1. APPLICANT shall deposit with DIVISION the sum of \$ \_\_\_\_\_ - \_\_\_\_\_ in the form of an official, certified or cashier's check, or executed bond with surety satisfactory to DIVISION to cover any damage and inspection costs DIVISION may sustain by reason of the granting of this permit, including any expense incurred in restoring said highway to its original condition or the proper repair of any and all damages that may result within one (1) year from the date of the completion of said work.
2. APPLICANT agrees to reimburse DIVISION for inspection costs as follows:
  - A. For any inspection costs incurred under this permit.
  - B. At \$ \_\_\_\_\_ per linear foot for \_\_\_\_\_ feet of water line installed under this permit
  - C. At \$ \_\_\_\_\_ per linear foot for \_\_\_\_\_ feet of sewer line installed under this permit
3. APPLICANT shall notify DIVISION at least 48 hours in advance of the date the work will begin. Failure to comply will be cause for cancellation of this permit.
4. APPLICANT agrees to protect its employees, equipment and users of the highway at all times in accordance with the current Division of Highways manual "Traffic Control For Street and Highway Construction and Maintenance Operations".
5. APPLICANT agrees to comply with all applicable state and federal laws in the performance of work under this permit.



WEST VIRGINIA DEPARTMENT OF TRANSPORTATION

**Division of Highways**

Office of the District Engineer/Manager  
District Four

Byrd E. White, III  
Secretary of Transportation

PO Box 4220 (EXIT 121, I-79) \* Clarksburg, WV 26302 \* 304-842-1550  
December 4, 2020

BOARD OF EDUCATION, DODDRIDGE  
COUNTY  
68 BULLDOG DRIVE  
WEST UNION, WV 26456

Dear Applicant:

Your approved copy of Permit Number 04-2020-0849 for a AC - Approach Commercial

permit type is enclosed. A description of the work is on the permit.

Please contact the District Four office:

**304-326-0119**

at least 48 hours in advance of the date you plan to begin work so arrangements can be made to inspect the work authorized by the permit.

**Failure to comply will result in cancellation of your permit.**

A copy of this permit is to be available on the job at all times while the work is in progress for inspection by the West Virginia Division of Highways' personnel.

Sincerely,

*Michael Cronin*

District Engineer / District Manager

*Quarden*

Permit Supervisor

Initials: AS:MC:tc

Attachments: Yes

Enclosure: No

cc:OM 0409 MD file

6. Supplementary conditions cited below are understood and agreed to be a part hereof.

7. The work authorized under this permit shall be completed on or before (Date): 17th November 21

**I attest that I have not modified the terms of this document. All attachments are inclusive to this permit.**

Recommended by DOH Review

Applicant

Signature:

Title:

District Four Permits

Title:

Director, Student Support Services

**BOND REQUIREMENT:**

BOND

/DATE

Attached

On File

INSPECTION:

Owner/Consultant

Full Time

Part Time

Periodic

Reimbursable

No Cost

APPROVED:

Title:

Acting Maintenance Engineer

West Virginia Division of Highways

AUTHORIZATION


PERMIT

04-2020-0849

**SUPPLEMENTARY CONDITIONS**

1. The person, firm or corporation to whom a permit is issued agrees to hold the State of West Virginia and DIVISION harmless on account of any damages to persons or property which may arise during the process of the work authorized by this permit or by reason thereof.
2. Applications for permission to perform work within highway rights of way shall be made on DIVISION'S standard permit form and shall be signed by the authorized representative of the person, firm or corporation applying.
3. The APPLICANT shall give detailed information concerning the work to be performed and the application must include a sketch sufficient to show the nature of the work performed.
4. APPLICANT, his agents, successor, heirs or assigns, contractors or any other person, firm or corporation working under APPLICANT'S real or apparent authority, shall perform the work in a manner satisfactory to DIVISION. Damage to the road resulting at any time from work authorized under this permit shall be repaired by APPLICANT. Unsatisfactory repairs may be corrected by DIVISION or its authorized agent and the cost thereof paid by APPLICANT.
5. DIVISION assumes no liability for damage to the proposed work by reason of construction or maintenance work on the road.
6. This permit is granted subject to removal of the authorized installation by APPLICANT at no cost to DIVISION when required for improvement of the road, and subject to all regulations now or hereafter adopted by DIVISION.
7. Utility installation shall be in accordance with the current manual, "Accommodation of Utilities on Highway Right of Way".
8. Driveways shall be in accordance with the current manual, "Rules and Regulations for Constructing Driveways on State Highway Rights-of-Way."
9. DIVISION reserves the right to cancel this permit at any time, should APPLICANT fail to comply with the terms and conditions under which it is granted.
10. This permit is granted only insofar as the DIVISION has a right to do so.




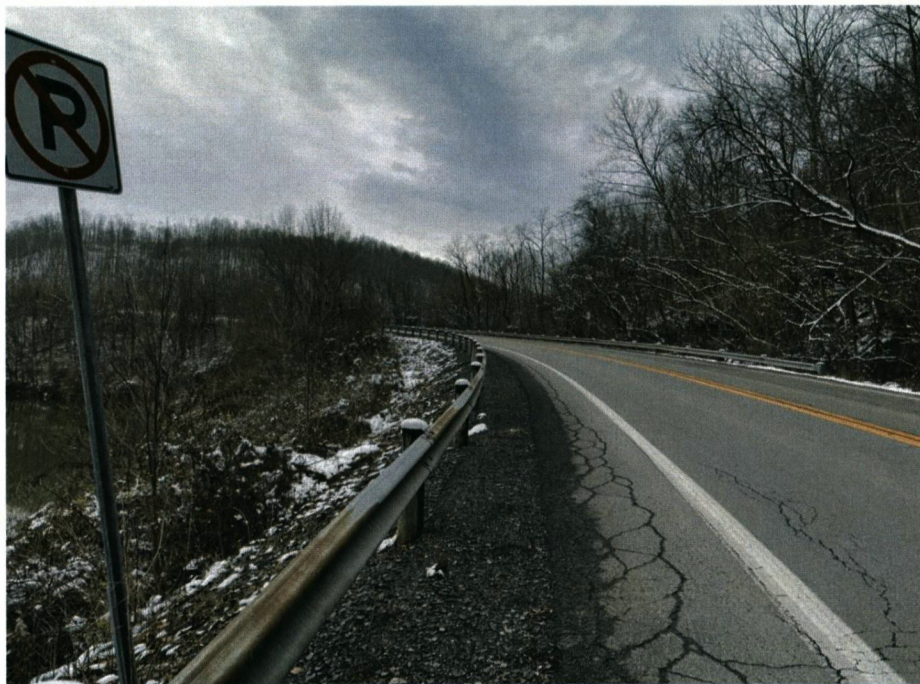








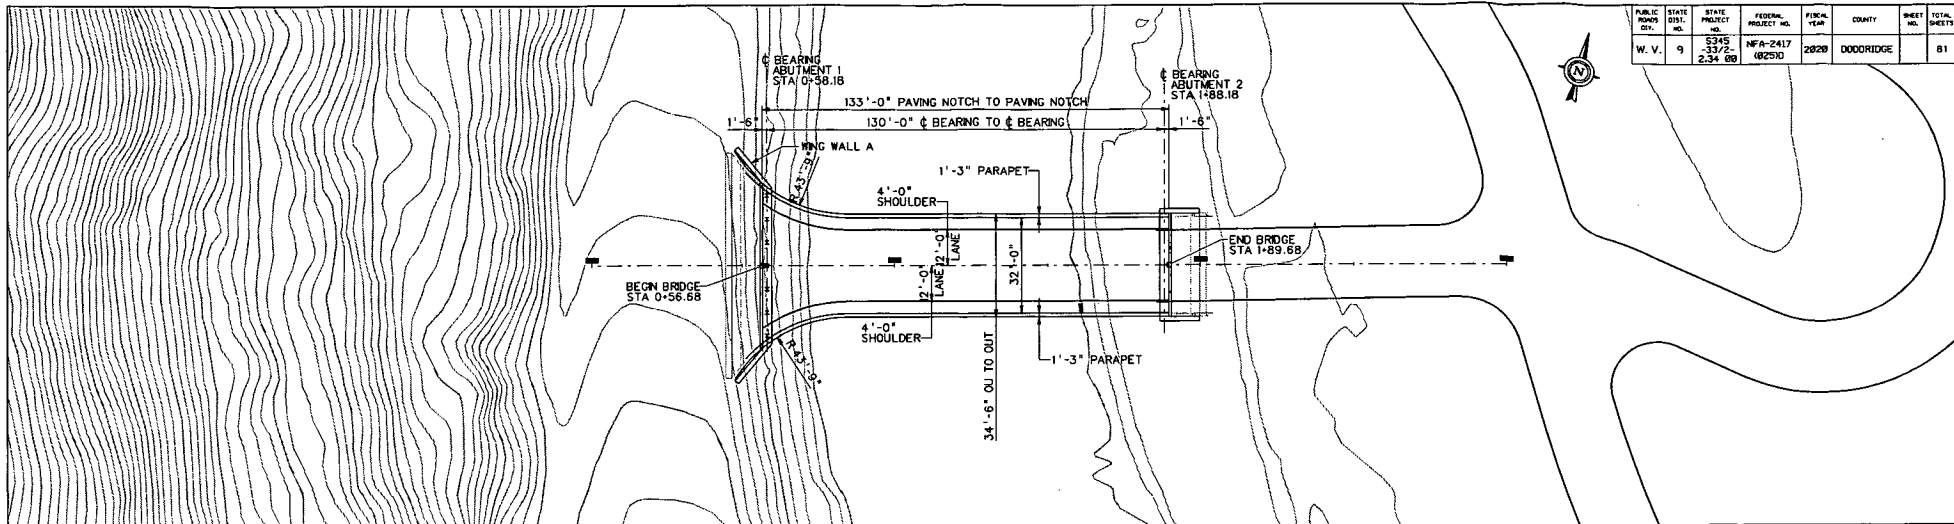

PUBLIC WORKS DIST.	STATE DIST. NO.	STATE PROJECT NO.	FEDERAL PROJECT NO.	FISCAL YEAR	COUNTY	SHEET NO.	TOTAL SHEETS
W. V. 9	5346-3372-2	2.34 00	NFA-2417 18250	2020	DODDRIDGE	81	

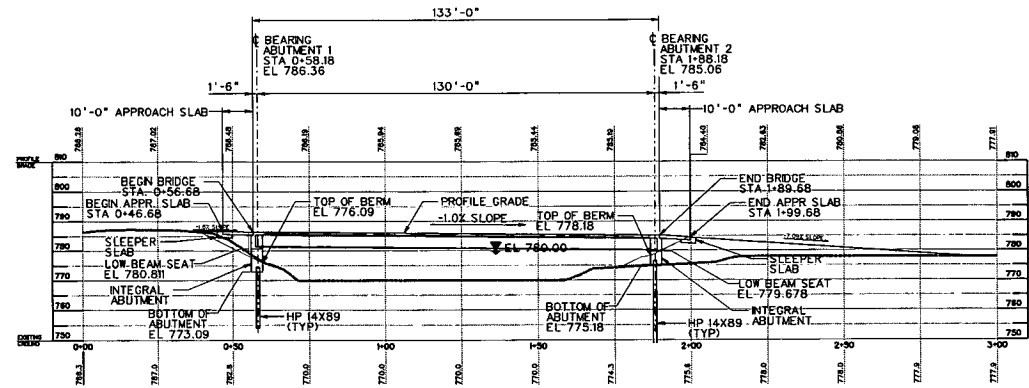

REVISION NUMBER	SHEET NUMBER	REVISION	DATE	BY



**DODDRIDGE COUNTY**  
**PRE-K**  
**ACCESS BRIDGE**

**THRASHER**  
 300 ASSOCIATION DRIVE  
 CHARLESTON, WY 82501  
 www.thrashergrp.com  
 PHONE (304)343-7801 FAX (304)343-7804

DESIGNED	DATE
RLC	08/20
DRAWN	
SON	08/20
CHECKED	
CHECKED	

GENERAL PLAN AND ELEVATION  
 SHEET B- OF B-53  
 BRIDGE NO. 1797.2

PUBLIC ROAD DIST.	STATE DIST.	STATE PROJECT NO.	FEDERAL PROJECT NO.	FISCAL YEAR	COUNTY	SHEET NO.	TOTAL SHEETS
W. V.	9	5343-3372-7.34 BB	NFA-2417 (82510)	2020	DODDRIDGE		81

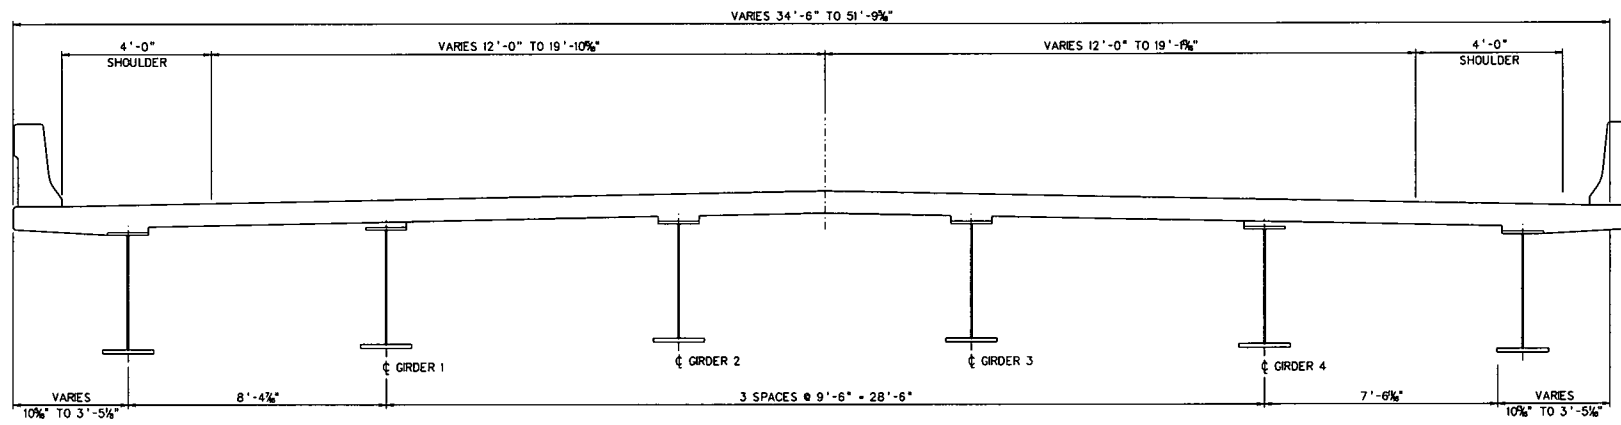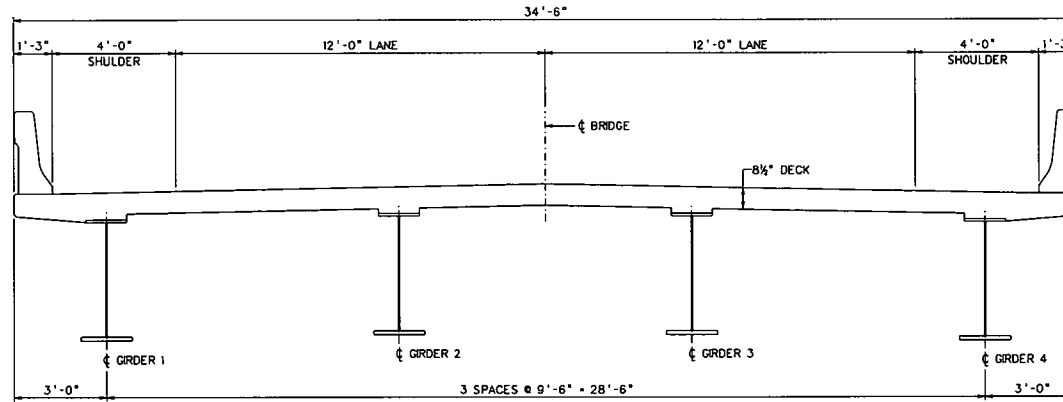

DESIGNED	DATE	08/20
DRAIN	DATE	08/20
CHECKED		
CHECKED		

REVISION NUMBER	SHEET NUMBER	REVISION	DATE	BY

**DODDRIDGE COUNTY BOARD OF EDUCATION**

**DODDRIDGE COUNTY PRE-K ACCESS BRIDGE**

**TYPICAL SECTION**

SHEET	B-	OF B-	53
BRIDGE NO.	1797.2		

**THRASHER**

300 ASSOCIATION DRIVE  
CHARLESTON, WV 25311  
www.thrashergroup.com

FAX  
(304)343-7804



### BLAST CLEANING AND PAINTING

UPON COMPLETION OF ALL FABRICATION OPERATIONS IN THE SHOP, AND BEFORE SHIPMENT TO THE PROJECT SITE, ALL WEATHERING STEEL BRIDGE COMPONENTS SHALL BE BLAST CLEANED TO A NEAR WHITE SURFACE CONDITION ACCORDING TO SSPC-SP 10. PRIOR TO THE START OF ANY BLAST CLEANING, ALL OIL, GREASE, CUTTING FLUIDS, OR OTHER FOREIGN MATTER SHALL BE REMOVED FROM THE SURFACES OF THE STEEL BY SOLVENT CLEANING ACCORDING TO SSPC-SP 1.

FOR INTEGRAL ABUTMENT STRUCTURES, PAINT THE PERMANENT END DIAPHRAGM, EXPOSED STEEL PORTIONS OF THE BEARINGS AND ENDS OF THE BEAMS IN THE CONCRETE ABUTMENT PLUS ONE ADDITIONAL FOOT IN LENGTH. THE COLOR SHALL CONFORM TO SAE INTERNATIONAL AMS-STD-595A, COLOR NO. 20062, BROWN. ALL OTHER STRUCTURAL STEEL COMPONENTS ENCASED IN CONCRETE SHALL HAVE ONE COAT OF PRIMER ONLY.

THE COVERS OF THE EXPANSION JOINTS AT OR ABOVE THE DECK SHALL BE PAINTED. THE COLOR SHALL CONFORM TO SAE INTERNATIONAL AMS-STD-595A, COLOR NO. 37886, FLAT YELLOW.

### PROTECTION OF CONCRETE

TAKE APPROPRIATE MEASURES TO PROTECT THE CONCRETE SUBSTRUCTURE FROM RUST STAINING DURING CONSTRUCTION AND CURING OF THE SUPERSTRUCTURE CONCRETE. DEFLECT WATER RUNOFF FROM CURING OPERATIONS AWAY FROM THE STEEL GIRDERS AND DO NOT ALLOW WATER TO DRAIN ONTO THE SUBSTRUCTURE CONCRETE AFTER COMING INTO CONTACT WITH THE WEATHERING STEEL.

UPON COMPLETION OF ALL SUPERSTRUCTURE CONCRETE CURING OPERATIONS, REMOVE ALL RUST STAINS FROM SUBSTRUCTURE UNITS WITH PROPRIETARY CHEMICAL STAIN REMOVERS OR MILD ACID ETCHING. USE ABRASIVE BLAST CLEANING TO SUPPLEMENT THE OTHER CLEANING METHODS IF THE STAINED AREAS ARE SEVERE OR EXTENSIVE. ALL CLEANING METHODS SHALL BE SUBJECT TO APPROVAL BY THE ENGINEER.

### DECK FORMS

STAY-IN-PLACE DECK FORMS SHALL BE USED ON THIS PROJECT. APPROXIMATE AREA - 5,108 SQ. FT. - EDGE OF BEAM FLANGE TO EDGE OF BEAM FLANGE IN INTERIOR BAYS, EXCLUDING DECK OVERHANG.

USE REMOVABLE FORMS TO CONSTRUCT DECK OVERHANGS AND DECK BETWEEN BEAMS 3-4 AND 9-10.

### DECK SLAB OVERHANG FORM

DECK SLAB OVERHANG FORMS SHALL BE SUPPORTED FROM THE BOTTOM FLANGE OF FASCIA GIRDERS. THE CONTRACTOR'S FORMING PLAN, FOR THE DECK OVERHANG, SHALL BE SUBMITTED TO THE DIVISION FOR APPROVAL BY THE ENGINEER PRIOR TO ERECTING THE FORMWORK. DESIGN OF FORMWORK SHALL BE BY A PROFESSIONAL ENGINEER REGISTERED IN THE STATE OF WEST VIRGINIA, WHO SHALL ALSO VERIFY THAT THE DESIGN IS UTILIZED.

FORM SYSTEMS THAT WILL CAUSE OVERSTRESS OR DEFORMATION TO PERMANENT BRIDGE MEMBERS SHALL NOT BE PERMITTED. THE CONTRACTOR SHALL SUBMIT CALCULATIONS VERIFYING THAT THIS REQUIREMENT IS SATISFIED.

### SHOP DRAWINGS

ALL SHOP DRAWINGS WILL BE SUBJECT TO THE REQUIREMENTS OF SECTION 105.2. SUBMIT SHOP DRAWINGS TO:

THE THRASHER GROUP, INC.  
300 ASSOCIATION DRIVE  
CHARLESTON, WV 25311  
MYLER@THETHRASHERGROUP.COM

THE DESIGN CALCULATIONS AND PLANS FOR ANY PROPOSED FALSEWORK, SHORING AND OTHER TEMPORARY SUPPORTS OR BRACING REQUIRED TO CONSTRUCT THE BRIDGE SHALL BE SIGNED AND SEALED BY A PROFESSIONAL ENGINEER REGISTERED IN THE STATE OF WEST VIRGINIA, WHO SHALL ALSO VERIFY THAT THE DESIGN IS UTILIZED BEFORE BEING SUBMITTED TO THE ENGINEER FOR REVIEW.

### SUBSURFACE INVESTIGATION

IN SEPTEMBER OF 2019, WVDOT MATERIALS DIVISION GEOTECHNICAL GROUP DRILLED CORE BORINGS. ADDITIONAL BORINGS WERE PERFORMED BY TERRACON NEAR THE BRIDGE STRUCTURE. THE GEOTECHNICAL AND FOUNDATION DESIGNS ARE BASED ON ALL BORINGS AND THE SUBSURFACE INVESTIGATION REPORT WAS PREPARED BY TERRACON. THIS REPORT INCLUDES THE ENGINEERING LOGS AS COMPILED BY FIELD DATA.

### GEOTECHNICAL INFORMATION

GEOTECHNICAL INFORMATION IS PROVIDED WITH THESE PLANS AND SHALL BE CONSIDERED AS A PART OF THE CONTRACT DOCUMENTS. THE GEOTECHNICAL REPORT MAY CONTAIN INFORMATION THAT COULD IMPACT THE CONSTRUCTION SCHEDULE DEPENDING UPON THE CONTRACTOR'S SEQUENCE OF CONSTRUCTION.

THE INFORMATION PRESENTED IS BASED IN PART ON SMALL DIAMETER TEST BORINGS AND SHOULD BE CONSIDERED AS APPROXIMATE. SHOULD DIFFERING CONDITIONS BE ENCOUNTERED, THE CONTRACTOR SHALL CONTACT THE ENGINEER AT THE EARLIEST OPPORTUNITY FOR RE-EVALUATION PRIOR TO PROCEEDING WITH WORK ON THAT PORTION OF THE PROJECT.

### UTILITIES

THE CONTRACTOR SHALL BE RESPONSIBLE FOR THE VERIFICATION OF EXISTING UTILITIES IN THE AREA OF WORK. CONTRACTOR WILL ASSUME FULL RESPONSIBILITY TO PROTECT THESE UTILITIES AND ASSURE THAT THESE UTILITIES ARE NOT DAMAGED AND NOT DISTURBED.

### MSE WALLS

MSE WALL DESIGN AND CONSTRUCTION MUST BE IN ACCORDANCE WITH SECTION 626 OF THE WVDOT STANDARD SPECIFICATIONS.

A MINIMUM REINFORCEMENT LENGTH OF 70 PERCENT OF THE WALL HEIGHT SHALL BE USED TO MEET EXTERNAL STABILITY REQUIREMENTS; HOWEVER, IN NO CASE SHOULD THE REINFORCEMENT LENGTH BE LESS THAN 8.0 FEET.

### SELECT EMBANKMENT

ALL FILL EMBANKMENTS FOR THIS PROJECT SHALL BE CONSTRUCTED IN ACCORDANCE WITH THE WVDOT STANDARD SPECIFICATIONS SECTION 207.

SIDEHILL AND SILVER FILLS SHOULD BE CONSTRUCTED BY EXCAVATING A BENCH AT THE TOE OF THE FILL SLOPE. THE BOTTOM OF THIS BENCH SHOULD SLOPE AWAY FROM THE EMBANKMENT AT A SLOPE OF 20:1 (H:V). SIDEHILL FILL SHOULD BE BENCHED (KEYED) INTO THE EXISTING EMBANKMENT AS THE FILL PROGRESSES UP THE SLOPE. ALL FILL SHOULD BE PLACED IN LEVEL, HORIZONTAL LIFTS IN ACCORDANCE WITH THE WVDOT STANDARD SPECIFICATIONS. A MAXIMUM FILL EMBANKMENT SLOPE OF 2:1 (H:V) SHALL BE USED WHERE POSSIBLE AND ALL LOCATIONS WHERE RANDOM FILL IS PLACED, IN AREAS WHERE IT IS REQUIRED TO USE SLOPES STEEPER THAN 2:1, SELECT EMBANKMENT FILL MUST BE UTILIZED. IN NO CASE, SHALL THE FILL BE SLOPED STEEPER THAN 1.5H:1V.

### BRIDGE PLATE

A BRONZE PLATE, CARRYING THE PROJECT NUMBER, THE NUMBER OF THE BRIDGE, AND THE YEAR OF THE BRIDGE CONSTRUCTION, WILL BE FURNISHED AND PLACED BY THE CONTRACTOR WITHOUT EXTRA COMPENSATION. THE NAMEPLATE SHALL BE PLACED IN THE RAILINGS AS DESIGNATED BY THE ENGINEER. THE PLATE SHALL BE A MINIMUM OF 8 INCHES BY 10 INCHES (200 BY 250 MM) WIDE, WITH LETTERS AND NUMBER 3/4 INCH (20 MM) MINIMUM HEIGHT RAISED 1/4 INCH (3 MM) ABOVE THE SURFACE OF THE PLATE. THE INFORMATION ON THE PLATE SHALL BE ARRANGED AS SHOWN IN SECTION 104.8 OF THE STANDARD SPECIFICATIONS.

### SPECIAL PROVISIONS

SECTION 615 ELASTOMERIC BEARINGS  
SECTION 616 DYNAMIC PILE TESTING  
SECTION 627 STRIP SEAL EXPANSION JOINT ASSEMBLY

### DECK

THE 8 1/4 INCH THICK CAST-IN-PLACE DECK SHALL HAVE A MINIMUM OF 3" COVER OF WHICH 1/4" SHALL BE REMOVED BY DIAMOND GRINDING IN ACCORDANCE WITH SECTION 508 OF THE STANDARD SPECIFICATIONS EXCEPT DURABILITY REQUIREMENTS SHALL BE IN ACCORDANCE WITH SECTION 601.11.4.3 OF THE STANDARD SPECIFICATION. THE DECK SHALL ALSO RECEIVE LONGITUDINAL GROOVING IN ACCORDANCE WITH SECTION 601.11.4.2 OF THE STANDARD SPECIFICATION AFTER DIAMOND GRINDING. COST ASSOCIATED WITH THIS WORK SHALL BE INCIDENTAL TO THE PAY ITEM 601009-00, CLASS H CONCRETE.

### DECK PLACEMENT

THE DECK PLACEMENT SEQUENCE IS SHOWN BY PLACEMENT NUMBERS ON THE DECK POUR SEQUENCE. CONCRETE MUST ATTAIN A MINIMUM STRENGTH OF 3000 PSI BEFORE SUBSEQUENT PLACEMENTS ARE MADE.

### DECK PLACEMENT DESIGN ASSUMPTIONS

THE FOLLOWING ASSUMPTIONS OF CONSTRUCTION MEANS AND METHODS WERE MADE FOR THE ANALYSIS AND DESIGN OF THE SUPERSTRUCTURE. THE CONTRACTOR IS RESPONSIBLE FOR THE DESIGN OF THE FALSE WORK SUPPORT SYSTEM WITHIN THESE PARAMETERS AND WILL ASSUME RESPONSIBILITY FOR THE SUPERSTRUCTURE ANALYSIS FOR DEVIATION FROM THESE DESIGN ASSUMPTIONS.

AN EIGHT WHEEL FINISHING MACHINE WITH A MAXIMUM WHEEL LOAD OF 1.2 KIPS FOR A TOTAL MACHINE LOAD OF 10 KIPS.

A MINIMUM OUT - TO - OUT WHEEL SPACING AT EACH END OF THE MACHINE OF 132 IN.

A MAXIMUM SPACING OF OVERHANG FALSE WORK BRACKETS OF 48 IN.

A MAXIMUM DISTANCE FROM THE CENTERLINE OF THE FASCIA GIRDER TO THE FACE OF THE SAFETY HANDRAIL OF 72 IN.

PUBLIC WORK DIST.	STATE DIST.	STATE PROJECT NO.	FEDERAL PROJECT NO.	FISCAL YEAR	COUNTY	SHEET NO.	TOTAL SHEETS
W. V.	9	SS17-2-34 88	NFA-2417 0229D	2020	DODDRIDGE	47	61

### ABBREVIATIONS

AASHTO - AMERICAN ASSOCIATION OF STATE HIGHWAY TRANSPORTATION OFFICIALS	LS - LUMP SUM
ABUT - ABUTMENT	MAT - MATERIAL
BOS - BOTTOM OF SLAB	MAX - MAXIMUM
BOT - BOTTOM	MIN - MINIMUM
BRG - BEARING	MK - MARK
BTWN - BETWEEN	NF - NEAR FACE
CJ - CONSTRUCTION JOINT	NTS - NOT TO SCALE
CLR - CLEAR	OD - OUTSIDE DIAMETER
CTR - CENTER	OHW - ORDINARY HIGH WATER
C/L - CENTER LINE	PSI - POUNDS PER SQUARE INCH
CY - CUBIC YARD	PVC - POLY VINYL CHLORIDE
DIA - DIAMETER	R - RADIUS
EA - EACH	RCJ - ROUGHENED CONSTRUCTION JOINT
EF - EACH FACE	REC - RECOVERED
EL - ELEVATION	REQ'D - REQUIRED
EQW - EDGE OF WATER	RQD - ROCK QUALITY DESIGNATION
EQ - EQUAL	SER - SERIES
ES - EACH SIDE	SF - SQUARE FOOT
EXP - EXPANSION	SIP - STAY IN PLACE FORMS
FF - FAR FACE	SPA - SPACES
FS - FIELD SPLICE	SQ - SQUARE
FTG - FOOTING	STA - STATION
GA - GAUGE	T&B - TOP AND BOTTOM
GDR - GIRDER	TOS - TOP OF SLAB
HS - HIGH STRENGTH	TYP - TYPICAL
ID - INSIDE DIAMETER	VC - VERTICAL CURVE
SEM-INT - SEMI INTEGRAL	VCI - VERTICAL CONSTRUCTION JOINT
LF - LINEAR FOOT	WP - WORK POINT
LRFD - LOAD AND RESISTANCE FACTOR DESIGN	TCB - TEMPORARY CONCRETE BARRIER

REVISION NUMBER	SHEET NUMBER	REVISION	DATE	BY
DODDRIDGE COUNTY BOARD OF EDUCATION				
<b>DODDRIDGE COUNTY PRE-K ACCESS BRIDGE</b>				
<b>GENERAL NOTES SHEET 2 OF 2</b>				SHEET B-06 OF B-53 BRIDGE NO. 1797.2


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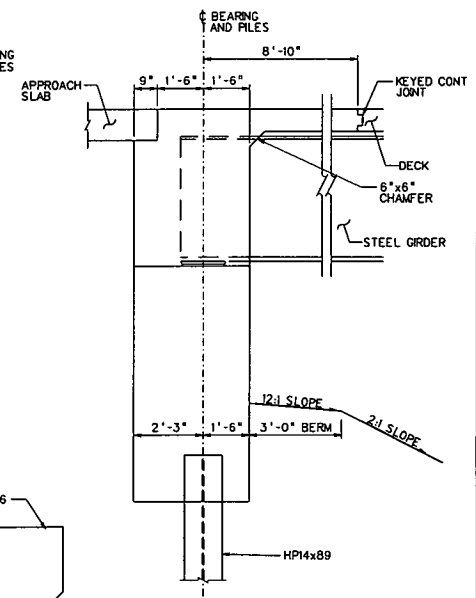
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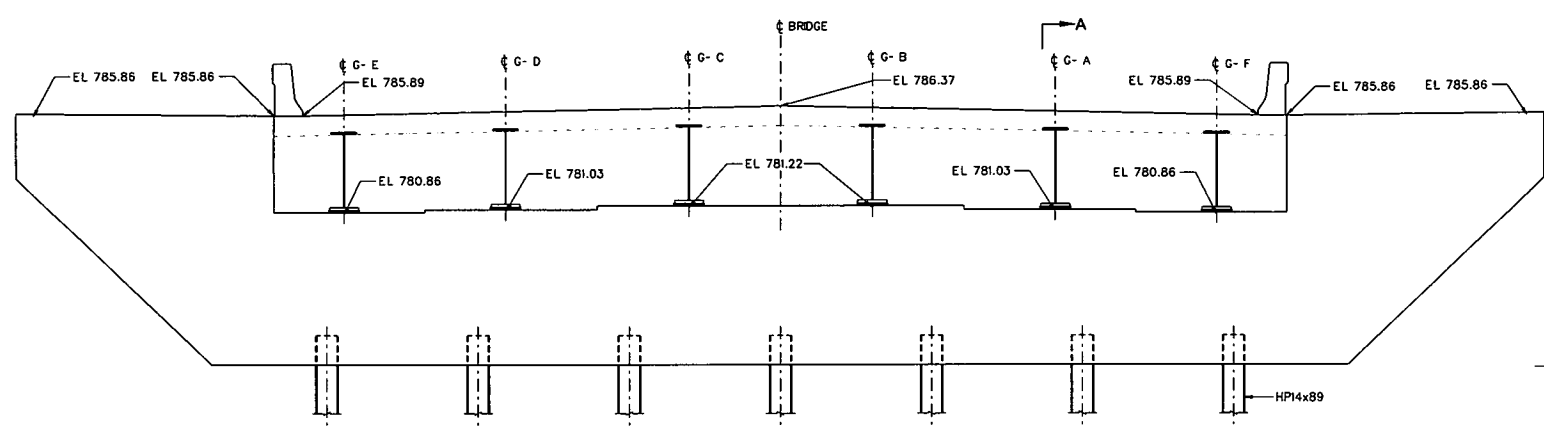
PUBLIC ROAD DIST.	STATE DIST. NO.	STATE PROJECT NO.	FEDERAL PROJECT NO.	FISCAL YEAR	COUNTY	SHEET NO.	TOTAL SHEETS
W. V.	9	S349-3372-2-34 (88)	HPA-2417 (025K)	2020	DODDRIDGE	81	



**ABUTMENT 1 PLAN**  
SCALE: NOT TO SCALE



**SECTION A-A**  
SCALE: 1/2" = 1'-0"

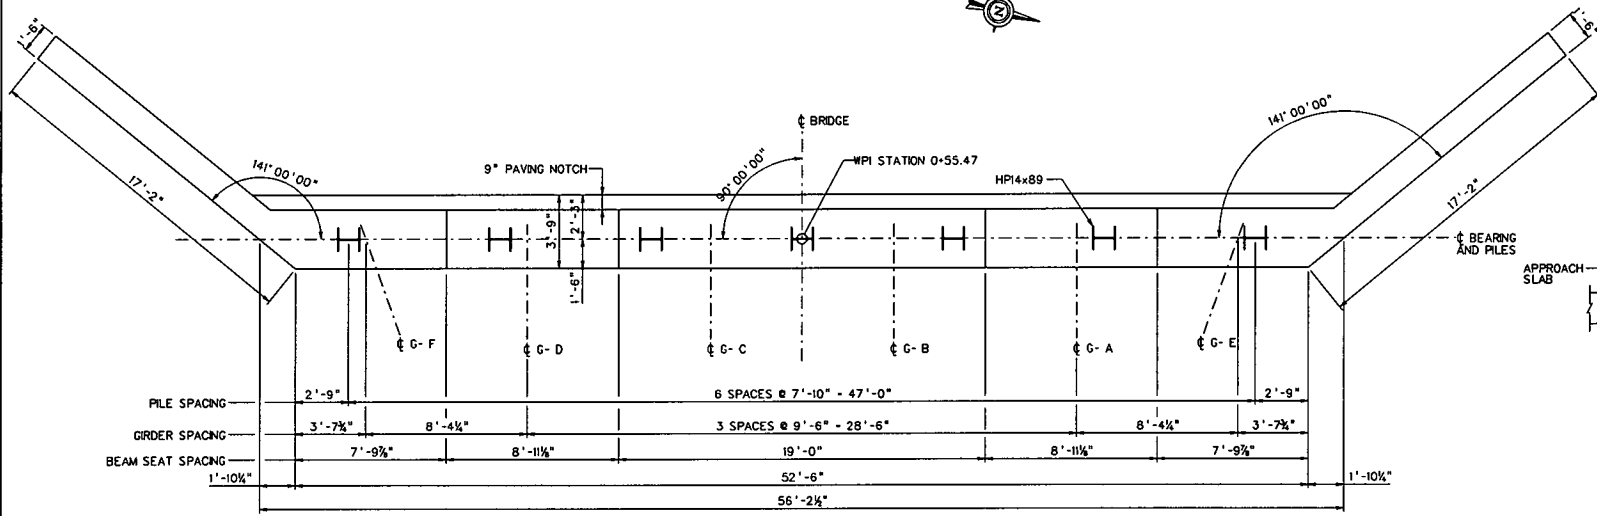

**ABUTMENT 1 ELEVATION**  
(LOOKING BACK STATION)  
SCALE: NOT TO SCALE

DESIGNED	DATE	REVISION	DATE	BY
RLC	06/20			
DRAWN	DATE			
SCM	06/20			
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CHECKED				

**DODDRIDGE COUNTY BOARD OF EDUCATION**

**DODDRIDGE COUNTY PRE-K ACCESS BRIDGE**

**ABUTMENT 1 PLAN AND ELEVATION**

SHEET **B-1797.2** OF B-53  
BRIDGE NO. 1797.2




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PUBLIC ROADS DIST.	STATE DIST. NO.	STATE PROJECT NO.	FEDERAL PROJECT NO.	FISCAL YEAR	COUNTY	SHEET NO.	TOTAL SHEETS
W. V.	9	5345 -33/2- 2.34 BB	HF-A-2417 (025ND)	2020	DODDRIDGE	81	



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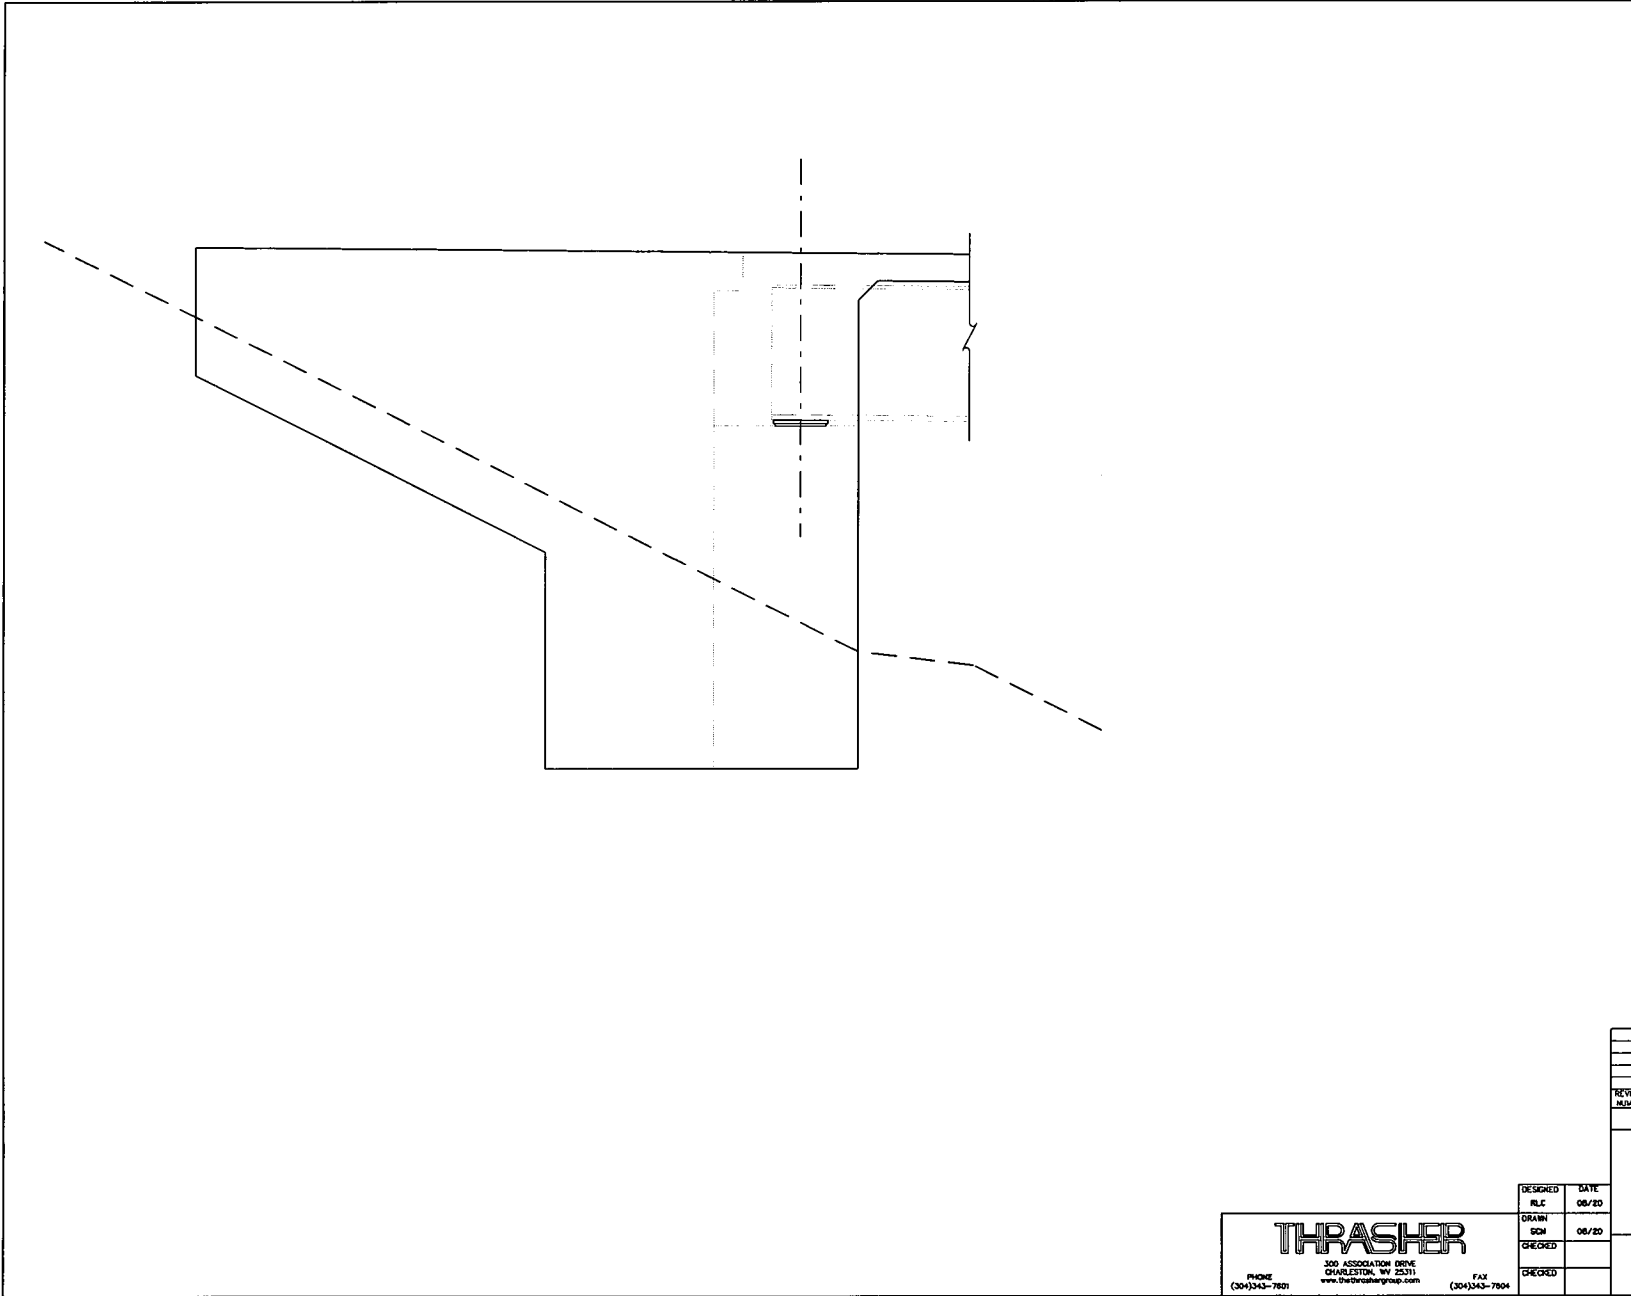
REVISION NUMBER	SHEET NUMBER	DATE	BY
DODDRIDGE COUNTY BOARD OF EDUCATION			
<b>DODDRIDGE COUNTY PRE-K ACCESS BRIDGE</b>			
SHEET		B- OF B- 53	
BRIDGE NO.		1797.2	

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W. V.	9	S345-33/2-2-34 (88)	HPA-2417 (825)D	2020	DODDRIDGE		81

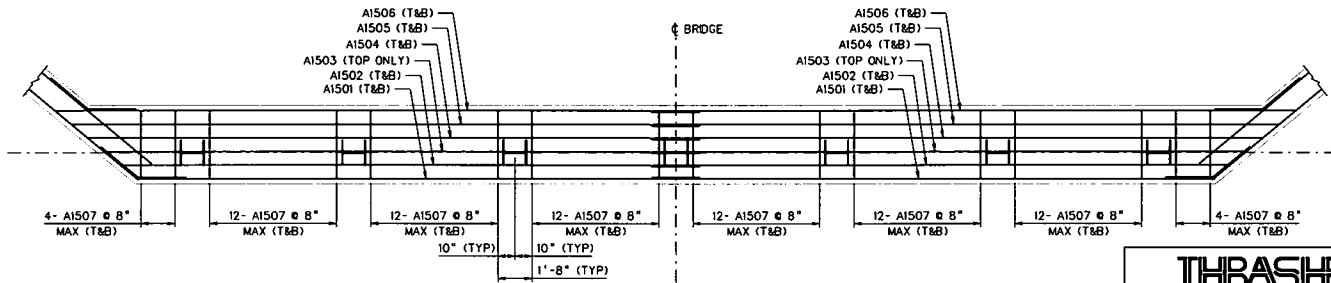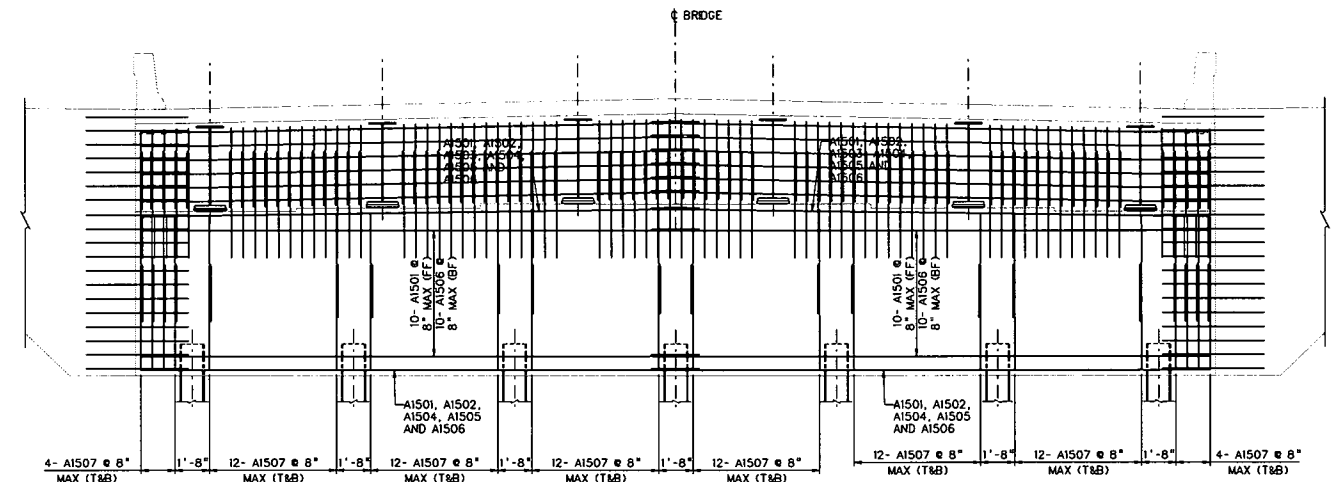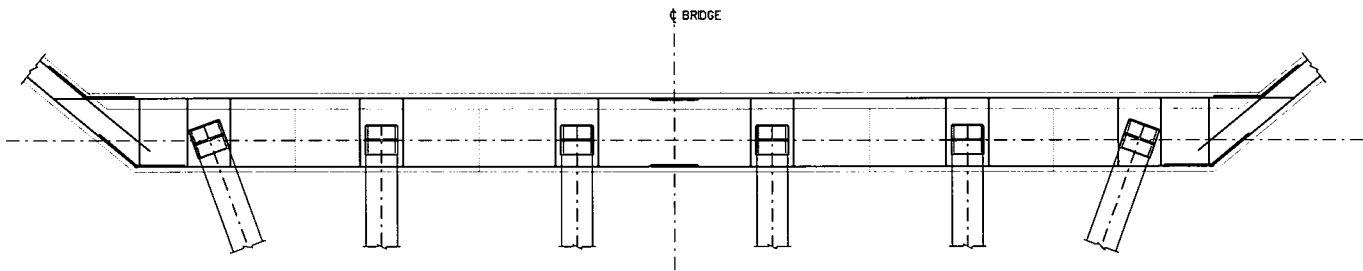

REVISION NUMBER	SHEET NUMBER	REVISION	DATE	BY
DODDRIDGE COUNTY BOARD OF EDUCATION				
<b>DODDRIDGE COUNTY PRE-K ACCESS BRIDGE</b>				
				SHEET
				B- OF B-53
				BRIDGE NO.
				1797.2

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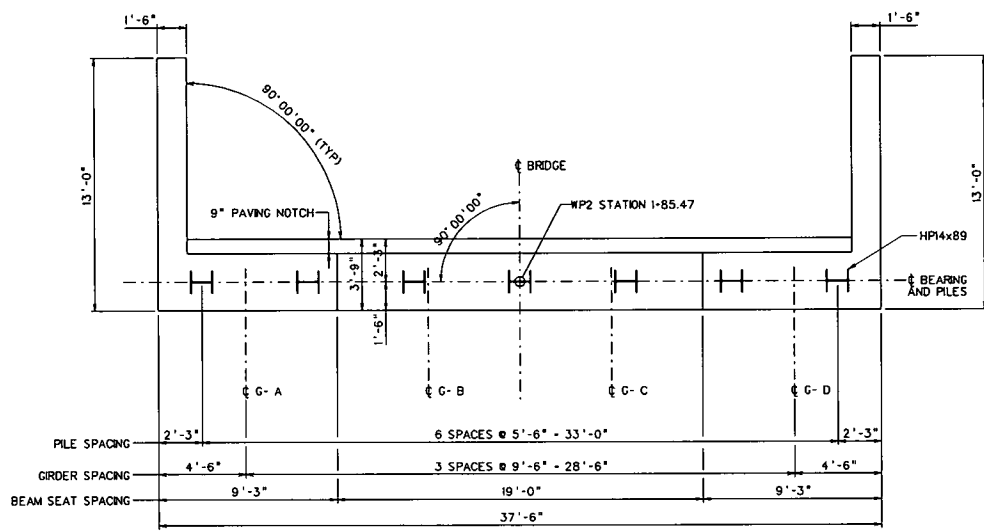
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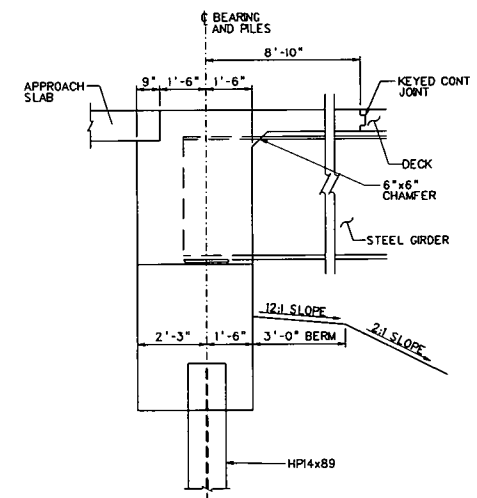
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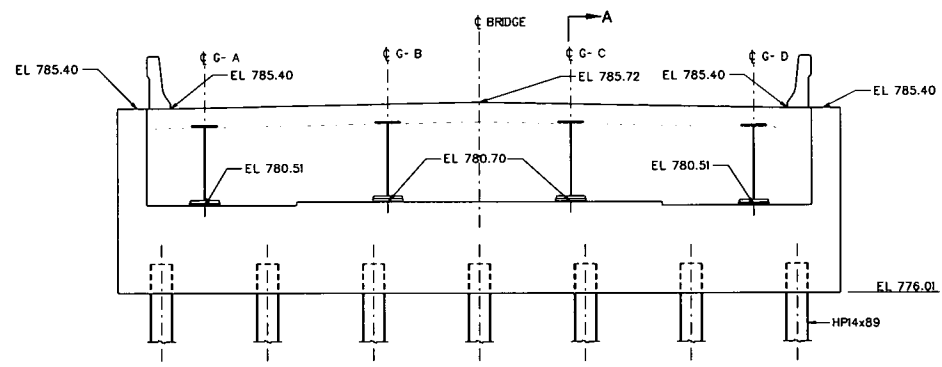
PUBLIC WORKS DIV.	STATE DIST. NO.	STATE PROJECT NO.	FEDERAL PROJECT NO.	FISCAL YEAR	COUNTY	SHEET NO.	TOTAL SHEETS
W. V.	9	SC-10-33/2-2.34	HPA-2417 (02510)	2020	DODDRIDGE	81	



**ABUTMENT 2 PLAN**  
SCALE: NOT TO SCALE



**SECTION A-A**  
SCALE: 1/4" = 1'-0"



**ABUTMENT 2 ELEVATION**  
(LOOKING BACK STATION)  
SCALE: NOT TO SCALE

DESIGNED	DATE	BY
DRAWN	09/20	
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CHECKED		

REVISION NUMBER	REVISION	DATE	BY

**DODDRIDGE COUNTY BOARD OF EDUCATION**

**DODDRIDGE COUNTY PRE-K ACCESS BRIDGE**

**ABUTMENT 2 PLAN AND ELEVATION**


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BRIDGE NO.	1797.2

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PUBLIC WORKS DIST.	STATE DIST. NO.	STATE PROJECT NO.	FEDERAL PROJECT NO.	FISCAL YEAR	COUNTY	SHEET NO.	TOTAL SHEETS
W. V.	9	5345-30/2-2.54 BR	NFO-2417 (8251D)	2026	DODDRIDGE	81	



REVISION NUMBER	SHEET NUMBER	REVISION	DATE	BY

DODDRIDGE COUNTY  
BOARD OF EDUCATION

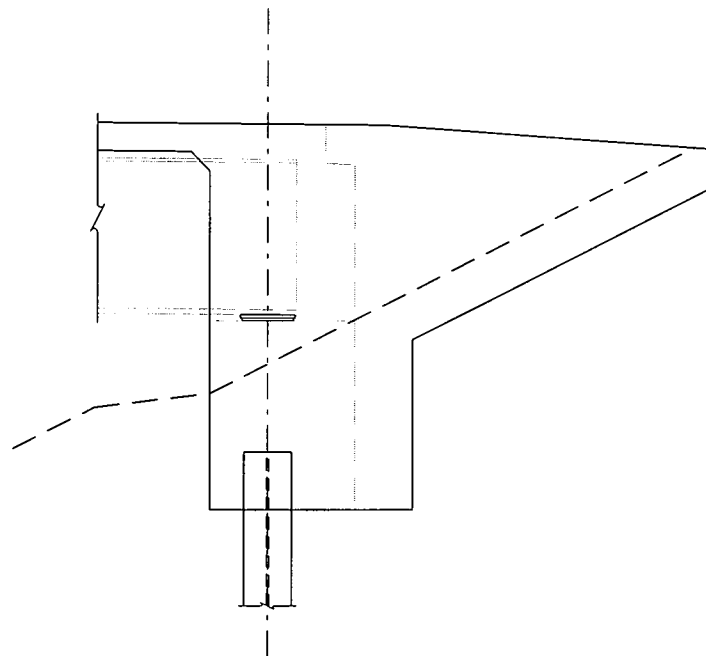**DODDRIDGE COUNTY  
PRE-K  
ACCESS BRIDGE**

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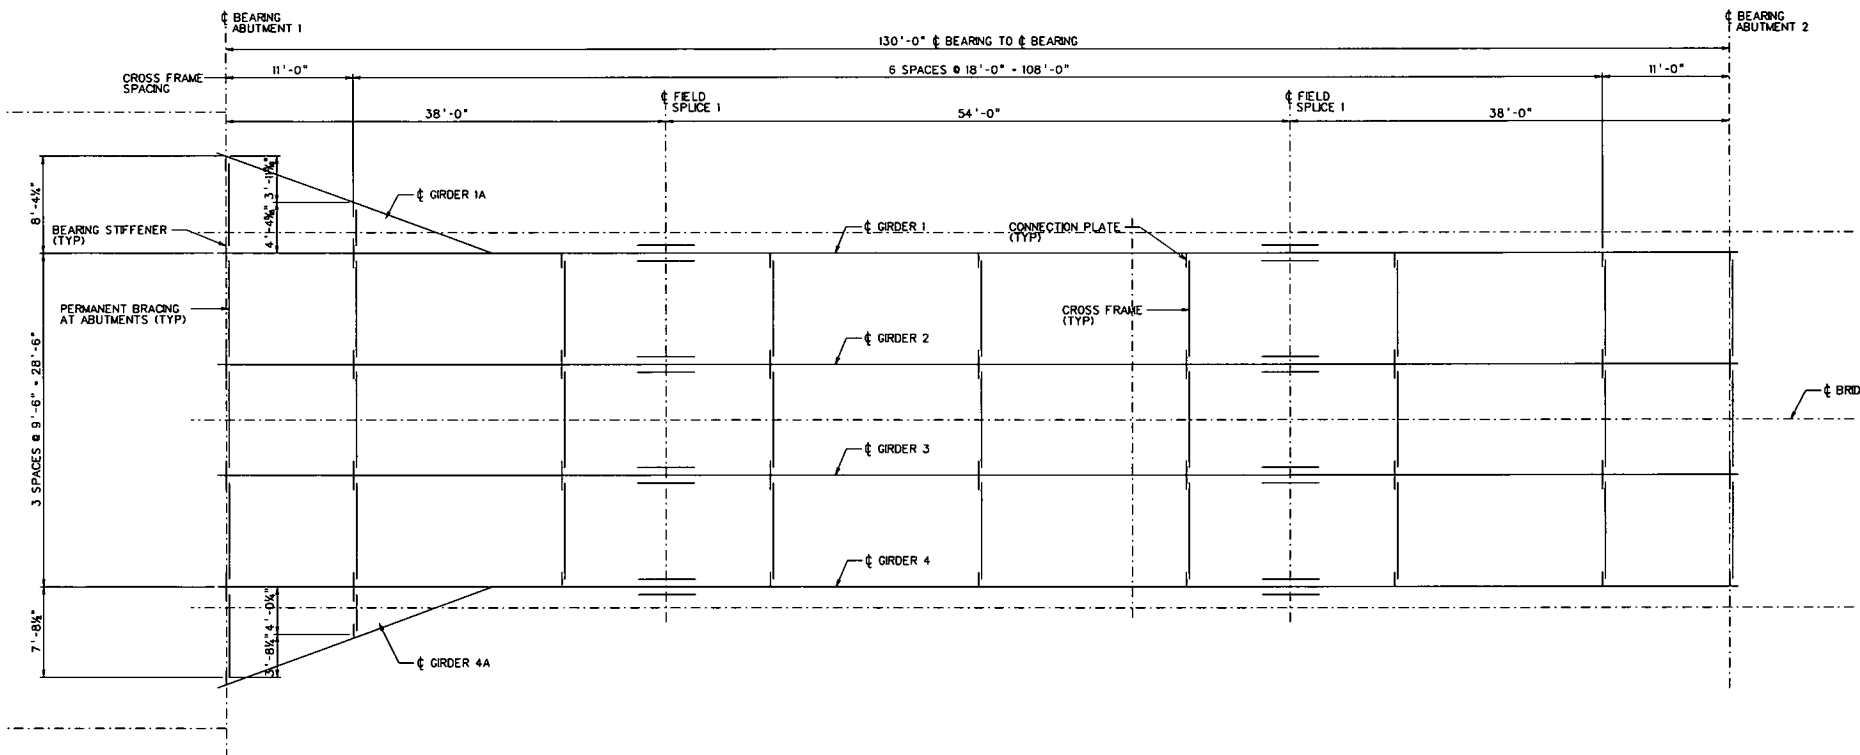
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PUBLIC WORKS CITY	STATE DIST. NO.	STATE PROJECT NO.	FEDERAL PROJECT NO.	FISCAL YEAR	COUNTY	SHEET NO.	TOTAL SHEETS
W. V.	9	3345-33/2-2.34 BB	NFA-2417 (02250)	2020	DODDRIDGE	81	



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REVISION NUMBER	SHEET NUMBER	REVISION	DATE	BY

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**DODDRIDGE COUNTY PRE-K ACCESS BRIDGE**

**FRAMING PLAN**




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BRIDGE NO. 1797.2

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PUBLIC WORKS DIV.	STATE DIST. NO.	STATE PROJECT NO.	FEDERAL PROJECT NO.	FISCAL YEAR	COUNTY	SHEET NO.	TOTAL SHEETS
W. V.	9	SS45-35/2-2.54.00	MF0-2417 (02910)	2020	DODDRIDGE	81	81



**GIRDER END DETAIL**  
SCALE: NOT TO SCALE

**NOTES:**

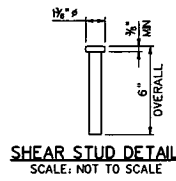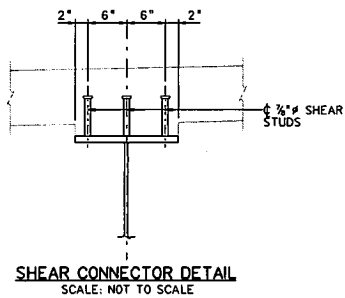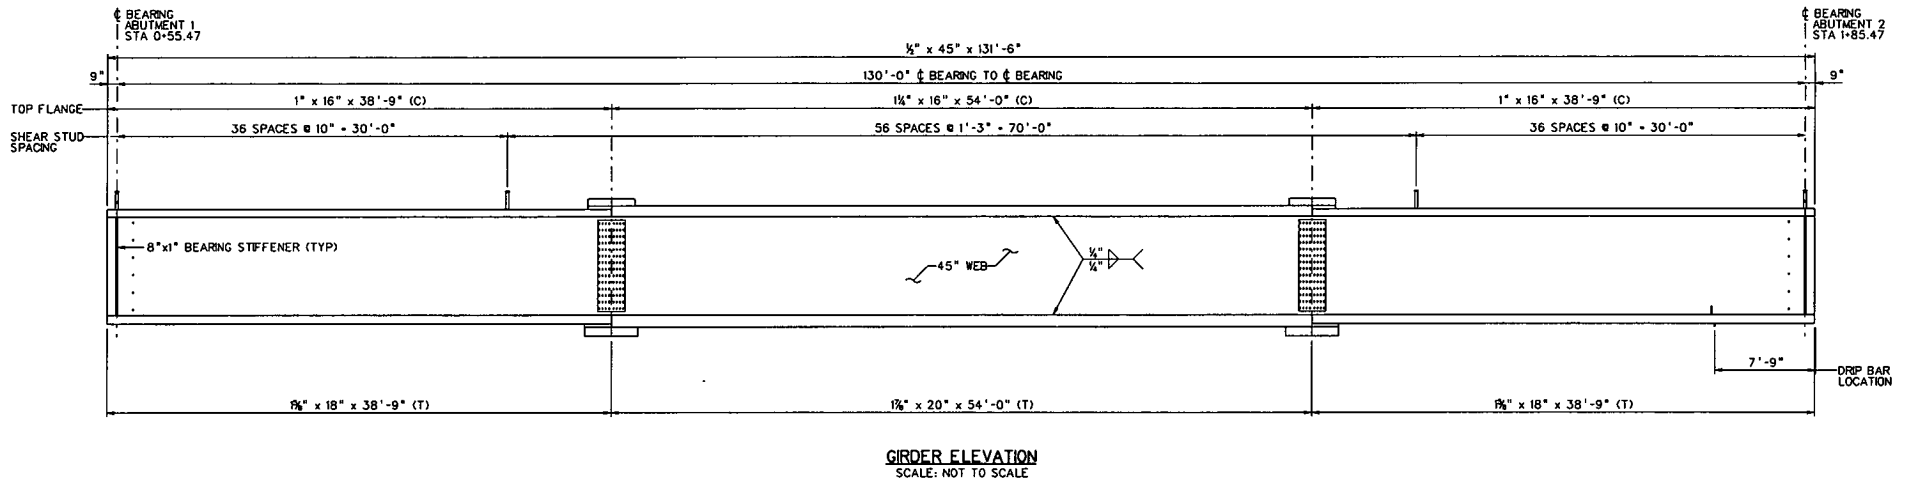1. ALL STEEL FOR BEAMS, DIAPHRAGM CONNECTION PLATES SHALL CONFORM TO AASHTO M270 50W-T2 UNLESS NOTED.
2. STEEL GRADE FOR BEARING STIFFENERS SHALL CONFORM TO AASHTO M270 GRADE 50W.
3. ALL BEARING STIFFENERS SHALL BE TRULY VERTICAL UNDER FULL DEAD LOAD.
4. ALL DIAPHRAGM CONNECTION PLATES SHALL BE PERPENDICULAR TO THE FLANGES.
5. FOR DIAPHRAGM, FIELD SPLICE AND MISCELLANEOUS STEEL DETAILS SEE SHEETS B-25 TO B-29.
6. ALL BOLTS UNLESS OTHERWISE NOTED SHALL BE 3/4" DIA SLIP-CRITICAL HS BOLTS, TYPE 3 (ASTM F3125 GRADE A325).
7. ALL HOLES FOR 3/4" DIA HS BOLTS SHALL BE 5/8" DIA UNLESS OTHERWISE NOTED.
8. FOR WELD SIZE, SEE SHEET B-29.
9. FOR CAMBER DIAGRAM, SEE SHEET B-30.
10. FOR FRAMING PLAN, SEE SHEET B-24.

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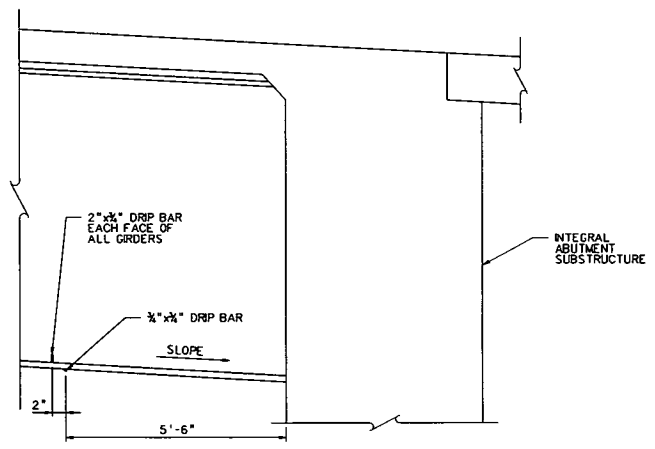
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SCM	08/20
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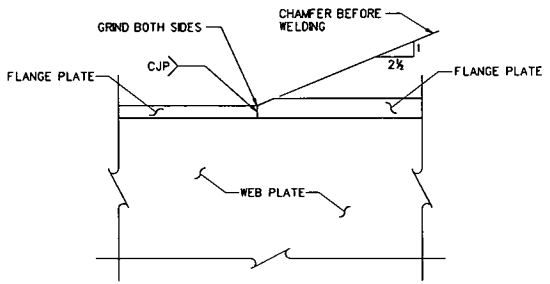
REVISION NUMBER	SHEET NUMBER	REVISION	DATE	BY
DODDRIDGE COUNTY BOARD OF EDUCATION				
<b>DODDRIDGE COUNTY PRE-K ACCESS BRIDGE</b>				
<b>GIRDER ELEVATION</b>				SHEET B- OF B- 53
				BRIDGE NO. 1797.2

30-11-17-2020


PUBLIC BODYS CITY	STATE DIST. NO.	STATE PROJECT NO.	FEDERAL PROJECT NO.	FISCAL YEAR	COUNTY	SHEET NO.	TOTAL SHEETS
W. V.	9	5343-33/2-2.34 BB	NFA-2417 (B25ND)	2020	DODDRIDGE	255	01



**ELEVATION VIEW DRIP BAR LOCATIONS**  
SCALE: NOT TO SCALE




**ELEVATION FLANGE SPLICE DETAIL**  
SCALE: NOT TO SCALE

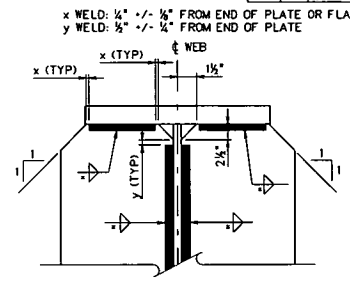


**DETAIL AT END OF CONNECTION PLATE**  
SCALE: NOT TO SCALE

WELD SIZES	
PLATE THICKNESS	WELD SIZE
< 3/4"	1/4"
≥ 3/4"	3/8"


ALL WELDS SHALL CONFORM TO THE 2015 WELDING CODE ANSI / AASHTO / AWS D1.5

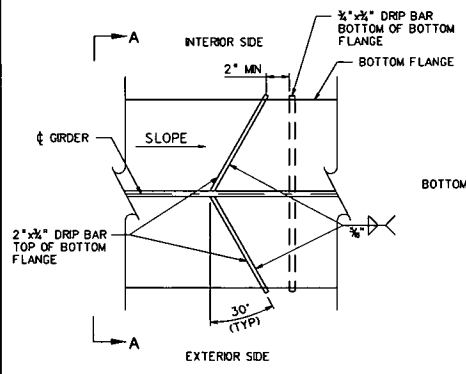


**PLAN VIEW DRIP BAR LOCATIONS**  
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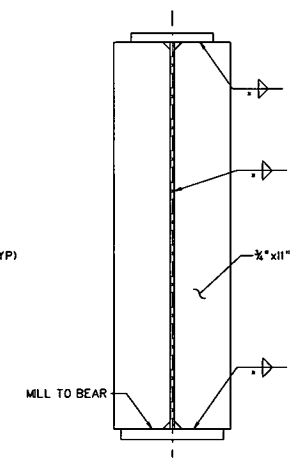
**VIEW A-A**  
SCALE: NOT TO SCALE

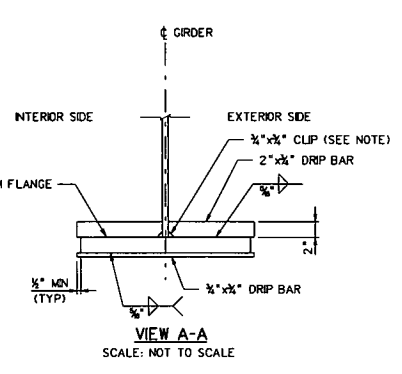

**INTERMEDIATE CONNECTION PLATE DETAIL**  
SCALE: NOT TO SCALE (INTERIOR GIRDER SHOWN)

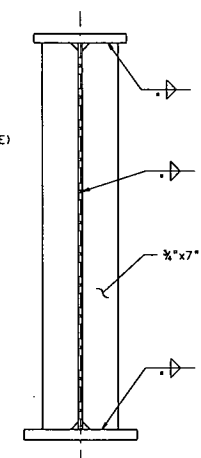

**BEARING STIFFENER DETAIL**  
SCALE: NOT TO SCALE

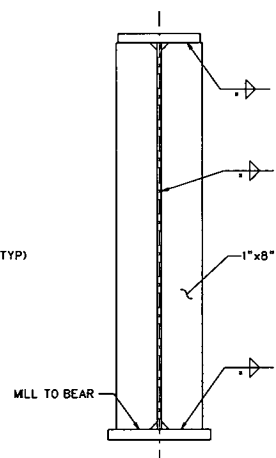

**ABUTMENT CONNECTION PLATE DETAIL**  
SCALE: NOT TO SCALE (INTERIOR GIRDER SHOWN)

**NOTE:**  
DRIP BAR ON BOTTOM FLANGE SHALL BE CAULKED WITH DARK BROWN CAULKING AGAINST FLANGE, WEB AND FILLET WELD SUBJECT TO THE APPROVAL OF THE ENGINEER. INCLUDE COST IN ITEM 615001-001 STEEL SUPERSTRUCTURE. SEE FRAMING PLAN AND GIRDER ELEVATION FOR LOCATION OF DRIP BARS.

**DRIP BAR DETAILS**


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FILE	09/20	NUMBER	NUMBER
DRAWN		REVISION	DATE
SDM			BY
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CHECKED		<b>DODDRIDGE COUNTY PRE-K ACCESS BRIDGE</b>	
		<b>MISCELLANEOUS STEEL DETAILS</b>	
		SHEET B-29 OF B-53	
		BRIDGE NO. 1797.2	

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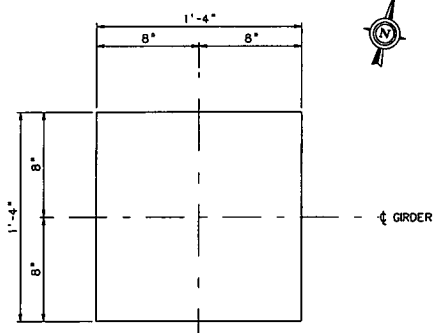
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PUBLIC PROJECT DIV.	STATE DIST. NO.	STATE PROJECT NO.	FEDERAL PROJECT NO.	FISCAL YEAR	COUNTY	SHEET NO.	TOTAL SHEETS
W. V.	9	S345-3372-2-54 (88)	NFA-2417 (8250)	2020	DODDRIDGE	81	




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SCALE: NOT TO SCALE

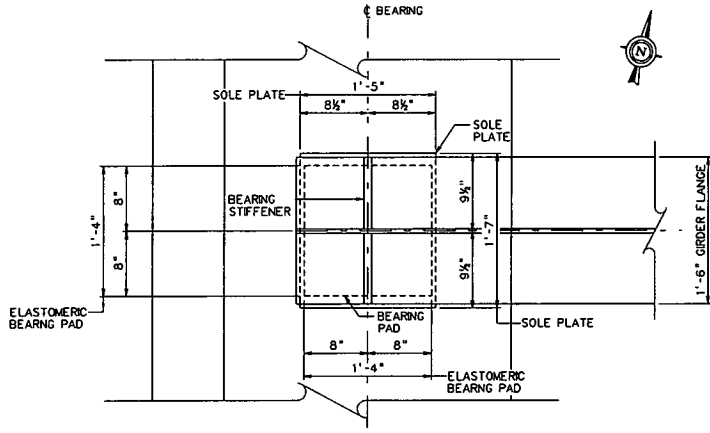


**PLAN**  
BEARING PAD  
SCALE: NOT TO SCALE

**NOTES:**


- ELASTOMER IN ALL BEARINGS SHALL HAVE A SHEAR MODULUS G = 0.165 KSI AT 73°F.
- DUROMETER 60 (HARDNESS) NEOPRENE SHALL BE USED FOR ELASTOMERIC PAD.
- PROVIDE STRUCTURAL STEEL CONFORMING TO AASHTO M270 GRADE 50 (UNLESS NOTED).
- PROVIDE STEEL CONFORMING TO ASTM A101, GRADE 50 FOR THE BONDED STEEL PLATE IN ACCORDANCE WITH AASHTO SECTION 14.5.2.
- BEARINGS SHALL BE SUBJECT TO TESTING REQUIREMENTS IN ACCORDANCE WITH AASHTO, LRFD CONSTRUCTION SPECIFICATION SECTION 1B, CORRESPONDING TO DESIGN METHOD A.
- INSTALL BEAMS AND BEARINGS TO ENSURE FULL CONTACT WITH BEARING SURFACES. IF FULL CONTACT IS NOT ACHIEVED AFTER THE DECK IS IN PLACE, FIELD ADJUSTMENTS OR MODIFICATIONS WILL BE MADE BY THE CONTRACTOR TO ENSURE FULL CONTACT AND IS SUBJECT TO THE APPROVAL OF THE ENGINEER.
- TOLERANCES: INDIVIDUAL ELASTOMER LAYER THICKNESS: +20% OF DESIGN VALUE (NOT TO EXCEED +1/8")  
 PLAN DIMENSIONS -0. +1/8"  
 DESIGN THICKNESS -0. +1/8"  
 EDGE COVER OF EMBEDDED LAMINATES -0. +1/2"
- STEEL TROWEL FINISH BEARING SEATS ON ABUTMENT TO TRUE PLANES AND ELEVATIONS. THE FLATNESS OF THE FINISHED SURFACE SHALL NOT VARY FROM A STRAIGHT EDGE LAID ON THE SURFACE IN ANY DIRECTION WITHIN THE LIMITS OF THE MASONRY PLATE BY MORE THAN 1/8". GRIND SURFACES THAT FAIL TO CONFORM TO THE REQUIRED FLATNESS UNIT ACCEPTABLE.
- CAUTION SHALL BE EXERCISED WHERE A FIELD WELD OR SHOP WELD WILL BE MADE WHILE ELASTOMERIC BEARING PAD IS IN CONTACT WITH METAL. IN NO CASE SHALL THE ELASTOMERIC PAD BE EXPOSED TO INSTANTANEOUS TEMPERATURES GREATER THAN 400° FAHRENHEIT.
- EPOXY/GRIT COATING SHALL BE APPLIED TO THE BOTTOM SURFACE OF THE SOLE PLATE AND TO THE TOP SURFACE OF THE CONCRETE THAT IS IN CONTACT WITH THE ELASTOMERIC PAD, PLUS AN ADDITIONAL 1/2" IN ALL DIRECTIONS. SEE SPECIAL PROVISIONS FOR ADDITIONAL DETAILS.
- THE ENTIRE SOLE PLATE SHALL BE HOT-DIP GALVANIZED IN ACCORDANCE WITH AASHTO M11. PAINT EXPOSED STEEL PORTIONS OF THE BEARING AFTER GALVANIZING. THE COLOR OF THE FINAL TOP COAT SHALL MATCH THE COLOR OF THE WEATHERING STEEL.
- SIDES OF THE SOLE PLATE THAT ARE NOT WELDED SHALL BE CAULKED WITH A MATERIAL MATCHING THE COLOR OF THE WEATHERING STEEL.

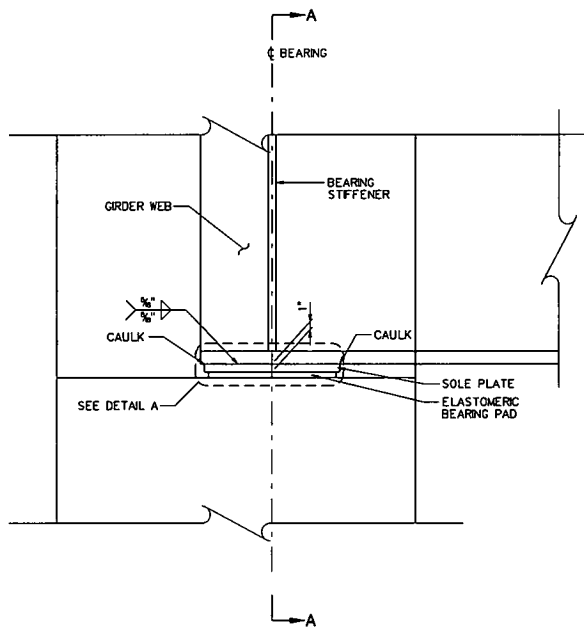

**TYPICAL SECTION**  
SCALE: NOT TO SCALE

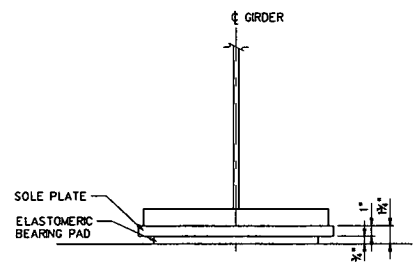

**SECTION A-A**  
SCALE: NOT TO SCALE

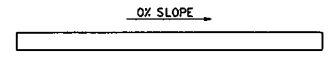

**DETAIL A**  
SCALE: NOT TO SCALE

REVISION NUMBER	SHEET NUMBER	REVISION	DATE	BY

DODDRIDGE COUNTY  
BOARD OF EDUCATION

**DODDRIDGE COUNTY  
PRE-K  
ACCESS BRIDGE**

<b>ABUTMENT 1 AND 2 BEARING DETAILS</b>	SHEET B- OF B- 53 BRIDGE NO. <b>1797.2</b>
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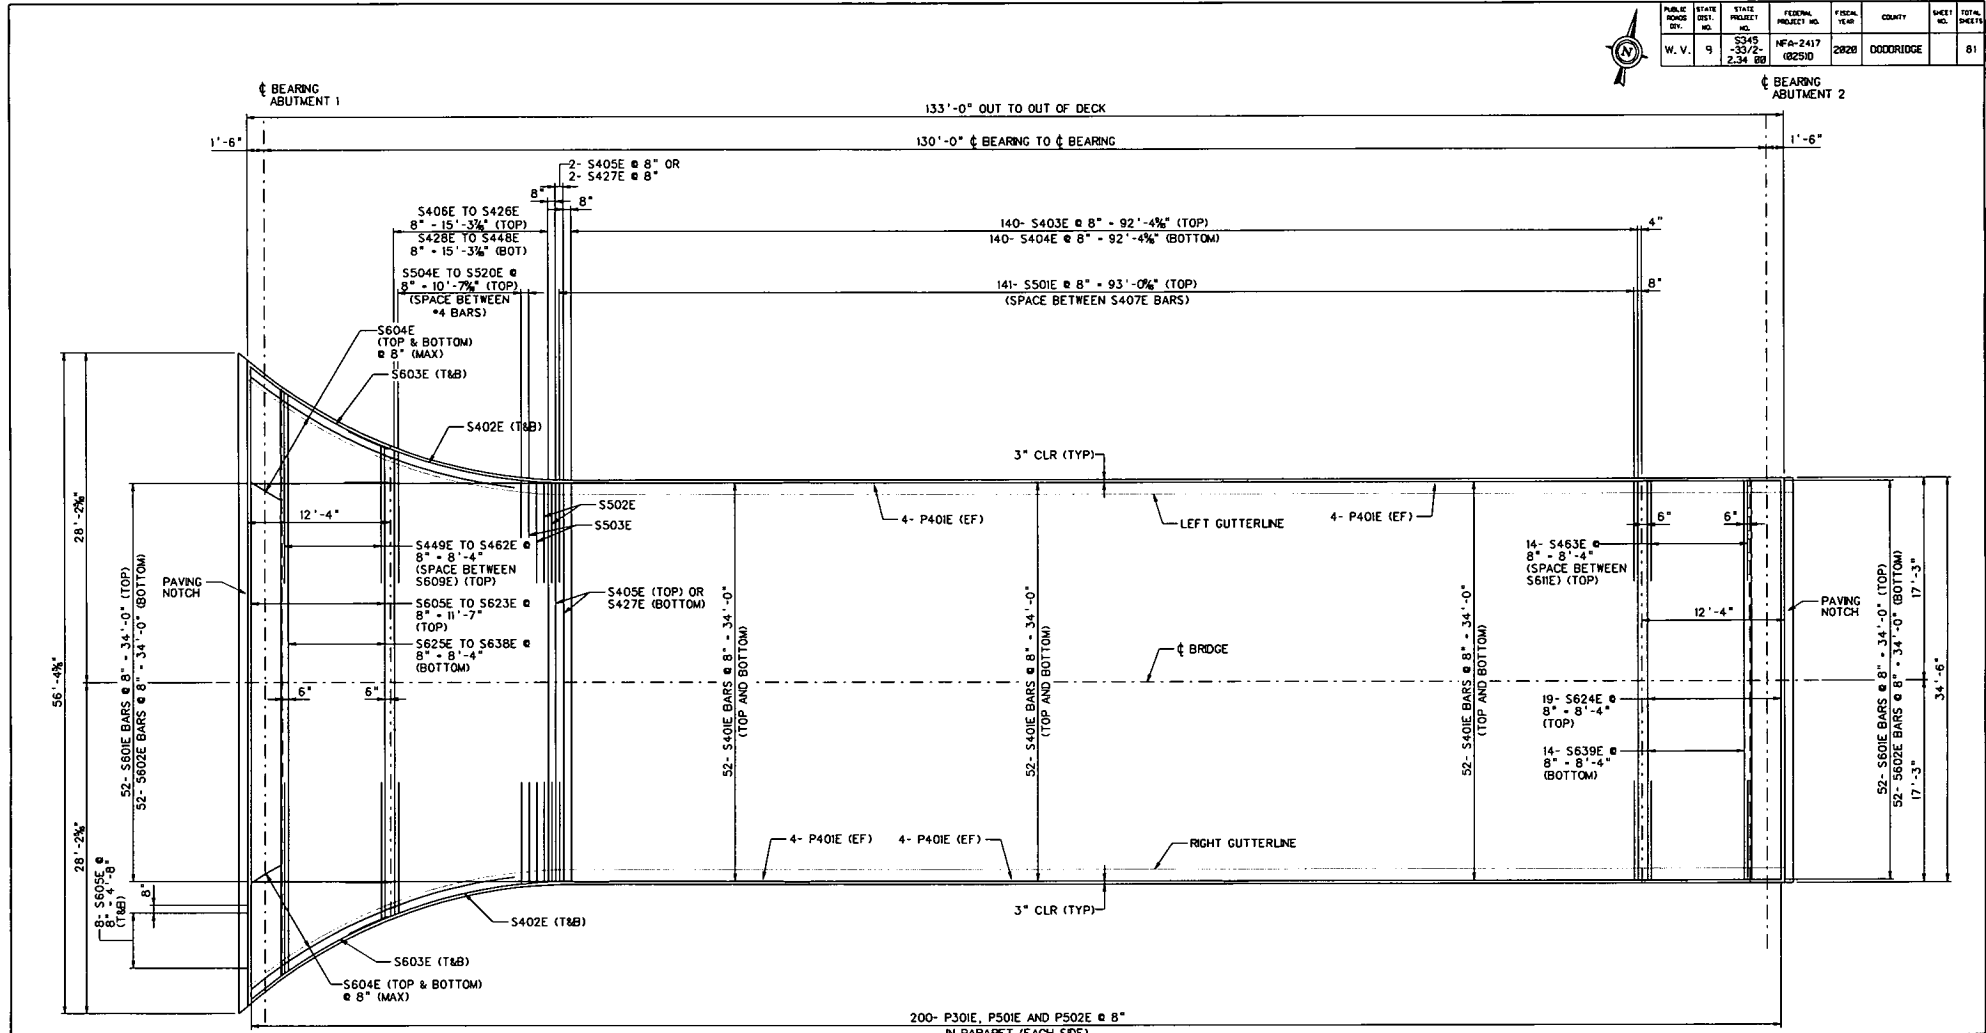
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RCM	06/20
CHECKED	DATE
CHECKED	DATE



PUBLIC WORKS DIST.	STATE DIST. NO.	STATE PROJECT NO.	FEDERAL PROJECT NO.	FISCAL YEAR	COUNTY	SHEET NO.	TOTAL SHEETS
W. V. 9		S345 233/2 2.34 EB	NFA-2417 (B2510)	2020	DODDRIDGE		81



200- P301E, P501E AND P502E @ 8"  
IN PARAPET (EACH SIDE)

**DECK PLAN**  
SCALE: 3/8" = 1'-0"

REVISION NUMBER	SHEET NUMBER	REVISION	DATE	BY
		DODDRIDGE COUNTY BOARD OF EDUCATION		
<b>DODDRIDGE COUNTY PRE-K ACCESS BRIDGE</b>				
<b>DECK SLAB PLAN</b>				SHEET NO. OF B-53
<b>PLAN</b>				<b>1797.2</b>

**THRASHER**


300 ASSOCIATION DRIVE  
CHARLESTON, WV 25311  
www.thrashergrp.com

PHONE: (304)343-7801      FAX: (304)343-7804


DESIGNED	DATE
RLC	06/20
DRAWN	DATE
SBW	06/20
CHECKED	DATE



PUBLIC WORKS DIST.	STATE DIST. NO.	STATE PROJECT NO.	FEDERAL PROJECT NO.	FISCAL YEAR	COUNTY	SHEET NO.	TOTAL SHEETS
W. V.	9	S345-33/2-2.34 (B)	IFA-2417 (025K)	2020	DODDRIDGE	81	81

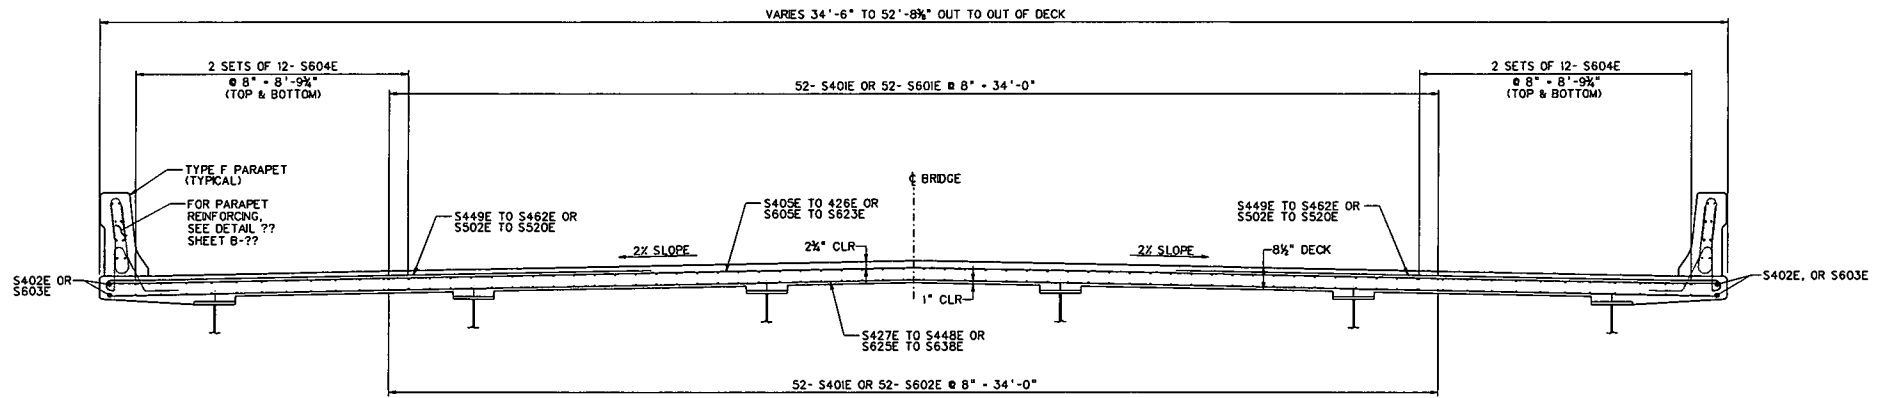

**TYPICAL SECTION AT ABUTMENT 1 END**  
(LOOKING AHEAD STATION)  
SCALE: 1/4" = 1'-0"

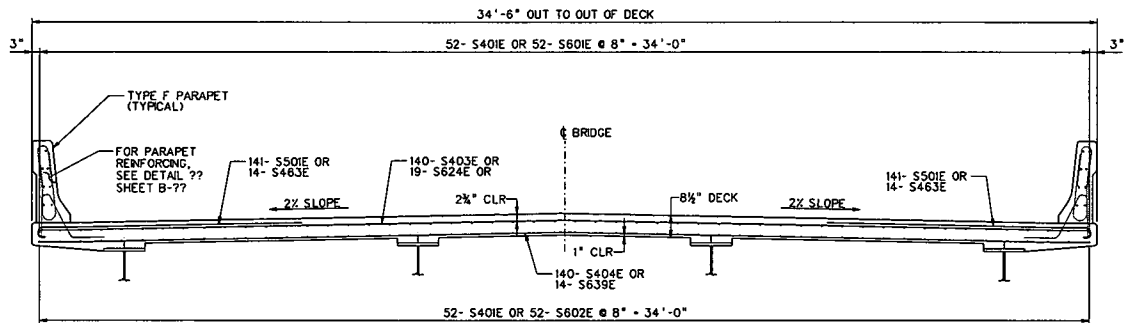

**TYPICAL SECTION AT ABUTMENT 2 END**  
(LOOKING AHEAD STATION)  
SCALE: 1/4" = 1'-0"

REVISION NUMBER	SHEET NUMBER	REVISION	DATE	BY
DODDRIDGE COUNTY BOARD OF EDUCATION				
<b>DODDRIDGE COUNTY PRE-K ACCESS BRIDGE</b>				
<b>DECK REINFORCING TYPICAL SECTIONS</b>				SHEET B- OF B- 53
				BRIDGE NO. 1797.2


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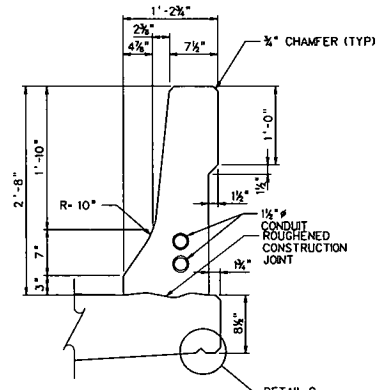
DESIGNED	DATE
RLC	08/20
DRAWN	DATE
SDM	08/20
CHECKED	
CHECKED	

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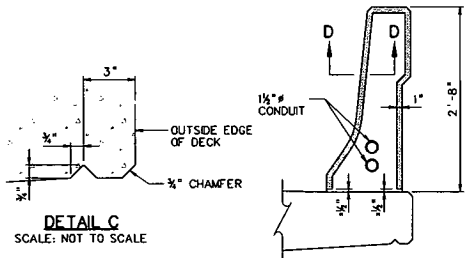
PUBLIC WORK DIST.	STATE DIST.	STATE PROJECT NO.	FEDERAL PROJECT NO.	FISCAL YEAR	COUNTY	SHEET NO.	TOTAL SHEETS
W. V.	9	5345-33/2-2.34 BB	NFA-2417 1025D	2020	DODDRIDGE	260	81




**DETAIL A**  
SCALE: NOT TO SCALE

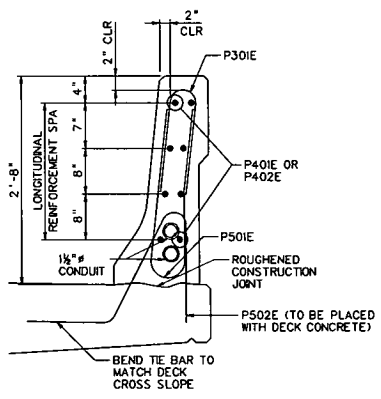

**DETAIL B**  
SCALE: NOT TO SCALE




**DETAIL C**  
SCALE: NOT TO SCALE

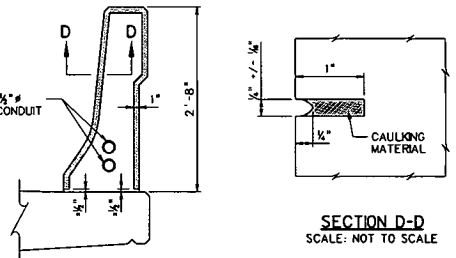


**SECTION D-D**  
SCALE: NOT TO SCALE


**CONTROL JOINTS**  
SCALE: NOT TO SCALE  
(SEE NOTES)  
-UNSEALED

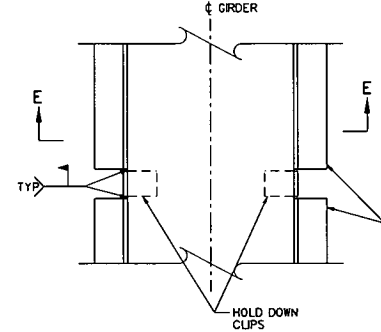


**STAY IN PLACE FORM PLAN**  
SCALE: NOT TO SCALE

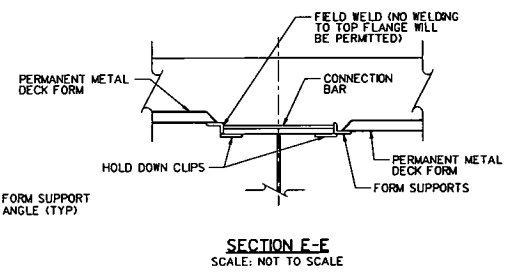

**SECTION E-E**  
SCALE: NOT TO SCALE

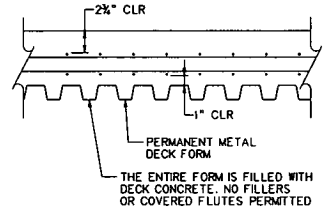


**STAY IN PLACE FORM DETAIL**  
SCALE: NOT TO SCALE

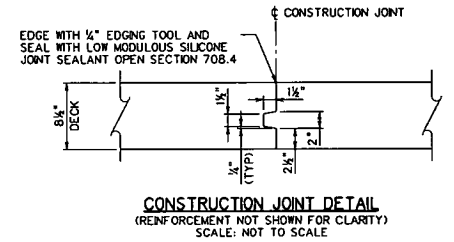

**CONSTRUCTION JOINT DETAIL**  
(REINFORCEMENT NOT SHOWN FOR CLARITY)  
SCALE: NOT TO SCALE

CONTROL JOINTS FOR CONCRETE PARAPETS:  
SAWCUT 1" DEEP CONTROL JOINTS ALONG THE PERIMETER OF THE PARAPET AS SOON AS THE SAW CAN BE OPERATED WITHOUT DAMAGING THE CONCRETE.  
USE AN EDGE GUIDE, FENCE OR JIG TO ENSURE THAT THE CUT JOINT IS STRAIGHT, TRUE AND ALIGNED ON ALL FACES OF THE PARAPET. THE JOINT WIDTH SHALL BE THE WIDTH OF THE SAW BLADE, A NOMINAL WIDTH OF 1/4".  
PLACE CONTROL JOINTS AT A MAXIMUM OF 20'-0" IN BETWEEN.  
SEAL THE PERIMETER OF THE CONTROL JOINT TO A MINIMUM DEPTH OF ONE INCH WITH A POLYURETHANE OR POLYMERIC MATERIAL CONFORMING TO ASTM C920, TYPE S. LEAVE THE BOTTOM 1/2" OF BOTH THE INSIDE AND OUTSIDE FACES OF THE PARAPET UNSEALED TO ALLOW ANY WATER WHICH MAY ENTER THE JOINT TO ESCAPE.

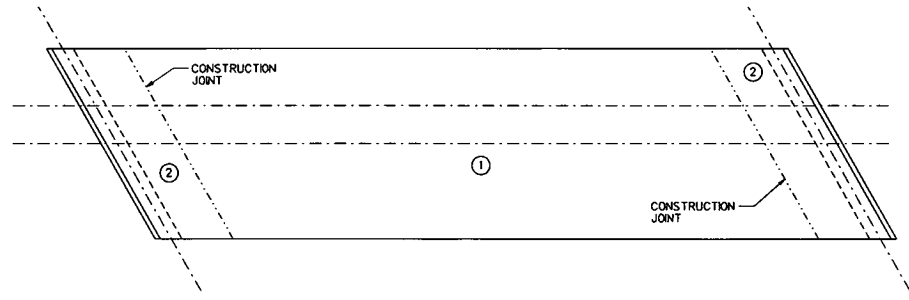

**POURING SEQUENCE**  
SCALE: NOT TO SCALE

- POURING NOTES:**
- ALL CONCRETE PLACEMENTS MARKED ① SHALL BE PLACED IN NUMERICAL SEQUENCE SHOWN.
  - THE ADJACENT PREVIOUS PLACEMENT SHALL OBTAIN A MINIMUM OF 2000 PSI BEFORE THE NEXT PLACEMENT IS MADE.

REVISION NUMBER	SHEET NUMBER	REVISION	DATE	BY

**DODDRIDGE COUNTY BOARD OF EDUCATION**  
**DODDRIDGE COUNTY PRE-K ACCESS BRIDGE**

**DECK DETAILS**

SHEET  
B-34 OF B-53  
BRIDGE NO.  
**1797.2**

**THRASHER**  
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DESIGNED	DATE
RLC	08/20
DRAWN	DATE
SM	08/20
CHECKED	DATE



**TOP OF DECK ELEVATIONS**


ABUT 1 CL BRG	SPAN 1									ABUT 2 CL BRG	
	0.1	0.2	0.3	0.4	0.5	0.6	0.7	0.8	0.9		
LEFT FASCIA	785.88	785.94	785.92	785.86	785.79	785.73	785.66	785.60	785.53	785.47	785.40
LEFT GUTTER	785.88	785.94	785.92	785.86	785.79	785.73	785.66	785.60	785.53	785.47	785.40
GIRDER A	785.92	785.95									
GIRDER B	786.09	786.02	785.96	785.89	785.83	785.76	785.70	785.63	785.57	785.50	785.44
GIRDER C	786.28	786.21	786.15	786.08	786.02	785.95	785.89	785.82	785.76	785.69	785.63
CENTERLINE	786.37	786.31	786.24	786.18	786.11	786.05	785.98	785.92	785.85	785.79	785.72
GIRDER D	786.28	786.21	786.15	786.08	786.02	785.95	785.89	785.82	785.76	785.69	785.63
GIRDER E	786.09	786.02	785.96	785.89	785.83	785.76	785.70	785.63	785.57	785.50	785.44
GIRDER F	785.92	785.95									
RIGHT GUTTER	785.88	785.94	785.92	785.86	785.79	785.73	785.66	785.60	785.53	785.47	785.40
RIGHT FASCIA	785.88	785.94	785.92	785.86	785.79	785.73	785.66	785.60	785.53	785.47	785.40

\* All tenth points are taken perpendicular to the centerline of the bridge.


PUBLIC WORKS DIST.	STATE DIST. NO.	STATE PROJECT NO.	FEDERAL PROJECT NO.	FISCAL YEAR	COUNTY	SHEET NO.	TOTAL SHEETS
W. V.	9	5345-33/2-2.34.88	WF 6-2417 (0250)	2020	DODDRIDGE		81

**NOTES:**


- ELEVATIONS ARE MEASURED AT TENTH POINTS AND FIELD SPICE LOCATIONS ALONG EACH LONGITUDINAL ELEMENT AND GIVEN IN FEET.
- ELEVATIONS SHOWN ARE FINISHED ROADWAY (BRIDGE DECK) ELEVATIONS.
- FOR DECK CROSS SLOPE AND SUPERELEVATION TRANSITION DETAILS, SEE ROADWAY PLANS.
- AFTER ALL GIRDERS HAVE BEEN ERECTED AND FALSE WORK REMOVED, THE CONTRACTOR SHALL TAKE ELEVATIONS ALONG TOP OF THE GIRDER AT POINTS WHERE THE DECK ELEVATIONS ARE SHOWN. THE DIFFERENCE BETWEEN THESE ELEVATIONS AND THE DECK ELEVATIONS, PLUS THE SUM OF THE DECK AND BARRIER CONCRETE DEAD LOAD DEFLECTIONS WILL BE THE FINISHED THICKNESS OF THE DECK. THE MINIMUM TOTAL DECK THICKNESS (T) OVER THE GIRDERS SHALL NOT BE LESS THAN 12 1/4" - (TOP FLANGE THICKNESS) AT THE CENTER OF THE WEB. IF THE GIRDER HAS EXCESSIVE CAMBER AND THE MINIMUM CANNOT BE OBTAINED, THE ROADWAY GRADE SHALL BE ADJUSTED TO OBTAIN THIS THICKNESS.

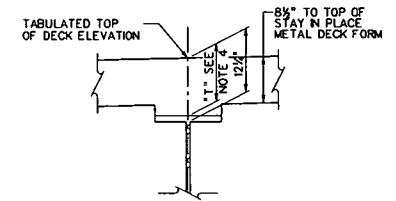

**HAUNCH DETAIL**  
SCALE: NOT TO SCALE

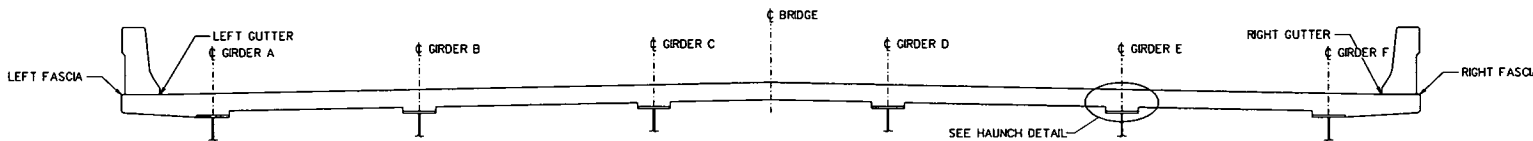

**TYPICAL SECTION AT ABUTMENT 1**  
(LOOKING AHEAD STATION)  
SCALE: NOT TO SCALE

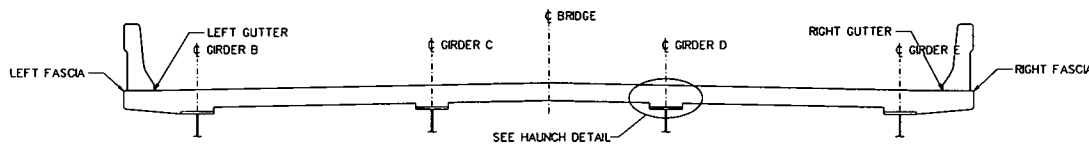

**TYPICAL SECTION AT ABUTMENT 2**  
(LOOKING AHEAD STATION)  
SCALE: NOT TO SCALE

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DESIGNED	DATE
FILE	09/20
DRAWN	
CHKD	
CHECKED	

REVISION NUMBER	SHEET NUMBER	REVISION	DATE	BY


DODDRIDGE COUNTY BOARD OF EDUCATION

**DODDRIDGE COUNTY PRE-K ACCESS BRIDGE**


DECK ELEVATIONS AND DEFLECTIONS

SHEET B- OF B- 53  
BRIDGE NO. 1797.2

PUBLIC WORKS DIV.	STATE DIST. NO.	STATE PROJECT NO.	FEDERAL PROJECT NO.	FISCAL YEAR	COUNTY	SHEET NO.	TOTAL SHEETS
W. V.	9	5345-33/2-2-54-88	HF-2417 (0250)	2026	DODDRIDGE	81	

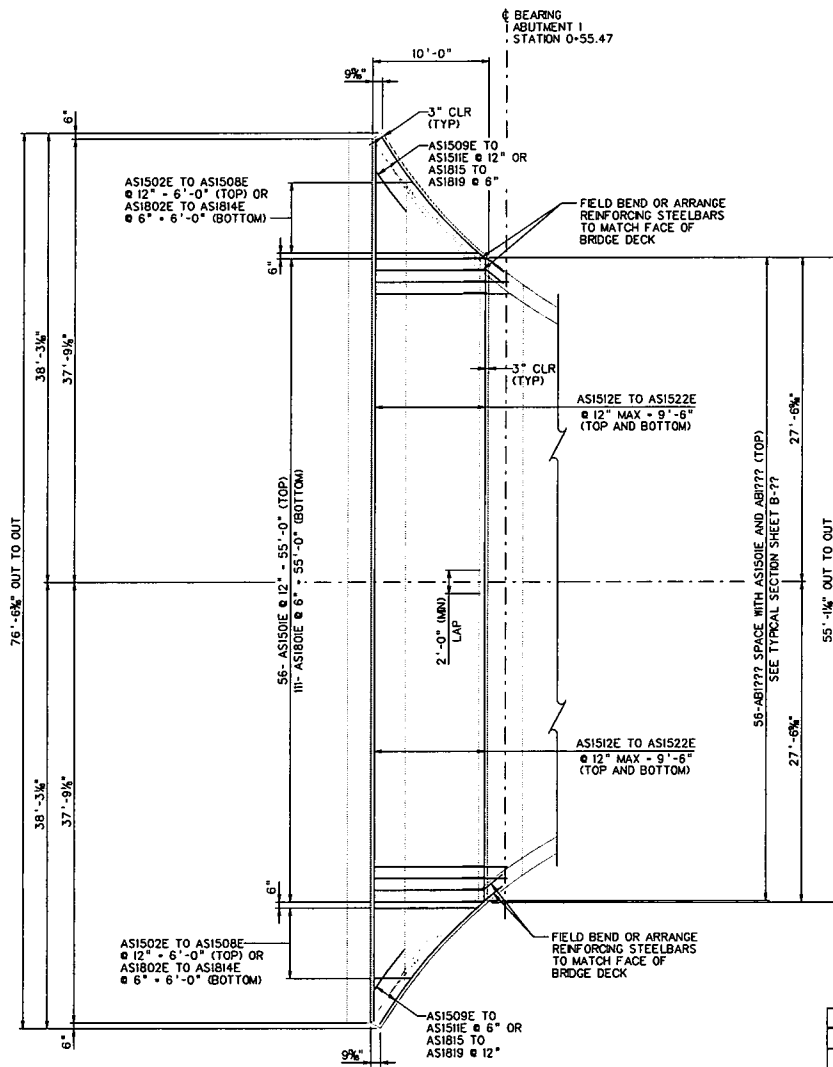

**APPROACH SLAB ABUTMENT 1**  
SCALE: 3/8" = 1'-0"

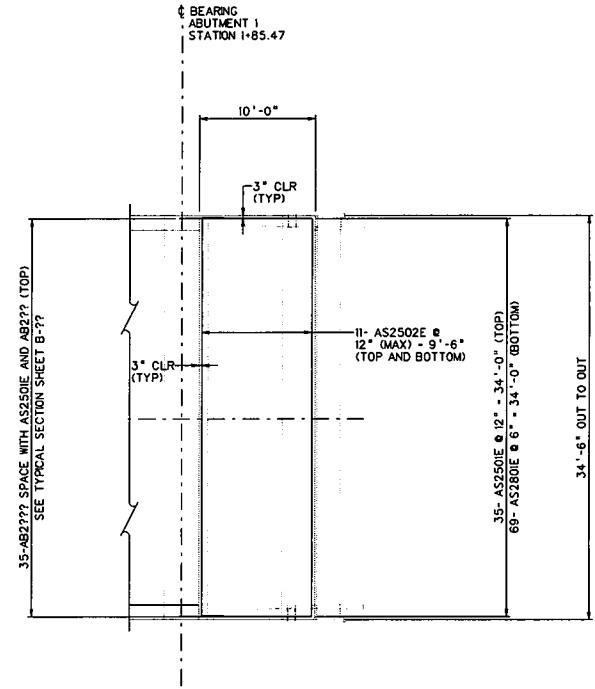

**APPROACH SLAB ABUTMENT 2**  
SCALE: 3/8" = 1'-0"

APPROACH SLAB QUANTITIES					
ITEM NUMBER	DESCRIPTION	UNITS	ABUTMENT 1	ABUTMENT 2	TOTAL
502001-012	12" PORTLAND CEMENT CONC. APPR. SLAB	SY	73	39	112
*	REINFORCEMENT STEEL BARS (EPOXY)	LB	5676	2879	8555
*	CLASS B CONCRETE	CY	25	13	38

\*ITEM IS INCIDENTAL TO 502001-012

- NOTES:**
- FOR REINFORCING SCHEDULE AND NOTES, SEE SHEET B-??.
  - FOR APPROACH BARRIER DETAILS, SEE SHEET B-??.
  - FOR SLEEPER SLAB DETAILS, SEE SHEET B-??.

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DESIGNED	DATE
RLC	06/20
DRAWN	
BCM	06/20
CHECKED	
CHECKED	

REVISION NUMBER	SHEET NUMBER	REVISION	DATE	BY

DODDRIDGE COUNTY  
BOARD OF EDUCATION


**DODDRIDGE COUNTY  
PRE-K  
ACCESS BRIDGE**

**APPROACH SLAB  
PLAN**

SHEET 8 OF B-53  
BRIDGE NO. 1797.2

PUBLIC BOND DIST.	STATE DIST. NO.	STATE PROJECT NO.	FEDERAL PROJECT NO.	FISCAL YEAR	COUNTY	SHEET NO.	TOTAL SHEETS
W. V.	9	5345-33/2-2-34 88	NFA-2417 (825)D	2020	DODDRIDGE		81

APPROACH SLAB ABUTMENT 1										
MARK	No.	LENGTH	WEIGHT (lb)		TYPE	A	B	C	D	G
			UNCOATED	EPOXY COATED						
AS1501E	56	9' - 6"		555	STR					
AS1502E	2	8' - 10"		19	STR					
AS1503E	2	7' - 9"		17	STR					
AS1504E	2	6' - 9"		15	STR					
AS1505E	2	5' - 9"		12	STR					
AS1506E	2	4' - 11"		11	STR					
AS1507E	2	4' - 0"		9	STR					
AS1508E	2	3' - 3"		7	STR					
AS1509E	2	13' - 11"		30	20	13'-11"				44'-0"
AS1510E	2	6' - 8"		14	20	6'-8"				45'-0"
AS1511E	2	4' - 5"		10	20	4'-5"				46'-0"
AS1512E	4	28' - 6"		119	STR					
AS1513E	4	29' - 3"		123	STR					
AS1514E	4	30' - 2"		126	STR					
AS1515E	4	31' - 1"		130	STR					
AS1516E	4	32' - 1"		134	STR					
AS1517E	4	33' - 2"		139	STR					
AS1518E	4	34' - 3"		143	STR					
AS1519E	4	35' - 6"		149	STR					
AS1520E	4	36' - 9"		154	STR					
AS1521E	4	38' - 3"		160	STR					
AS1522E	4	38' - 9"		162	STR					
AS1801E	111	9' - 6"		2816	STR					
AS1802E	2	8' - 10"		48	STR					
AS1803E	2	8' - 4"		45	STR					
AS1804E	2	7' - 9"		42	STR					
AS1805E	2	7' - 3"		39	STR					
AS1806E	2	6' - 9"		37	STR					
AS1807E	2	6' - 3"		34	STR					
AS1808E	2	5' - 9"		31	STR					
AS1809E	2	5' - 4"		29	STR					
AS1810E	2	4' - 11"		27	STR					
AS1811E	2	4' - 5"		24	STR					
AS1812E	2	4' - 0"		22	STR					
AS1813E	2	3' - 8"		20	STR					
AS1814E	2	3' - 3"		18	STR					
AS1815E	2	13' - 11"		75	20	13'-11"				44'-0"
AS1816E	2	7' - 8"		41	20	7'-8"				44'-6"
AS1817E	2	6' - 8"		36	20	6'-8"				45'-0"
AS1818E	2	5' - 6"		30	20	5'-6"				45'-6"
AS1819E	2	4' - 5"		24	20	4'-5"				46'-0"

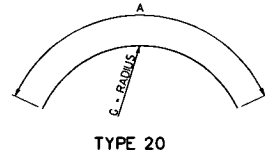

TOTAL APPROACH SLAB AT ABUTMENT 1 0 LB UNCOATED AND 5676 LB EPOXY COATED REINFORCING STEEL BARS.

APPROACH SLAB ABUTMENT 2										
MARK	No.	LENGTH	WEIGHT (lb)		TYPE	A	B	C	D	G
			UNCOATED	EPOXY COATED						
AS2501E	35	9' - 6"		347	STR					
AS2502E	22	34' - 0"		781	STR					
AS2801E	69	9' - 6"		1751	STR					

TOTAL APPROACH SLAB AT ABUTMENT 2 0 LB UNCOATED AND 2879 LB EPOXY COATED REINFORCING STEEL BARS.

TOTAL FOR APPROACH SLABS AT ABUTMENT 1 AND ABUTMENT 2 0 LB UNCOATED AND 8555 LB EPOXY COATED REINFORCING STEEL BARS.


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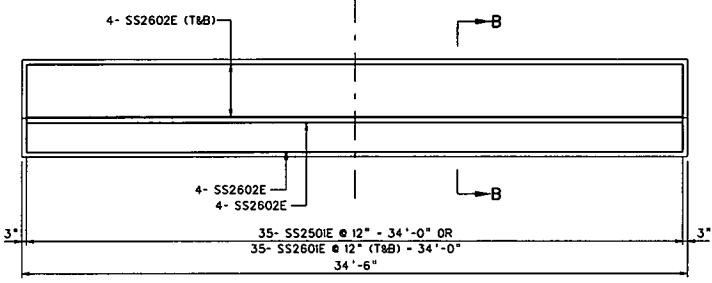
DESIGNED	DATE
FILE	09/20
DRAWN	
SDH	09/20
CHECKED	

REVISION NUMBER	SHEET NUMBER	REVISION	DATE	BY
DODDRIDGE COUNTY BOARD OF EDUCATION				
<b>DODDRIDGE COUNTY PRE-K ACCESS BRIDGE</b>				
<b>APPROACH SLAB REINFORCING SCHEDULE</b>				SHEET B- OF B-53 BRIDGE NO. 1797.2


PUBLIC WORKS DIV.	STATE DIST. NO.	STATE PROJECT NO.	FEDERAL PROJECT NO.	FISCAL YEAR	COUNTY	SHEET NO.	TOTAL SHEETS
W. V.	9	S348-33/2-2.34 (B)	MF0-2417 (B25D)	2020	DODDRIDGE	81	




**SLEEPER SLAB ABUTMENT 1**  
SCALE: NOT TO SCALE

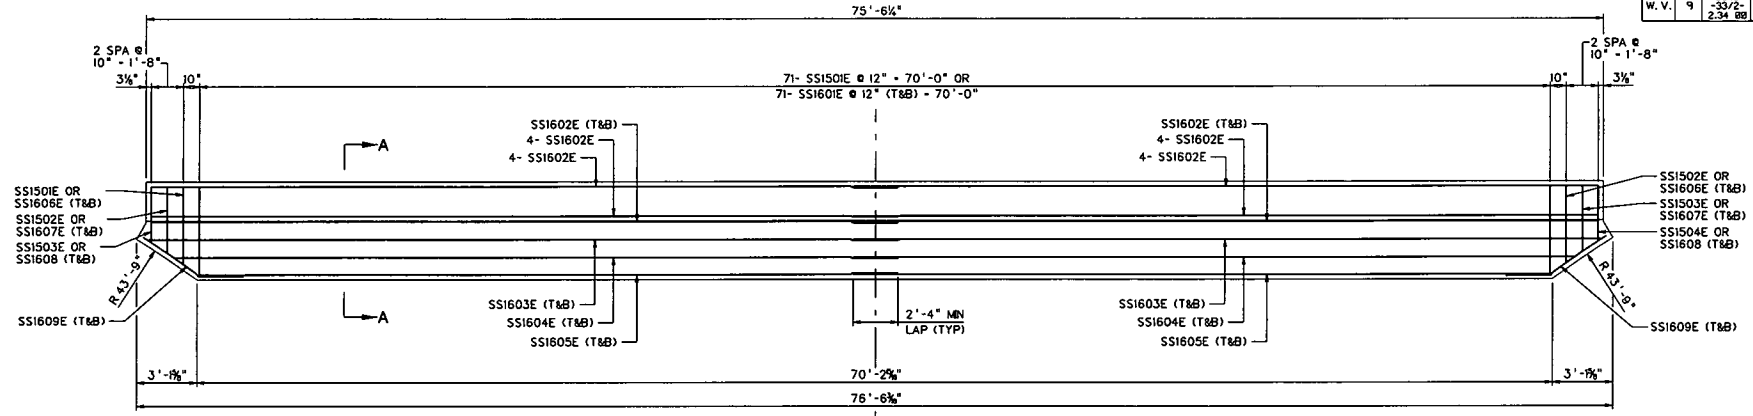

**SLEEPER SLAB ABUTMENT 2**  
SCALE: NOT TO SCALE

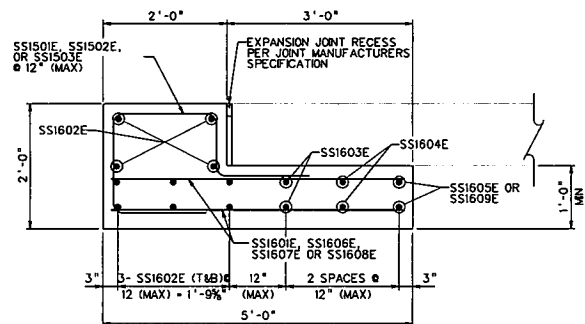

**SECTION A-A**  
SCALE: 1" = 1'-0"

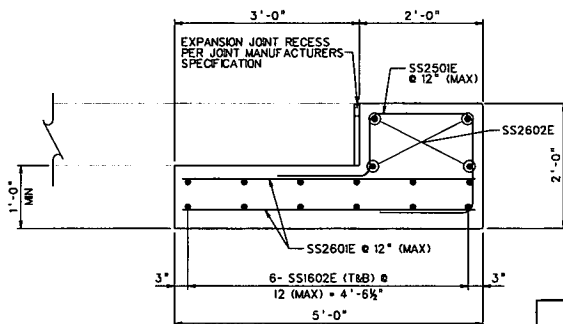

**SECTION B-B**  
SCALE: 1" = 1'-0"

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DESIGNED	DATE
RLC	06/20
DRAWN	
SDM	06/20
CHECKED	
CHECKED	

REVISION NUMBER	SHEET NUMBER	REVISION	DATE	BY
DODDRIDGE COUNTY BOARD OF EDUCATION				
<b>DODDRIDGE COUNTY PRE-K ACCESS BRIDGE</b>				
<b>SLEEPER SLAB PLAN</b>				SHEET B- OF B- 53
<b>1797.2</b>				BRIDGE NO.

PUBLIC ROAD DIST.	STATE DIST. NO.	STATE PROJECT NO.	FEDERAL PROJECT NO.	FISCAL YEAR	COUNTY	SHEET NO.	TOTAL SHEETS
W. V.	9	SS345-33/2-2.34 BB	NFA-2417 (B25)D	2020	DODDRIDGE		61

**SLEEPER SLAB ABUTMENT 1**

MARK	No.	LENGTH	WEIGHT (lb)		TYPE	A	B	C	D	E	G
			UNCOATED	EPOXY COATED							
SS1501E	73	7' - 4"		559	5	1'-10"	1'-0"	1'-6"	1'-6"	1'-6"	
SS1502E	2	7' - 2"		15	5	1'-10"	1'-0"	1'-6"	1'-6"	1'-4"	
SS1503E	2	6' - 11"		15	5	1'-10"	1'-0"	1'-6"	1'-6"	1'-1"	
SS1601E	142	4' - 6"		960	STR						
SS1602E	20	38' - 9"		1165	STR						
SS1603E	4	38' - 11"		234	STR						
SS1604E	4	37' - 6"		226	STR						
SS1605E	4	36' - 3"		218	STR						
SS1606E	4	3' - 11"		24	STR						
SS1607E	4	3' - 5"		21	STR						
SS1608E	4	2' - 10"		18	STR						
SS1609E	4	5' - 10"		36	19	3'-6"	2'-4"	144.79'			

TOTAL SLEEPER SLAB AT ABUTMENT 1 0 LB UNCOATED AND 3491 LB EPOXY COATED REINFORCING STEEL BARS.

**SLEEPER SLAB ABUTMENT 2**


MARK	No.	LENGTH	WEIGHT (lb)		TYPE	A	B	C	E	D	G
			UNCOATED	EPOXY COATED							
SS2501E	35	7' - 4"		268	5	1'-10"	1'-0"	1'-6"	1'-6"	1'-6"	
SS2601E	70	4' - 6"		474	STR						
SS2602E	15	34' - 0"		818	STR						

TOTAL SLEEPER SLAB AT ABUTMENT 2 0 LB UNCOATED AND 1560 LB EPOXY COATED REINFORCING STEEL BARS.


TOTAL FOR SLEEPER SLABS AT ABUTMENT 1 AND ABUTMENT 2 0 LB UNCOATED AND 5051 LB EPOXY COATED REINFORCING STEEL BARS.

**SLEEPER SLAB QUANTITIES**

DESCRIPTION	UNITS	ABUTMENT 1	ABUTMENT 2	TOTAL
CONCRETE	CY	20	10	30
EXPANSION JOINT	LF	76	35	111

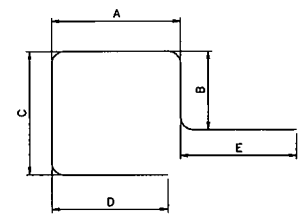

TYPE 5

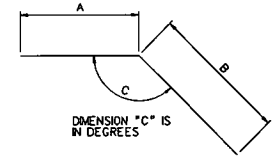

TYPE 19

DESIGNED	DATE	
FILED	08/20	
DRAWN		
SDM	08/20	
CHECKED		
CHECKED		

REVISION SHEET NUMBER | REVISION | DATE | BY

DODDRIDGE COUNTY BOARD OF EDUCATION

**DODDRIDGE COUNTY PRE-K ACCESS BRIDGE**

SLEEPER SLAB REINFORCING SCHEDULE

SHEET B-53 OF B-53  
BRIDGE NO. 1797.2


**THRASHER**

300 ASSOCIATION DRIVE  
CHARLESTON, WV 25311  
www.thrashergroup.com

PHONE (304)343-7801 FAX (304)343-7804




PUBLIC WORKS DIV.	STATE DIST. NO.	STATE PROJECT NO.	FEDERAL PROJECT NO.	FISCAL YEAR	COUNTY	SHEET NO.	TOTAL SHEETS
W. V.	9	S345-3372-2.34 (88)	MF-A-2417 (8250)	2020	DODDRIDGE	81	

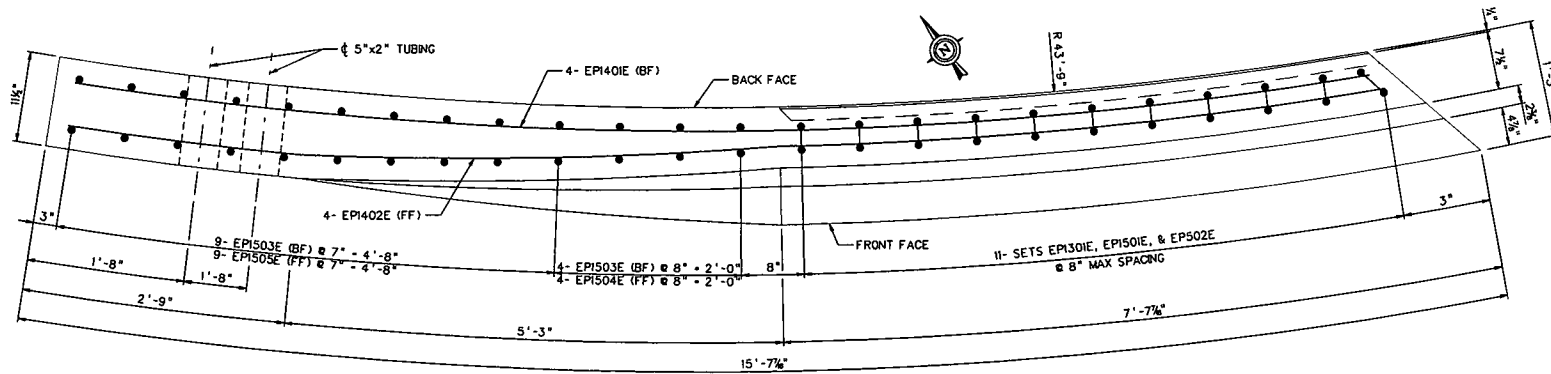


**APPROACH SLAB BARRIER PLAN**  
SCALE: 1/4" = 1'-0"


- NOTES:**
1. BARS EPI502E, EPI503E, EPI504E AND EPI505E SHALL BE PLACED WITH APPROACH SLAB CONCRETE.
  2. FOR THREE BEAM CONNECTION DETAILS, SEE WVD00H STANDARD DETAILS, VOLUME 1.
  3. FIELD BEND EPI401E AND EPI402E TO MATCH FACE OF BARRIER TRANSITION.

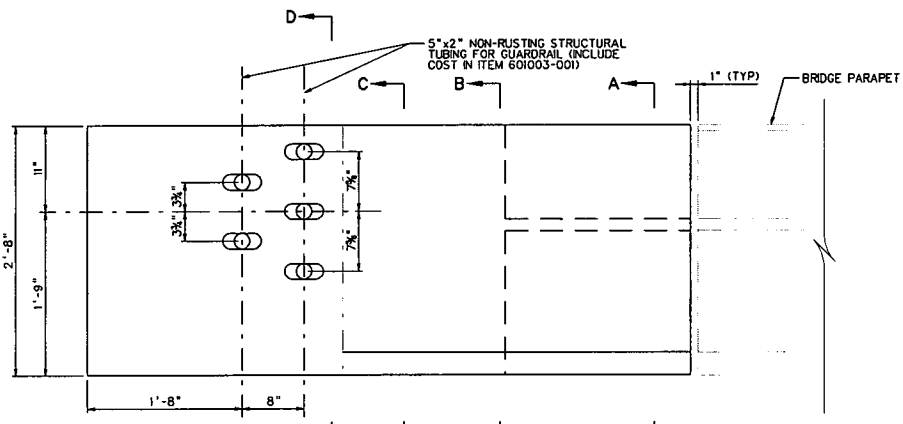


**APPROACH SLAB BARRIER ELEVATION**  
SCALE: 1/4" = 1'-0"  
(NOT TO SCALE HORIZONTALLY)

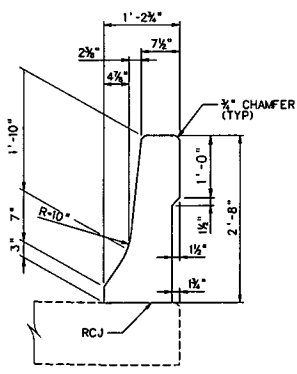


**DIMENSIONS**  
SCALE: 1" = 1'-0"

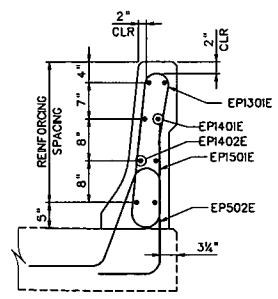


**SECTION A-A**  
SCALE: 1" = 1'-0"

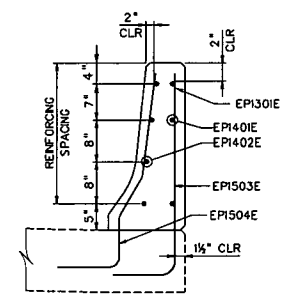


**SECTION B-B**  
SCALE: 1" = 1'-0"

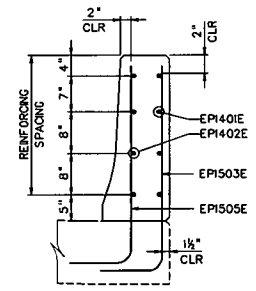

**SECTION C-C**  
SCALE: 1" = 1'-0"

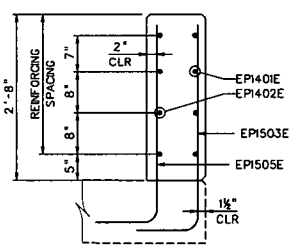

**SECTION D-D**  
SCALE: 1" = 1'-0"

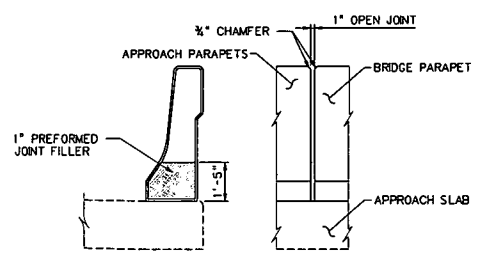

**PARAPET JOINT**  
SCALE: NOT TO SCALE


REVISION NUMBER	SHEET NUMBER	REVISION	DATE	BY
DODDRIDGE COUNTY BOARD OF EDUCATION				
<b>DODDRIDGE COUNTY PRE-K ACCESS BRIDGE</b>				
<b>BARRIER TRANSITION ABUTMENT 1</b>				SHEET B-53 OF B-53
<b>1797.2</b>				

**THRASHER**  
300 ASSOCIATION DRIVE  
CHARLESTON, WV 25311  
www.thrashereng.com


DESIGNED: RLC 06/20  
DRAWN: SCH 06/20  
CHECKED: [ ]  
CHECKED: [ ]

PHONE: (304)343-7801 FAX: (304)343-7804


PUBLIC ROAD DIST.	STATE DIST. NO.	STATE PROJECT NO.	FEDERAL PROJECT NO.	FISCAL YEAR	COUNTY	SHEET NO.	TOTAL SHEETS
W. V.	9	SS45-33/2-2.34 (BB)	AFIP-2417 (025SD)	2020	DODDRIDGE	80	81

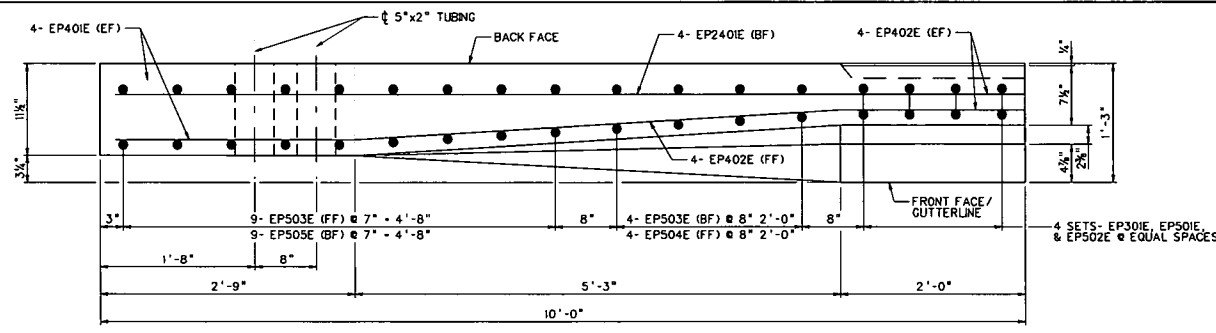


**APPROACH SLAB BARRIER PLAN**  
SCALE: 1/4" = 1'-0"

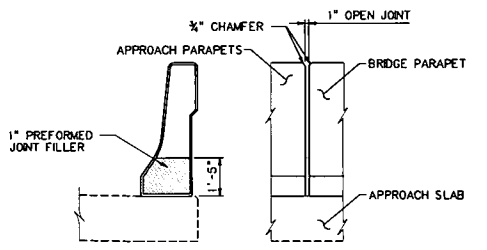


**PARAPET JOINT**  
SCALE: NOT TO SCALE

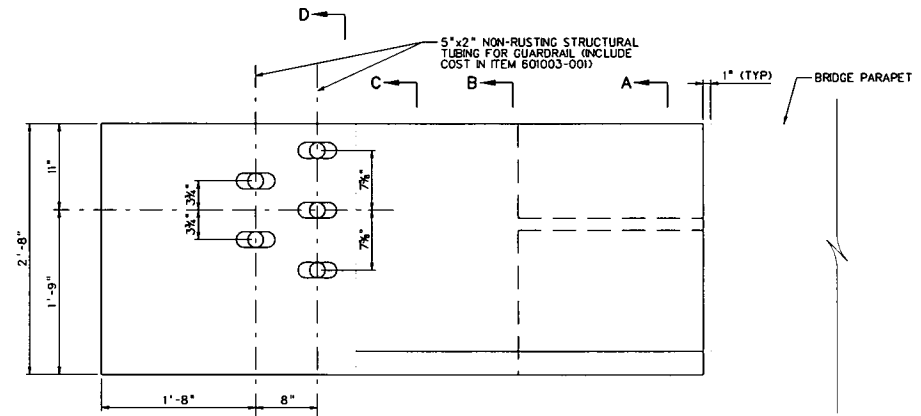


**APPROACH SLAB BARRIER ELEVATION**  
SCALE: 1/4" = 1'-0"  
(NOT TO SCALE HORIZONTALLY)

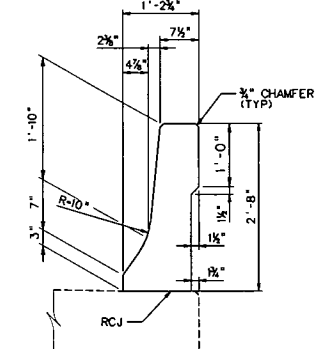


**DIMENSIONS**  
SCALE: 1" = 1'-0"

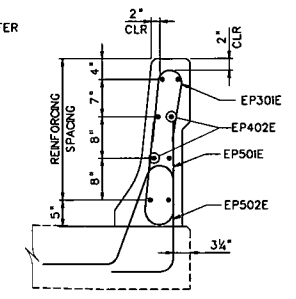


**SECTION A-A**  
SCALE: 1" = 1'-0"

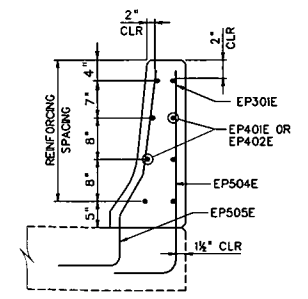

**SECTION B-B**  
SCALE: 1" = 1'-0"

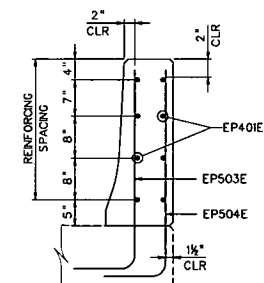

**SECTION C-C**  
SCALE: 1" = 1'-0"

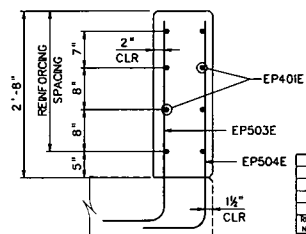

**SECTION D-D**  
SCALE: 1" = 1'-0"

**NOTE:**  
1. BARS EP502E, EP503E, EP504E AND EP505E SHALL BE PLACED WITH APPROACH SLAB CONCRETE.  
2. FOR THREE BEAM CONNECTION DETAILS, SEE NVD04H STANDARD DETAILS, VOLUME 1.

**THRASHER**  
300 ASSOCIATION DRIVE  
CHARLESTON, WV 25311  
www.thrashergrp.com  
PHONE (304)343-7801 FAX (304)343-7804


DESIGNED	DATE
FILE	08/20
DRAWN	
SDI	08/20
CHECKED	
CHECKED	

REVISION	SHEET NUMBER	REVISION	DATE	BY

**DODDRIDGE COUNTY BOARD OF EDUCATION**  
**PRE-K ACCESS BRIDGE**  
**BARRIER TRANSITION ABUTMENT 2**  
SHEET B-44 OF B-53  
BRIDGE NO. 1797.2

PUBLIC WORKS DIV.	STATE DIST. NO.	STATE PROJECT NO.	FEDERAL PROJECT NO.	FISCAL YEAR	COUNTY	SHEET NO.	TOTAL SHEETS
W. V.	9	S345-33/2-2.34.88	NFA-2417 (8250)	2020	DODDRIDGE	81	

BARRIER TRANSITION ABUTMENT 1					
MARK	No.	LENGTH	WEIGHT (lb)		TYPE
			UNCOATED	EPOXY COATED	
EP1301E	22	3' - 3"		27	BENT
EP1401E	8	14' - 1"		76	STR
EP1402E	8	14' - 4"		77	STR
EP1501E	22	4' - 9"		109	BENT
EP1502E	22	5' - 5"		125	BENT
EP1503E	26	4' - 4"		118	BENT
EP1504E	8	4' - 1"		35	BENT
EP1505E	18	4' - 2"		79	BENT
TOTAL BARRIER TRANSITION AT ABUTMENT 1 0 LB UNCOATED AND 646 LB EPOXY COATED REINFORCING STEEL BARS.					
BARRIER TRANSITION ABUTMENT 2					
MARK	No.	LENGTH	WEIGHT (lb)		TYPE
			UNCOATED	EPOXY COATED	
EP2301E	8	3' - 3"		10	BENT
EP2401E	8	9' - 10"		53	STR
EP2402E	8	9' - 11"		53	STR
EP2501E	8	4' - 9"		40	BENT
EP2502E	8	5' - 5"		46	BENT
EP2503E	26	4' - 4"		118	BENT
EP2504E	8	4' - 1"		35	BENT
EP2505E	18	4' - 2"		79	BENT
TOTAL BARRIER TRANSITION AT ABUTMENT 2 0 LB UNCOATED AND 434 LB EPOXY COATED REINFORCING STEEL BARS.					
TOTAL FOR BARRIER TRANSITION AT ABUTMENT 1 AND ABUTMENT 2 0 LB UNCOATED AND 1080 LB EPOXY COATED REINFORCING STEEL BARS.					

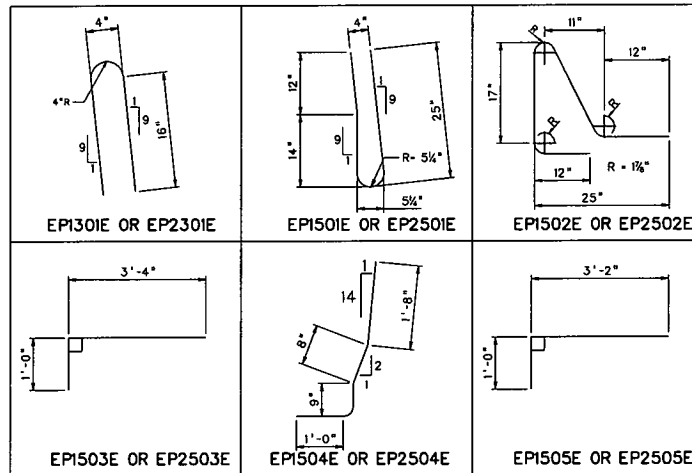

REVISION NUMBER	SHEET NUMBER	REVISION	DATE	BY
DODDRIDGE COUNTY BOARD OF EDUCATION				
<b>DODDRIDGE COUNTY PRE-K ACCESS BRIDGE</b>				
BARRIER TRANSITION REINFORCING SCHED				SHEET B-53 OF B-53
				BRIDGE NO. 1797.2


**THRASHER**  
 300 ASSOCIATION DRIVE  
 CHARLESTON, WV 25311  
 www.thrasherinc.com

PHONE (304)343-7801 FAX (304)343-7804


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RLC	08/20
DRAWN	DATE
SDH	08/20
CHECKED	
CHECKED	

24-16-10517-0000


PUBLIC ROWS	STATE DIST.	STATE PROJECT NO.	FEDERAL PROJECT NO.	FISCAL YEAR	COUNTY	SHEET NO.	TOTAL SHEETS
W. V.	9	5345-33/2-2,34	MF-A-2417 (62250)	2020	DODDRIDGE	112	81

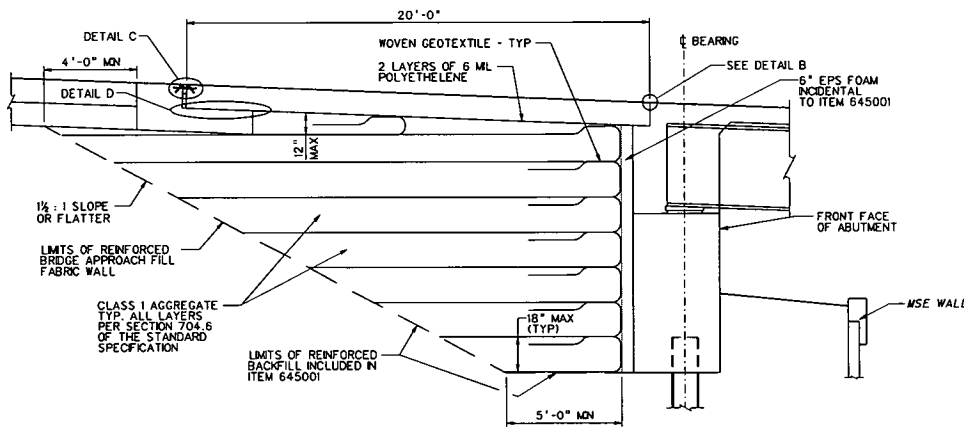


**TYPICAL**  
ABUTMENT 1 SHOWN, ABUTMENT 2 SIMILAR  
NTS

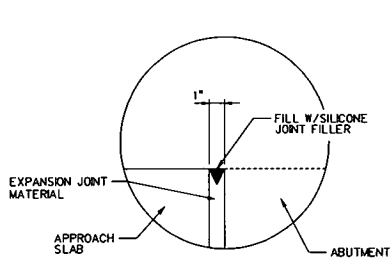


**DETAIL B**

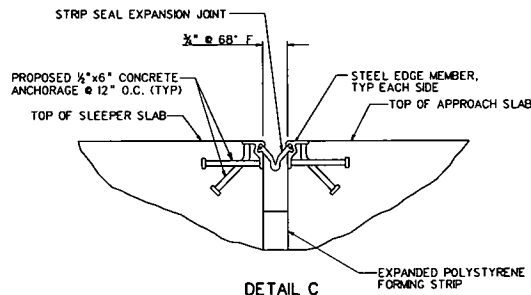


**DETAIL C**  
STRIP SEAL EXPANSION JOINT

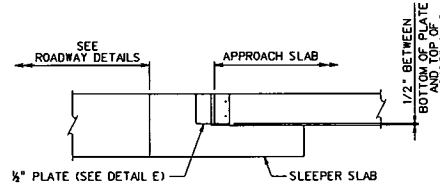


**EXPANSION JOINT**  
STEEL CLOSURE DETAIL

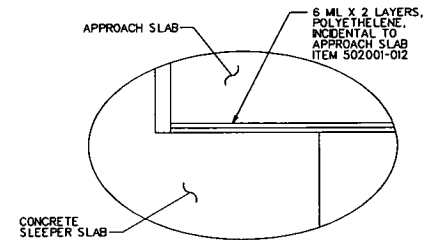

**DETAIL D**

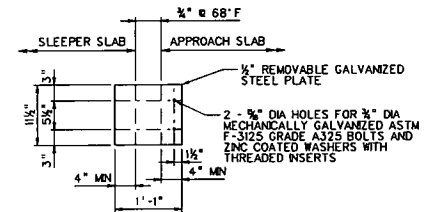

**DETAIL E**  
EXPANSION JOINT END COVER PLATE

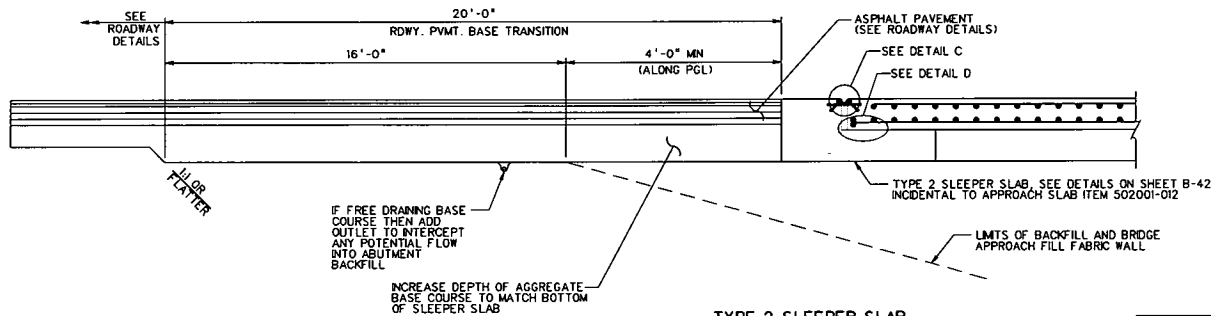

**TYPE 2 SLEEPER SLAB**  
ASPHALT ROADWAY APPROACHES  
NTS

**THRASHER**  
300 ASSOCIATION DRIVE  
CHARLESTON, WV 25311  
www.thrashergrp.com  
PHONE (304)343-7801 FAX (304)343-7904


DESIGNED	DATE
RLC	09/20
DRAWN	SEN
SEN	08/20
CHECKED	RLC
RLC	04/20
CHECKED	

REVISION NUMBER	SHEET NUMBER	REVISION	DATE	BY
DODDRIDGE COUNTY BOARD OF EDUCATION				
<b>DODDRIDGE COUNTY</b> <b>PRE-K</b> <b>ACCESS BRIDGE</b>				
<b>APPROACH SLAB</b> <b>DETAILS 1 OF 2</b>				SHEET B-71 OF B-53 BRIDGE NO. 1797.2


PERMIT NUMBER: \_\_\_\_\_

LOCATION	COUNTY <u>Doddridge</u> ROUTE <u>WV 18</u> MP <u>19.048</u>
	COORDINATES N <u>39.289833</u> SLS, WV, US ROUTE <u>Right</u> W- <u>80.771790</u> ON THE N S <u>(E)</u> W SIDE OF ROAD
APPROACH	DRIVEWAY WIDTH <u>20'</u> GRADE <u>-2</u> % PIPE REQUIRED Y <u>(N)</u> IF YES; SIZE _____
	DRIVEWAY CONSTRUCTION METHOD: STONE ASPHALT <u>(CONCRETE)</u> OTHER: _____
COUNTY ROUTE	SPEED LIMIT <u>25</u> OR SAFE SPEED LIMIT _____ LANE WIDTH <u>11.5 each</u>
	SIGHT DISTANCE <u>(N)</u> E <u>623'</u> <u>4% Downgrade 460' toward SO</u> <u>Before to Park 623' Past to overpass</u>
	SIGHT DISTANCE <u>(S)</u> W <u>460'</u>
NEAREST INTERSECTION	LOCATED <u>0.268</u> MILES <u>(N)</u> S E W OF <u>US 50</u> SLS, WV, US ROUTE
NOTES:	<p>103 Sistersville Pike West Union, WV 26450</p>

*[Handwritten signature]*

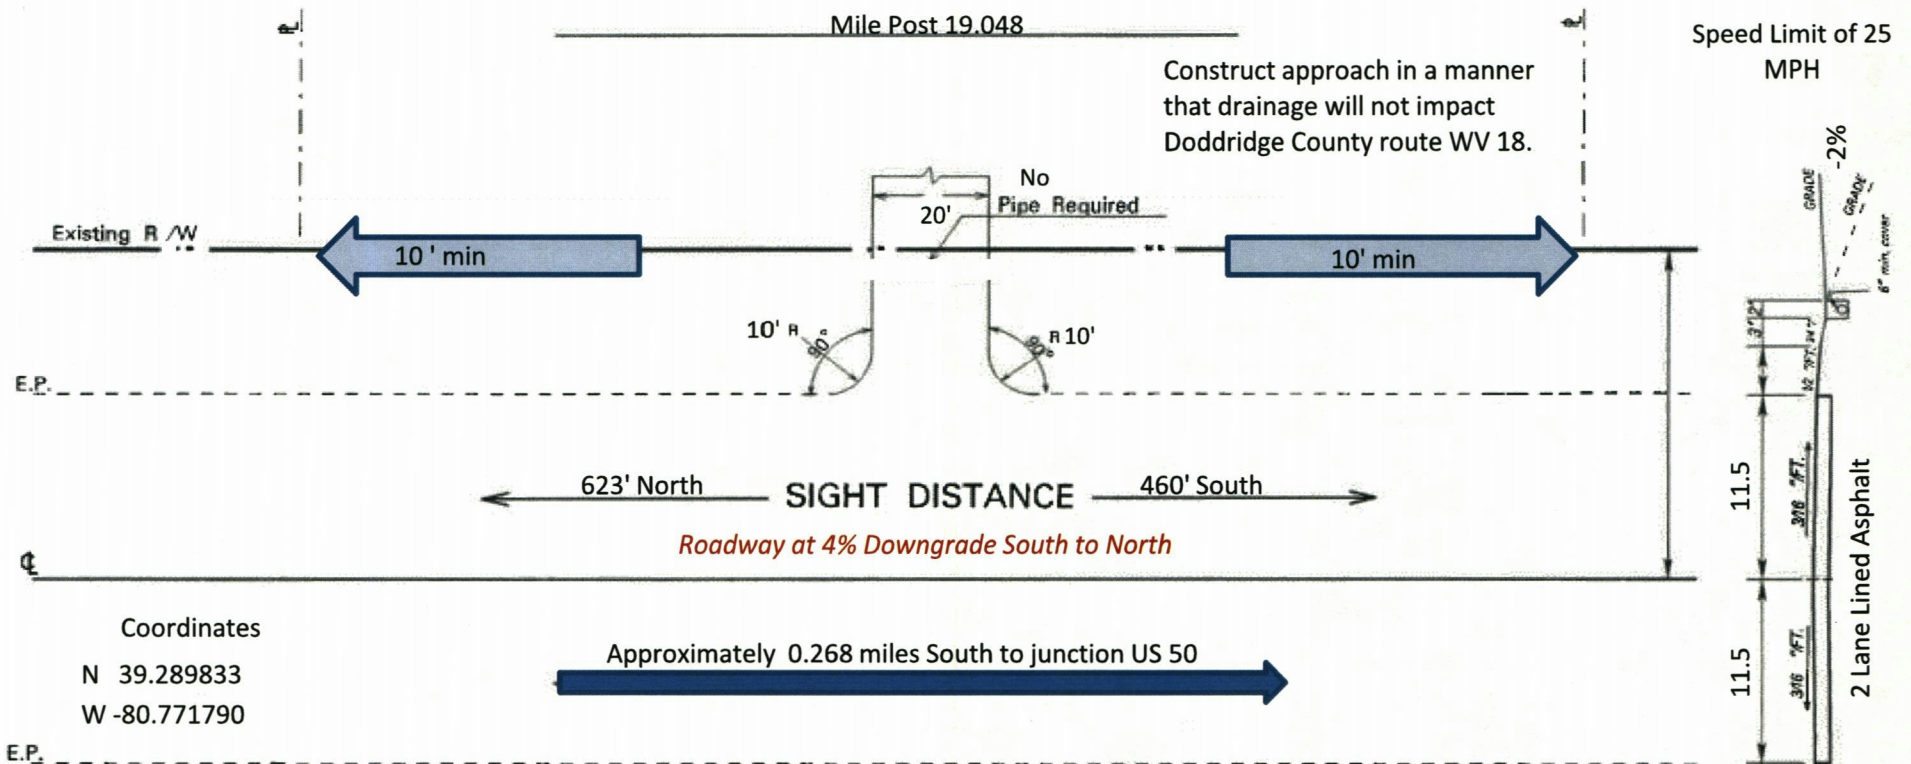

CONSTRUCTION	METHOD
Concrete	
APPLICANT: Doddridge County Board of Education	
ADDRESS: 103 Sistersville Pike West Union, WV 26456	
To construct and maintain a <u>20'</u> approach on the <u>East side of Route WV 18</u> approximately <u>0.268</u> Miles <u>North</u> of Junction Route <u>US 50</u> . Sight distance is <u>623 ft. North</u> and <u>460 ft. South</u> . No drainage vessel required.	
D.O.H. PERMIT #	04-2020-0849
BOND	

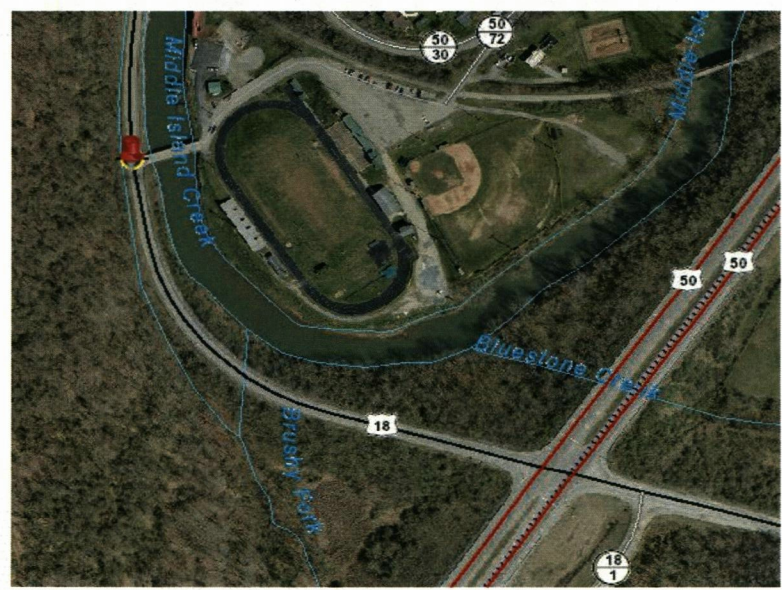





SOUTH





NORTH

David Alexander

PERMIT NUMBER:

LOCATION	COUNTY <u>Doddridge</u> ROUTE <u>WV 18</u> MP <u>19.048</u>
	COORDINATES N <u>39.289833</u> SLS, WV, US ROUTE <u>Right</u> W - <u>80.771790</u> ON THE N S <u>(E)</u> W SIDE OF ROAD
APPROACH	DRIVEWAY WIDTH <u>20'</u> GRADE <u>-2</u> % PIPE REQUIRED Y <u>(N)</u> IF YES; SIZE <u>    </u>
	DRIVEWAY CONSTRUCTION METHOD: STONE ASPHALT <u>(CONCRETE)</u> OTHER: <u>    </u>
COUNTY ROUTE	SPEED LIMIT <u>25</u> OR SAFE SPEED LIMIT <u>    </u> LANE WIDTH <u>11.5 each</u>
	SIGHT DISTANCE <u>(N)</u> E <u>623'</u> <u>4% Downgrade 460' toward 50</u>
	SIGHT DISTANCE <u>(S)</u> W <u>460</u> <u>Before to Post 623' Post to overpass</u>
NEAREST INTERSECTION	LOCATED <u>0.268</u> MILES <u>(N)</u> S E W OF <u>US 50</u> ROUTE <u>50</u>
NOTES:	<u>103 Sistersville Pike West Union, WV 26045</u>

*[Handwritten signature]*

DISTRICT 4  
 DATE 2002  
 TOTAL MILES 26.97


**ORIGINAL**

WEST VIRGINIA DEPARTMENT OF HIGHWAYS  
 PLANNING DIVISION  
 STATE ROUTE STRAIGHT LINE DIAGRAM

COUNTY \_\_\_\_\_  
 ROUTE NO. \_\_\_\_\_  
 SHEET NO. \_\_\_\_\_

PDU. 4-8-02

0.0

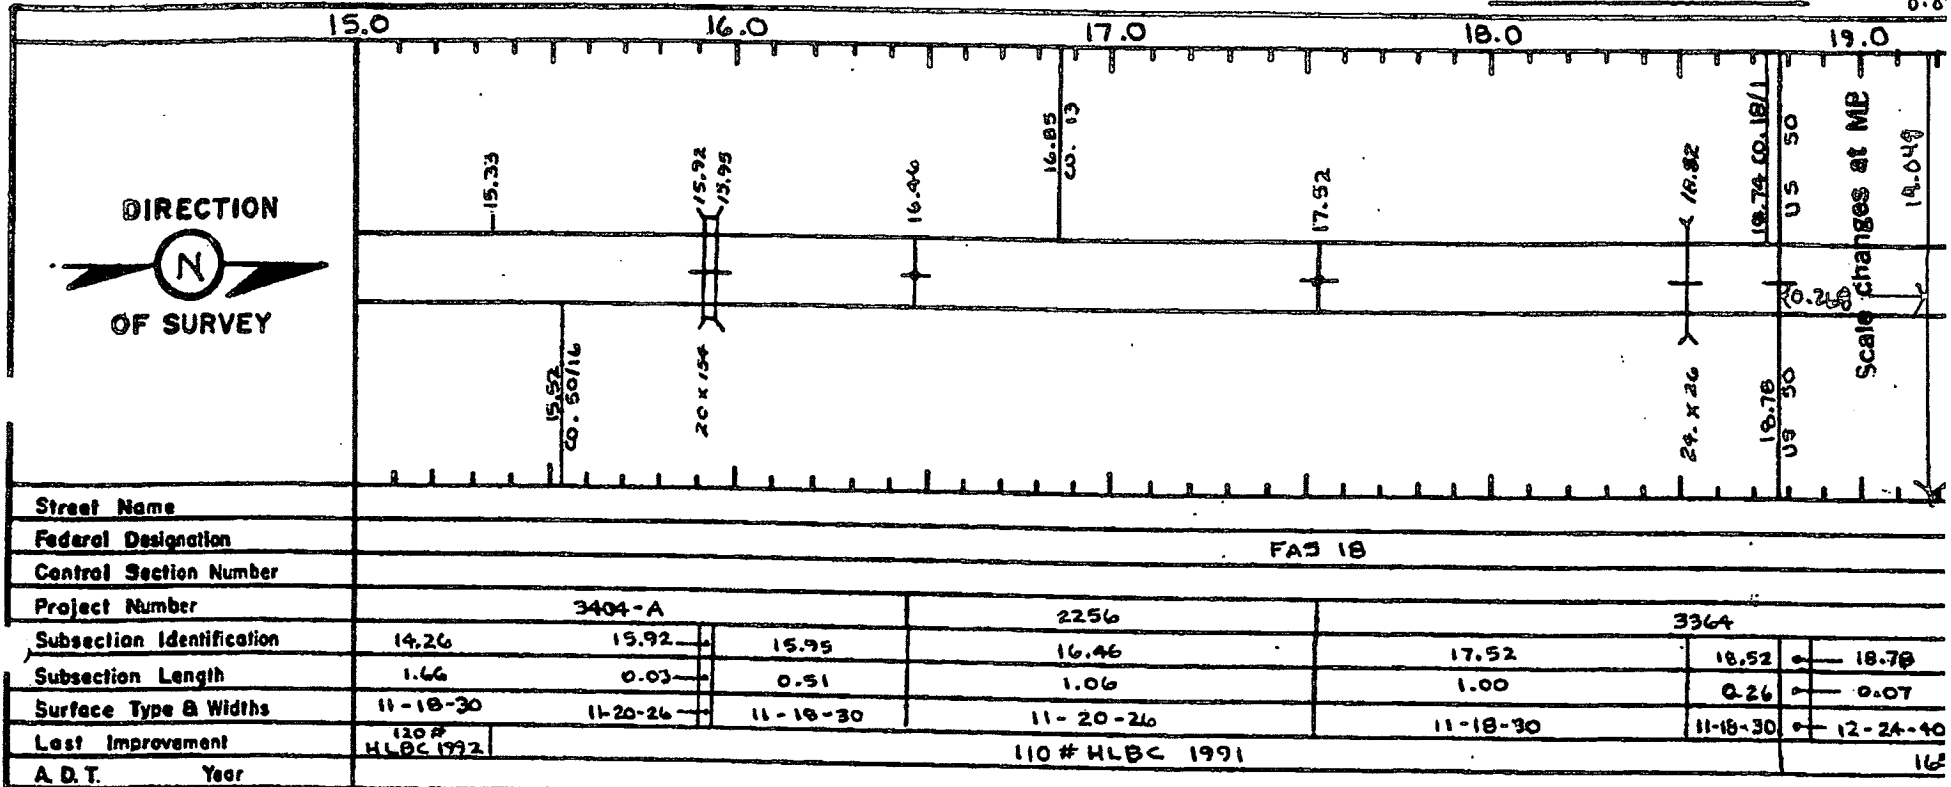

19	
Subsection Identification	
Subsection Length	
Surface Type & Widths	
19	
Subsection Identification	
Subsection Length	
Surface Type & Widths	

# The Doddridge Independent

## The Doddridge Independent PUBLISHER'S CERTIFICATE

I, Michael D. Zorn, Publisher of The Doddridge Independent, A newspaper of general circulation published in the town of West Union, Doddridge County, West Virginia, do hereby certify that:

Please take notice that on the (8th) of (October), 2020, (Doddridge County Board of Education) filed an application for a Floodplain Permit (#20-583) to develop land located at or about (69 C Stansberry Rd); Coordinates: 39.289528, -80.770311. The Application is on file with the Floodplain Manager of the County and may be inspected or copied during regular business hours in accordance to WV Code Chapter 29B Freedom of Information, Article 1 Public Records and county policy and procedures. Any interested persons who desire to comment shall present the same in writing by (November 9, 2020) (20 calendar days after the announcement at the regularly scheduled


was published in The Doddridge Independent  
2 times commencing on Friday, October 16, 2020 and  
Ending on Friday, October 23, 2020 at the request of:

**George Eidel, Doddridge County Floodplain  
Manager & Doddridge County Commission**

Given under my hand this Monday, October 26, 2020


The publisher's fee for said publication is:


**\$ 31.05 1st Run / \$ 23.29 Subsequent Runs /  
This Legal Ad Total: \$ 54.34**

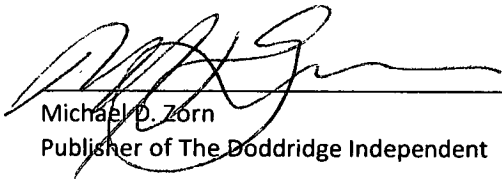  
Michael D. Zorn  
Publisher of The Doddridge Independent

Subscribed to and sworn to before me on

this date: 10/26/20

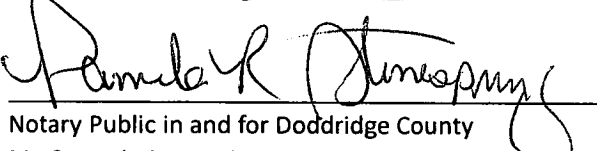  
Notary Public in and for Doddridge County  
My Commission expires on  
The 17th day of May 2024

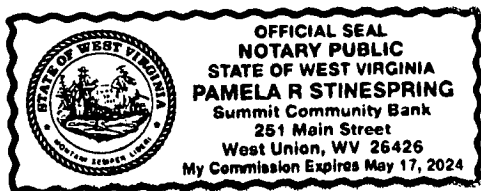

### Floodplain Public Notice • Legal Notice

Please take notice that on the (8th) of (~~October~~), 2020, (Doddridge County Board of Education) filed an application for a Floodplain Permit (#20-583) to develop land located at or about (69 C Stansberry Rd); Coordinates: 39.289528, -80.770311. The Application is on file with the Floodplain Manager of the County and may be inspected or copied during regular business hours in accordance to WV Code Chapter 29B Freedom of Information, Article 1 Public Records and county policy and procedures. Any interested persons who desire to comment shall present the same in writing by (November 9, 2020) (20 calendar days after the announcement at the regularly scheduled Doddridge County Commission Meeting) delivered to the Floodplain Manager of the County at 105 Court Street, Suite #3, West Union, WV 26456. This project is for the Early Childhood Academy project  
C2 10/16 - 10/23

# INVOICE

**The Herald Record LLC**  
177 MAIN STREET  
WEST UNION, WV 26456  
United States

Phone: 304-873-1600  
Fax: 304-666-1017  
Mobile: 304-266-2247  
TheHeraldRecord.com

**Doddridge County OFFICE OF EMERGENCY MANAGEMENT**  
101 Church Street  
West Union, West Virginia 26456  
United States

**Invoice Number:** 2860  
**Invoice Date:** October 21, 2020  
**Payment Due:** October 21, 2020  
**Amount Due (USD):** \$41.24

Items	Quantity	Price	Amount
<b>CLASS II LEGAL AD -- FLOOD PLAIN PERMIT</b> #20-583 -- RUN DATES: 10/4/20 & 10/21/20	1	\$41.24	\$41.24
		<b>Total:</b>	\$41.24
		<b>Amount Due (USD) :</b>	\$41.24


STATE of WEST VIRGINIA;  
COUNTY OF DODDRIDGE, TO WIT:

Doddridge County Floodplain Permits  
(Week of October 12, 2020)

Please take notice that on the (8th) of (OCTOBER), 2020, (DODDRIDGE COUNTY BOARD OF EDUCATION) filed an application for a Floodplain Permit (#20-583) to develop land located at or about (69 C STANSBERRY RD.); Coordinates: 32.289528, -80.770311. The Application is on file with the Floodplain Manager of the County and may be inspected or copied during regular business hours in accordance to WV Code Chapter 29B Freedom of Information, Article 1 Public Records and county policy and procedures. Any interested persons who desire to comment shall present the same in writing by (NOVEMBER 9, 2020) (20 calendar days after the announcement at the regularly scheduled Doddridge County Commission Meeting) delivered to the Floodplain Manager of the County at 105 Court Street, Suite #3, West Union, WV 26456. This project is for the EARLY CHILDHOOD ACADEMY PROJECT.

George C. Eidel, CFM  
Doddridge County Floodplain Manager.

10-14-2xb

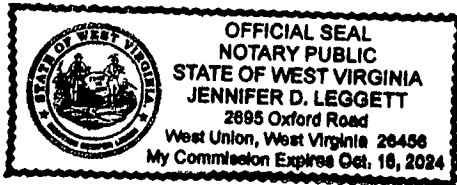

I, Tamela B. Beamer, Editor of THE HERALD RECORD, a certified weekly newspaper published regularly in Doddridge County, West Virginia, DO Hereby Certify Upon Oath that the accompanying Legal Notice entitled:

Doddridge County Floodplain Permit

Permit # 20-583

was published in said paper for 2 successive weeks beginning with the issue of 10/14, 2020 and ending with the issue of 10/21, 2020 that contains 205 word space at 115 cents per word and amounts to the sum of \$ 23.57 FOR THE FIRST PUBLICATION.

SECOND PUBLICATION IS 75% OF THE FIRST PUBLICATION and each other publication thereafter \$ 17.67 for the TOTAL OF: \$ 41.24

Editor,

Tamela B. Beamer

SWORN TO AND SUBSCRIBED BEFORE ME THIS  
THE 21 day of October,  
2020.

NOTARY PUBLIC

Jennifer D. Leggett